

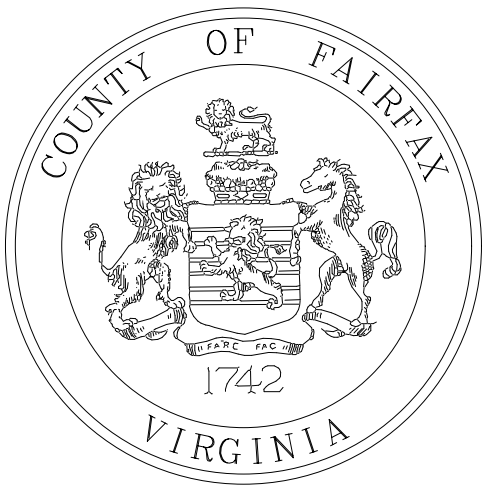
PROJECT MANAGER: SCOTT RUFENER, P.E. (703) 877-5736  
SURVEYED BY: DATE: FAIRFAX COUNTY, NOVEMBER 28, 2014  
DESIGN BY: WHITMAN, REQUARDT & ASSOCIATES, LLP (703) 293-9717  
SUBSURFACE UTILITY BY: DATE: SO, DEEP, INC. (703) 361-6005, DECEMBER 23, 2014

THIS PROJECT WAS DEVELOPED UTILIZING THE DEPARTMENT'S ENGINEERING DESIGN PACKAGE (GEOPAK).  
GEOPAK Computer Identification No. 104294

FOR MAINTENANCE MAP SEE SHEET 1A  
FOR INDEX OF SHEETS SEE SHEET 1B




FHWA 534 DATA 44028



COMMONWEALTH OF VIRGINIA

FAIRFAX COUNTY, VIRGINIA  
DEPARTMENT OF PUBLIC WORKS  
AND ENVIRONMENTAL SERVICES  
PROJECT NO.: 1400102-2013

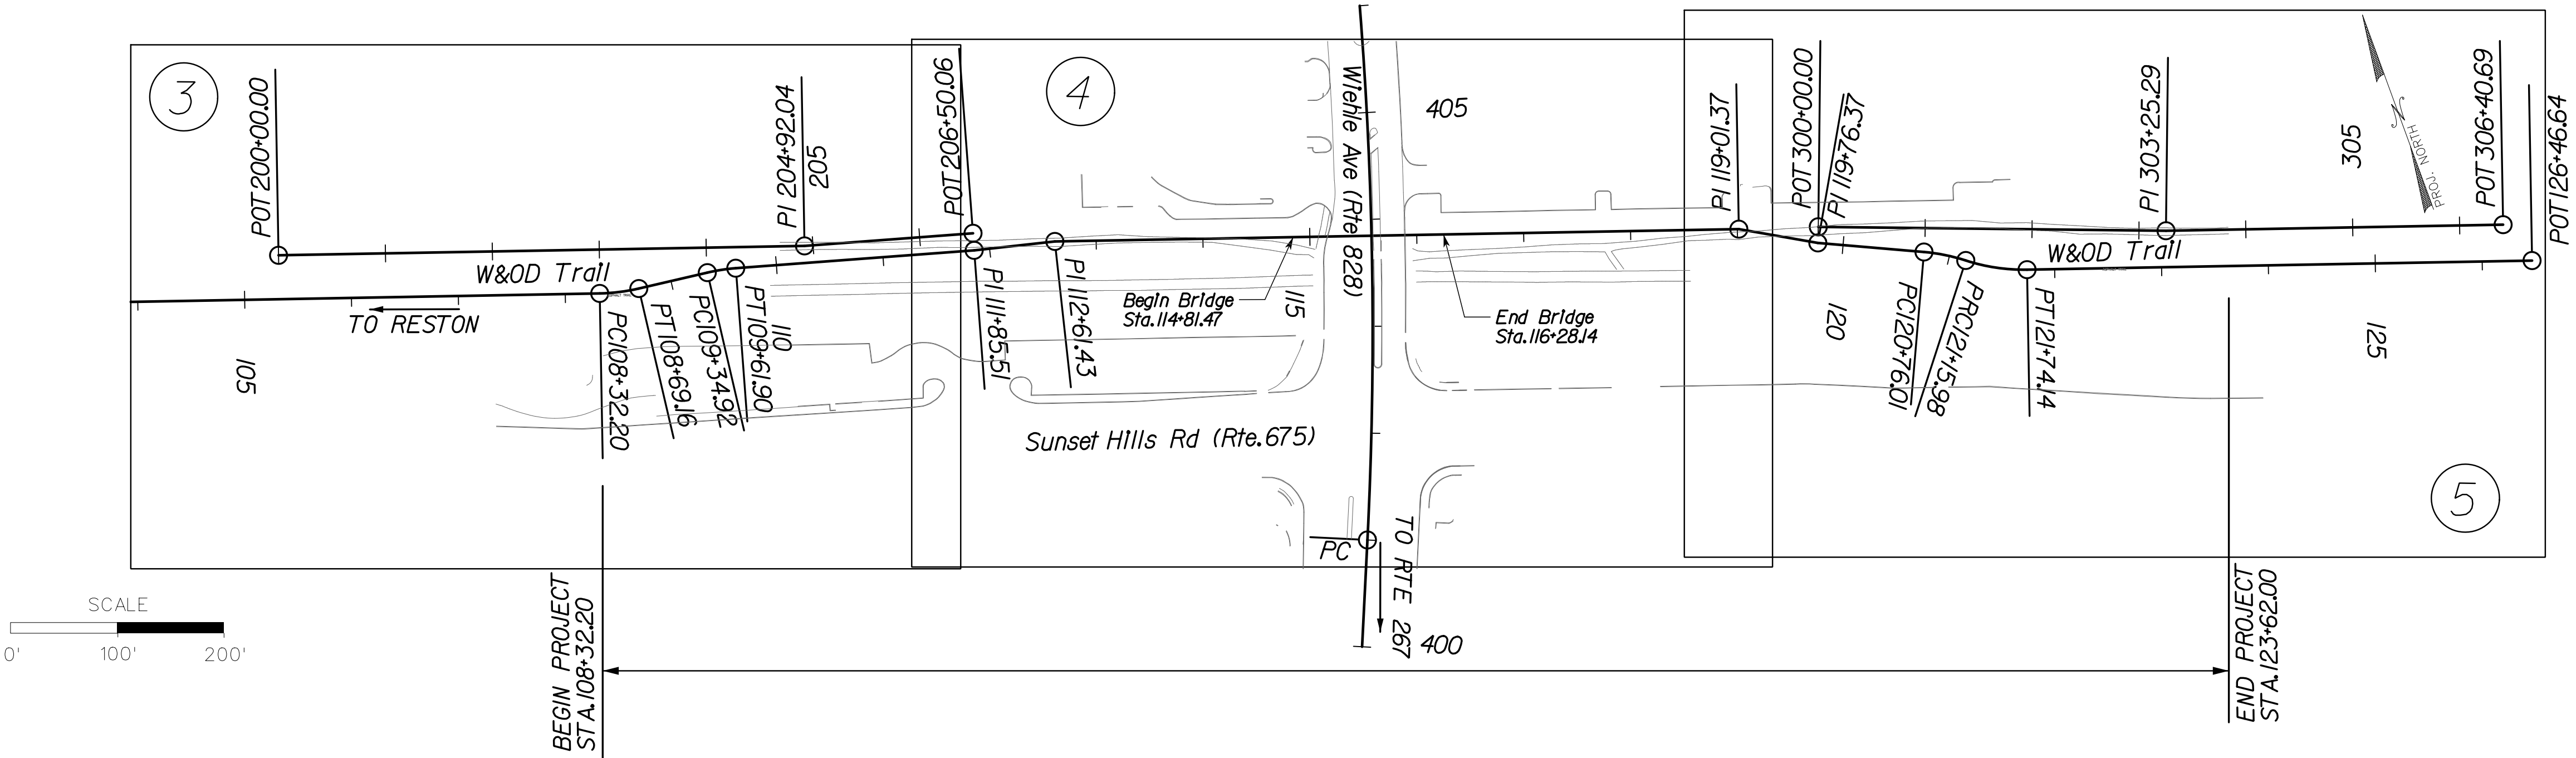UPC NO. 140294 (PE) FUND: 500-C5000  
UPC NO. 107439 (RW,CN) CONTRACT NO.:



DESIGN FEATURES RELATING TO CONSTRUCTION OR TO REGULATION AND CONTROL OF TRAFFIC MAY BE SUBJECT TO CHANGE AS DEEMED NECESSARY BY THE VIRGINIA DEPARTMENT OF TRANSPORTATION

THIS PROJECT IS TO BE CONSTRUCTED IN ACCORDANCE WITH THE DEPARTMENT'S:  
\* ROAD AND BRIDGE SPECIFICATIONS, DATED 2016  
\* ROAD AND BRIDGE STANDARDS, DATED JULY, 2016  
\* VIRGINIA WORK AREA PROTECTION MANUAL, DATED 2011  
AND AS AMENDED BY CONTRACT PROVISIONS AND THE COMPLETE ELECTRONIC PDF VERSION OF THE PLAN ASSEMBLY  
\* MANUAL ON UNIFORM TRAFFIC CONTROL DEVICES (MUTCD), DATED, 2009  
\* VIRGINIA SUPPLEMENT TO THE 2009 MUTCD, DATED 2011

ALL CURVES ARE TO BE SUPERELEVATED, TRANSITIONED AND WIDENED IN ACCORDANCE WITH STANDARD TC-5.11(ULS) EXCEPT WHERE OTHERWISE NOTED.

CENSUS DATA: 2016(YEAR) 1,131,886									
STATE PROJECT NO.	SECTION	FEDERAL AID PROJECT NO.	TYPE CODE	UPC NO.	LENGTH INCLUDING BRIDGE(S)		LENGTH EXCLUDING BRIDGE(S)		TYPE PROJECT
					FEET	MILES	FEET	MILES	
9999-029-098 (PE) 0828-029-248 (RW,CN)	P101	RSTP-5A01(500)	PENG	104294	1530.80	0.290	1384.13	0.262	PREL. ENGR.
	R201		ROWA	107439	1530.80	0.290	1384.13	0.262	RIGHT OF WAY
	C501		CENG	107439	1530.80	0.290	1384.13	0.262	CONSTRUCTION
					PROJECT DESCRIPTION				
					FROM: 0.101 MI E. OF ISAAC NEWTON SQ				
					TO: 0.035 MI W. OF MICHAEL FARADAY CT				

WIEHLE AVENUE AT W&OD TRAIL

STATE	FEDERAL AID	ROUTE	STATE	SHEET NO.
	PROJECT		PROJECT	
VA.	RSTP-5A01( ) SEE TABULATION BELOW FOR SECTION NUMBERS	828	9999-029-098 (PE) 0828-029-248 (RW,CN) SEE TABULATION BELOW FOR SECTION NUMBERS	1

FUNCTIONAL CLASSIFICATION

	WIEHLE AVE (RTE 828)
STREET CLASS	URBAN MINOR ARTERIAL (GS-6)
AADT (2017)	26000
DHV	2,340
D (%)	66
T (%)	3
DESIGN V (mph)	40
POSTED V (mph)	35

PREFINAL PLANS  
MAY 2018

THESE PLANS ARE UNFINISHED AND UNAPPROVED AND ARE NOT TO BE USED FOR ANY TYPE OF CONSTRUCTION.



RECOMMENDED FOR APPROVAL FOR RIGHT OF WAY ACQUISITION	
DATE:	DISTRICT PLANNING AND INVESTMENT MANAGER
DATE:	DISTRICT PROJECT DEVELOPMENT ENGINEER
APPROVED FOR RIGHT OF WAY ACQUISITION	
DATE:	DISTRICT ADMINISTRATOR
RECOMMENDED FOR APPROVAL FOR CONSTRUCTION	
DATE:	DISTRICT PLANNING AND INVESTMENT MANAGER
DATE:	DISTRICT PROJECT DEVELOPMENT ENGINEER
APPROVED FOR CONSTRUCTION	
DATE:	DISTRICT ADMINISTRATOR
FINAL PLANS AUTHORIZED FOR ROW ACQUISITION	
DATE:	CHIEF, TRANSPORTATION DESIGN DIVISION, DOT
FINAL PLANS AUTHORIZED FOR CONSTRUCTION PER DPWES/DOT DELEGATION MATRIX	
DATE:	CHIEF, STORM WATER & TRANSPORTATION CONSTRUCTION BRANCH
DATE:	CHIEF, TRANSPORTATION DESIGN DIVISION

PROJECT NO. 1400102-2013, WIEHLE AVENUE AT W&OD TRAIL  
PREFINAL SUBMISSION MAY 2018







PROJECT MANAGER \_ SCOTT RUEFFNER, P.E., (703) 877-5736 \_ \_ \_ \_ \_  
SURVEYED BY, DATE \_ FAIRFAX COUNTY, NOVEMBER 28, 2014 \_ \_ \_ \_ \_  
DESIGN BY \_ WHITMAN, REQUARDT & ASSOCIATES, LLP, (703) 293-9717 \_ \_ \_  
SUBSURFACE UTILITY BY, DATE \_ SO DEEP, INC., (703) 361-6005, DECEMBER 23, 2014

# INDEX OF SHEETS

SHEET NO.	DESCRIPTION	STATIONS	
I	TITLE SHEET		
IA	LOCATION AND MAINTENANCE MAP		
IB	INDEX OF SHEETS		
IC	RIGHT OF WAY DATA SHEET		
ID	NOT USED		
IE	SURVEY ALIGNMENT DATA SHEET		
IF(1)-IF(2)	CONSTRUCTION ALIGNMENT DATA SHEETS		
IG	UNDERGROUND UTILITY TEST HOLE INFORMATION		
IH(1)-IH(10)	SEQUENCE OF CONSTRUCTION / TRANSPORTATION MANAGEMENT PLAN		
* 2	GENERAL NOTES		
* 2A	GENERAL NOTES - UTILITIES		
2B-2C	TYPICAL SECTIONS		
2D(1)-2D(2)	CURB RAMP DETAIL SHEETS		
2E	INSERTABLE SHEETS		
2F	PROJECT DATA SHEET		
* 2G	AFFIDAVIT OF PHOSPHORUS CREDIT SALE		
2H(1)-2H(2)	STORM SEWER PROFILES AND DRAINAGE DESCRIPTIONS		
3	PLAN SHEET	104+25.00 to 112+00.00	200+00.00 to 206+50.06
3A(1)	W&OD TRAIL PROFILE SHEETS	107+33.38 to 112+00.00	
3A(2)	GRAVEL TRAIL A PROFILE SHEET	202+00.00 to 206+50.06	
3B	EROSION AND SEDIMENT CONTROL PLANS	104+25.00 to 112+00.00	200+00.00 to 206+50.06
4	PLAN SHEET	112+00.00 to 118+75.00	401+25.00 to 406+00.00
4A(1)	W&OD TRAIL PROFILE SHEET	112+00.00 to 118+75.00	
4A(2)	WIEHLE AVE (RTE 828) PROFILE SHEET	401+25.00 to 406+00.00	
4B	EROSION AND SEDIMENT CONTROL PLANS	112+00.00 to 118+75.00	401+25.00 to 406+00.00
5	PLAN SHEET	118+75.00 to 126+46.64	300+00.00 to 306+40.69
5A(1)	W&OD TRAIL PROFILE SHEET	118+75.00 to 126+63.00	
5A(2)	GRAVEL TRAIL B PROFILE SHEET	300+00.00 to 303+75.00	
5B	EROSION AND SEDIMENT CONTROL PLANS	118+75.00 to 126+46.64	300+00.00 to 306+40.69
6(1)-6(29)	BRIDGE PLANS, B-6XX, PLAN NO. XXX-XX (29 SHEETS) W&OD TRAIL OVER WIEHLE AVE. (RTE. 828)		
7(1)-7(5)	SIGNING AND MARKING PLANS		
8(1)-8(2)	SIGNAL PLAN		
9(1)-9(3)	UTILITY PLANS		
10(1)-10(6)	SOLDIER PILE RETAINING WALL DETAIL SHEETS		
100-107	FAIRFAX WATER ADJUSTMENTS		
TOTAL CROSS SECTION SHEETS <u>24</u>			
XS(1)	INDEX OF CROSS SECTION SHEET		
XS(2)-XS(20)	W&OD TRAIL CROSS SECTIONS		
XS(21)-XS(24)	RTE. 828 CROSS SECTIONS		

\* NOT INCLUDED AT THIS STAGE OF PLAN DEVELOPMENT

THESE PLANS ARE UNFINISHED  
AND UNAPPROVED AND ARE NOT  
TO BE USED FOR ANY TYPE  
OF CONSTRUCTION.



EMERGENCY POLICE - FIRE - RESCUE 911							
FAIRFAX COUNTY, VIRGINIA DEPARTMENT OF PUBLIC WORKS AND ENVIRONMENTAL SERVICES 12000 GOVERNMENT CENTER PARKWAY, SUITE 449 FAIRFAX, VA., 22035-0052							
R E V I S I O N S					OFFICE OF CAPITAL FACILITIES 703-324-5800		
					WIEHLE AVENUE (RTE 828) AT W&OD TRAIL INDEX OF SHEETS		
					PROJECT NO: 1400102-2013		
					SCALE	DESIGNED: NDD	SHEET 1B
					NTS	DRAFTED: WRA	
					APPROVED BY THE TRANSPORTATION DESIGN DIVISION		CHECKED: RBH

FUND # 500-C5000



PROJECT MANAGER \_ SCOTT RUEFFNER, P.E., (703) 877-5736 \_ \_ \_ \_ \_  
SURVEYED BY, DATE \_ FAIRFAX COUNTY, NOVEMBER 28, 2014 \_ \_ \_ \_ \_  
DESIGN BY \_ WHITMAN, REQUARDT & ASSOCIATES, LLP, (703) 293-9717 \_ \_ \_  
SUBSURFACE UTILITY BY, DATE \_ SO DEEP, INC., (703) 361-6005, DECEMBER 23, 2014

RIGHT OF WAY DATA SHEET

City/County: FAIRFAX COUNTY

PARCEL NO.	LANDOWNER	TAX MAP NO.	SHEET NO.	AREA (Areas greater than or equal to 1 acre will be shown in acres to 3 decimal places (x.xxx). Areas less than 1 acre will be shown to square feet (x,xxx).)														PROFFERS
				TOTAL	FEE TAKING		PRESCRIPTIVE R/W		FEE REMAINDER		EASEMENTS							
					PERMANENT	UTILITY		TEMPORARY										
				ACRES OR SQUARE FEET	ACRES OR SQ. FEET	HECTARES/ OR SQ. METERS	ACRES OR SQ. FEET	HECTARES/ OR SQ. METERS	ACRES OR SQ. FEET	HECTARES/ OR SQ. METERS	ACRES OR SQ. FEET	HECTARES/ OR SQ. METERS	ACRES OR SQ. FEET	HECTARES/ OR SQ. METERS	ACRES OR SQ. FEET	HECTARES/ OR SQ. METERS	YES / NO	
1	NORTHERN VIRGINIA REGIONAL PARK AUTHORITY	28-3 ((1)) 51	3/4/5	104.215 AC														
2	COMMONWEALTH OF VIRGINIA	17-4 ((1)) 32	3/4	2.079 AC														
3	APA PROPERTIES NO 6 LP	17-4 ((5)) 6S4	3/4	3.586 AC									5,234 SF		6,229 SF		NO	
4	FAIRFAX COUNTY BOARD OF SUPERVISORS	17-4 ((5)) 5	4	1.000 AC									4,865 SF		3,785 SF		NO	
6	SPIRIT MASTER FUNDING III, LLC	17-4 ((15)) (5) 3A	4	26,428 SF	370 SF				26,058 SF		569 SF		3,795 SF		8,911 SF		NO	
7	MCDONALDS CORP.	17-4 ((15)) (5) A	4	10,152 SF							72 SF		449 SF		113 SF		NO	
8	DAVID W TR BALILES	17-4 ((15)) (5) 4	4/5	37,859 SF							322 SF		2,008 SF		502 SF		NO	
9	COMMONWEALTH OF VIRGINIA	17-4 ((1)) 17	4/5	1.506 AC														
10	LEIDOS REALTY, LLC	17-4 ((15)) 4	5	2.734 AC							365 SF		5,513 SF		1,927 SF		NO	
11	PCM PROPERTIES LLC	18-3 ((5)) 6	5	2.314 AC									1,180 SF		463 SF		NO	

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EMERGENCY POLICE - FIRE - RESCUE 911					
FAIRFAX COUNTY, VIRGINIA					
DEPARTMENT OF PUBLIC WORKS AND ENVIRONMENTAL SERVICES					
12000 GOVERNMENT CENTER PARKWAY, SUITE 449 FAIRFAX, VA., 22035-0052					
REVISIONS					OFFICE OF CAPITAL FACILITIES 703-324-5800
PROJECT NO: 1400102-2013					
N	SCALE	DESIGNED: NDD		SHEET	
	NTS	DRAFTED: WRA			
	CHECKED: RBH				
APPROVED BY THE TRANSPORTATION DESIGN DIVISION					



# SURVEY ALIGNMENT DATA SHEET

FUND # 500-C5000

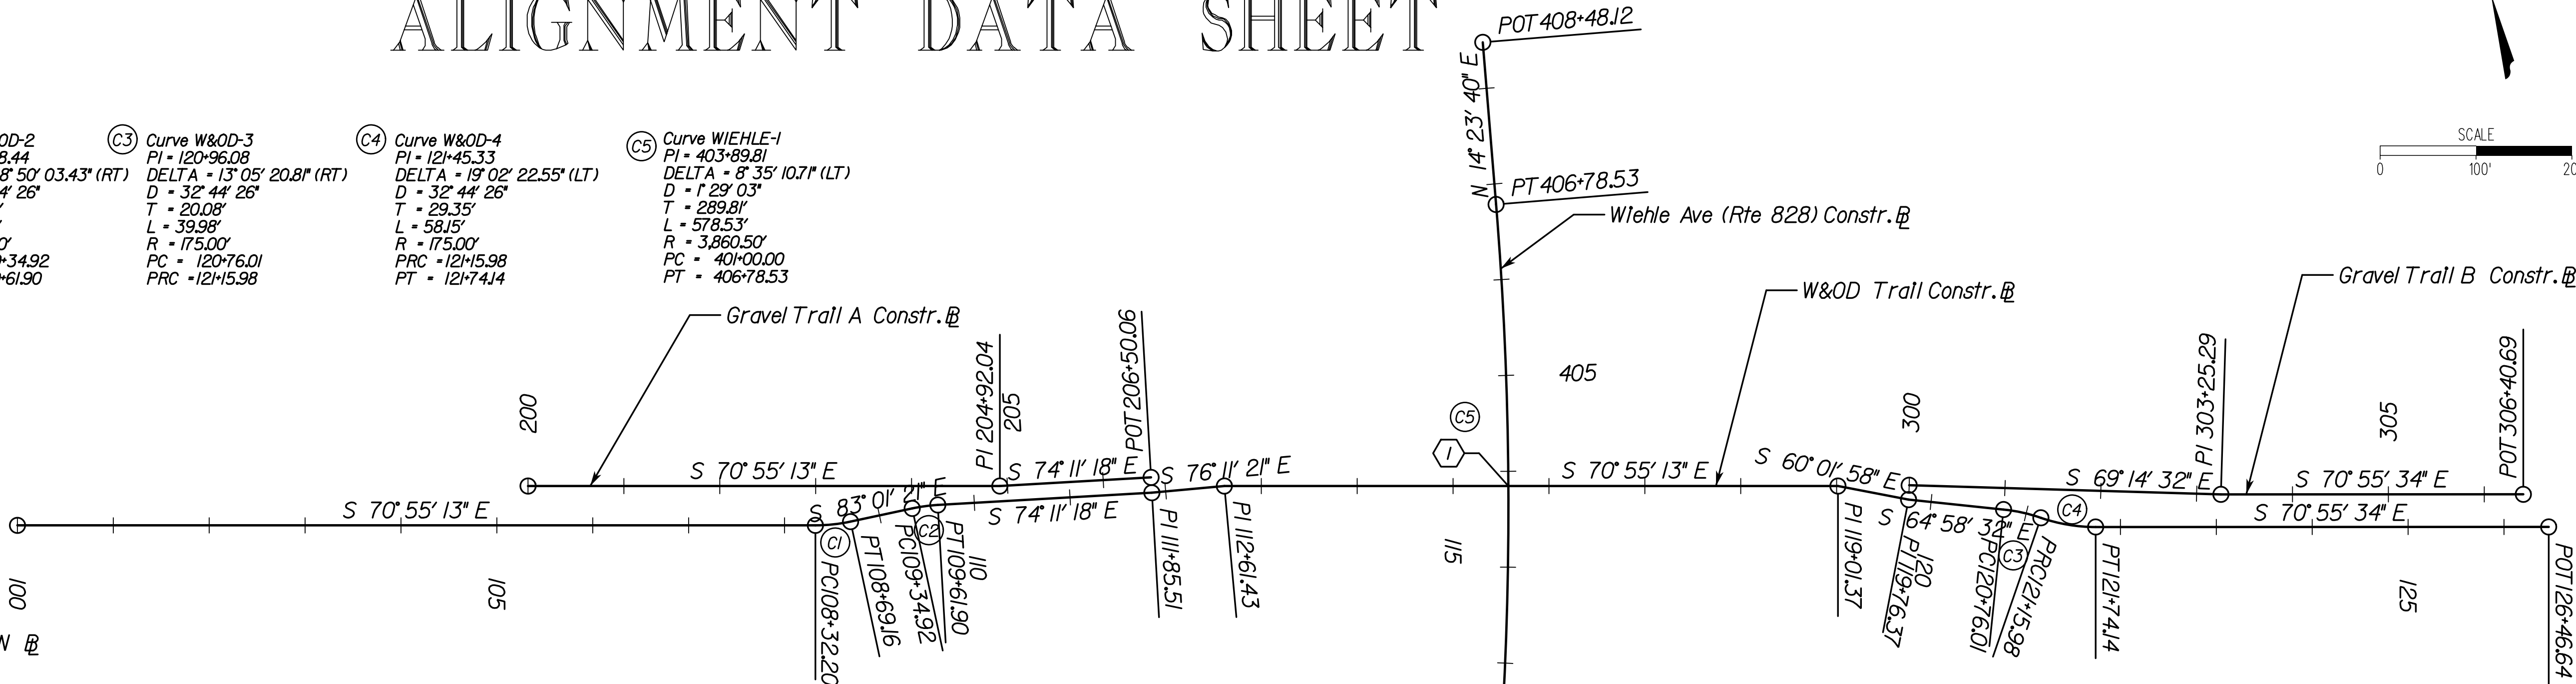


PROJECT MANAGER: SCOTT RUEFFNER, P.E., (703) 871-5736  
SURVEYED BY, DATE: FAIRFAX COUNTY, NOVEMBER 28, 2014  
DESIGN BY: WHITMAN, REQUARDT & ASSOCIATES, LLP, (703) 293-9717  
SUBSURFACE UTILITY BY, DATE: SO DEEP, INC., (703) 361-6005, DECEMBER 23, 2014

# TRAIL CONSTRUCTION ALIGNMENT DATA SHEET

- (C1) Curve W&OD-1  
PI = 108+50.75  
DELTA = 12° 06' 08.46" (LT)  
D = 32° 44' 26"  
T = 18.55'  
L = 36.96'  
R = 175.00'  
PC = 108+32.20  
PT = 108+69.16
- (C2) Curve W&OD-2  
PI = 109+48.44  
DELTA = 8° 50' 03.43" (RT)  
D = 32° 44' 26"  
T = 13.52'  
L = 26.98'  
R = 175.00'  
PC = 109+34.92  
PT = 109+61.90
- (C3) Curve W&OD-3  
PI = 120+96.08  
DELTA = 13° 05' 20.81" (RT)  
D = 32° 44' 26"  
T = 20.08'  
L = 39.98'  
R = 175.00'  
PC = 120+76.01  
PT = 121+15.98
- (C4) Curve W&OD-4  
PI = 121+45.33  
DELTA = 19° 02' 22.55" (LT)  
D = 32° 44' 26"  
T = 29.35'  
L = 58.15'  
R = 175.00'  
PC = 121+15.98  
PT = 121+74.14
- (C5) Curve WIEHLE-1  
PI = 403+89.81  
DELTA = 8° 35' 10.71" (LT)  
D = 1° 29' 03"  
T = 289.81'  
L = 578.53'  
R = 3,860.50'  
PC = 401+00.00  
PT = 406+78.53

- (1) Sta. 115+57.68 W&OD TRAIL @  
Sta. 403+84.62 WIEHLE AVE. @  
△ = 89° 40' 36"



## W&OD TRAIL CONSTRUCTION @

Chain W&OD contains:  
WOD01 CUR W&OD-1 CUR W&OD-2 WOD02 WOD03 WOD04 WOD05 CUR W&OD-3 CUR W&OD-4 WOD06

Beginning chain W&OD description

Point WOD01 N 7,031,786.85 E 11,812,546.63 Sta 100+00.00

Course from WOD01 to PC W&OD-1 S 70° 55' 12.71" E Dist 832.20

Curve Data			
(C1)	Curve W&OD-1		
P.I. Station	108+50.75 N	7,031,508.76 E	11,813,350.65
Delta	= 12° 06' 08.46" (LT)		
Degree	= 32° 44' 25.60"		
Tangent	= 18.55		
Length	= 36.96		
Radius	= 175.00		
External	= 0.98		
Long Chord	= 36.90		
Mid. Ord.	= 0.98		
P.C. Station	108+32.20 N	7,031,514.82 E	11,813,333.11
P.T. Station	108+69.16 N	7,031,506.50 E	11,813,369.06
C.C.	N 7,031,680.21 E	11,813,390.32	
Back	= S 70° 55' 12.71" E		
Ahead	= S 83° 01' 21.17" E		
Chord Bear	= S 76° 58' 16.94" E		

Course from PT W&OD-1 to PC W&OD-2 S 83° 01' 21.17" E Dist 65.76

Curve Data			
(C2)	Curve W&OD-2		
P.I. Station	109+48.44 N	7,031,496.87 E	11,813,447.75
Delta	= 8° 50' 03.43" (RT)		
Degree	= 32° 44' 25.60"		
Tangent	= 13.52		
Length	= 26.98		
Radius	= 175.00		
External	= 0.52		
Long Chord	= 26.96		
Mid. Ord.	= 0.52		
P.C. Station	109+34.92 N	7,031,498.51 E	11,813,434.33
P.T. Station	109+61.90 N	7,031,493.19 E	11,813,460.76
C.C.	N 7,031,324.81 E	11,813,413.07	
Back	= S 83° 01' 21.17" E		
Ahead	= S 74° 11' 17.74" E		
Chord Bear	= S 78° 36' 19.45" E		

Course from PT W&OD-2 to WOD02 S 74° 11' 17.74" E Dist 223.60

Point WOD02 N 7,031,432.26 E 11,813,675.90 Sta 111+85.51

Course from WOD02 to WOD03 S 76° 11' 20.50" E Dist 75.92

Point WOD03 N 7,031,414.14 E 11,813,749.63 Sta 112+61.43

Course from WOD03 to WOD04 S 70° 55' 12.71" E Dist 639.94

Point WOD04 N 7,031,204.95 E 11,814,354.41 Sta 119+01.37

Course from WOD04 to WOD05 S 60° 01' 58.43" E Dist 74.99

Point WOD05 N 7,031,167.49 E 11,814,419.38 Sta 119+76.37

Course from WOD05 to PC W&OD-3 S 64° 58' 32.34" E Dist 99.64

Curve Data			
(C3)	Curve W&OD-3		
P.I. Station	120+96.08 N	7,031,116.85 E	11,814,527.86
Delta	= 13° 05' 20.81" (RT)		
Degree	= 32° 44' 25.60"		
Tangent	= 20.08		
Length	= 39.98		
Radius	= 175.00		
External	= 1.15		
Long Chord	= 39.89		
Mid. Ord.	= 1.14		
P.C. Station	120+76.01 N	7,031,125.34 E	11,814,509.67
P.T. Station	121+15.98 N	7,031,104.46 E	11,814,543.66
C.C.	N 7,030,966.77 E	11,814,435.64	
Back	= S 64° 58' 32.34" E		
Ahead	= S 51° 53' 11.53" E		
Chord Bear	= S 58° 25' 51.94" E		

Curve Data			
(C4)	Curve W&OD-4		
P.I. Station	121+45.33 N	7,031,086.34 E	11,814,566.75
Delta	= 19° 02' 22.55" (LT)		
Degree	= 32° 44' 25.60"		
Tangent	= 29.35		
Length	= 58.15		
Radius	= 175.00		
External	= 2.44		
Long Chord	= 57.89		
Mid. Ord.	= 2.41		
P.C. Station	121+15.98 N	7,031,104.46 E	11,814,543.66
P.T. Station	121+74.14 N	7,031,076.75 E	11,814,594.48
C.C.	N 7,031,242.15 E	11,814,651.67	
Back	= S 51° 53' 11.53" E		
Ahead	= S 70° 55' 34.08" E		
Chord Bear	= S 61° 24' 22.81" E		

Course from PT W&OD-4 to WOD06 S 70° 55' 34.08" E Dist 472.50

Point WOD06 N 7,030,922.35 E 11,815,041.04 Sta 126+46.64

Ending chain W&OD description

## WIEHLE AVE (RTE 820) CONSTRUCTION @

Chain WIEHLE contains:  
WA01 CUR WIEHLE-1 WA02

Beginning chain WIEHLE description

Point WA01 N 7,030,959.34 E 11,813,889.19 Sta 400+00.00

Course from WA01 to PC WIEHLE-1 N 22° 58' 50.33" E Dist 100.00

Curve Data			
(C5)	Curve WIEHLE-1		
P.I. Station	403+89.81 N	7,031,318.21 E	11,814,041.38
Delta	= 8° 35' 10.71" (LT)		
Degree	= 1° 29' 02.96"		
Tangent	= 289.81		
Length	= 578.53		
Radius	= 3,860.50		
External	= 10.86		
Long Chord	= 577.99		
Mid. Ord.	= 10.83		
P.C. Station	401+00.00 N	7,031,051.41 E	11,813,928.24
P.T. Station	406+78.53 N	7,031,598.92 E	11,814,113.43
C.C.	N 7,032,558.62 E	11,810,374.12	
Back	= N 22° 58' 50.33" E		
Ahead	= N 14° 23' 39.63" E		
Chord Bear	= N 18° 41' 14.98" E		

Course from PT WIEHLE-1 to WA02 N 14° 23' 39.63" E Dist 169.58

Point WA02 N 7,031,763.18 E 11,814,155.59 Sta 408+48.12

Ending chain WIEHLE description

## GRAVEL TRAIL A CONSTRUCTION @

Chain GRAVELA contains:  
GA01 GA02 GA03

Beginning chain GRAVELA description

Point GA01 N 7,031,651.52 E 11,813,063.31 Sta 200+00.00

Course from GA01 to GA02 S 70° 55' 12.71" E Dist 492.04

Point GA02 N 7,031,490.68 E 11,813,528.32 Sta 204+92.04

Course from GA02 to GA03 S 74° 11' 17.74" E Dist 158.02

Point GA03 N 7,031,447.63 E 11,813,680.36 Sta 206+50.06

Ending chain GRAVELA description

## GRAVEL TRAIL B CONSTRUCTION @

Chain GRAVELB contains:  
GB01 GB02 GB03

Beginning chain GRAVELB description

Point GB01 N 7,031,181.48 E 11,814,424.90 Sta 300+00.00

Course from GB01 to GB02 S 69° 14' 31.62" E Dist 325.29

Point GB02 N 7,031,066.19 E 11,814,729.07 Sta 303+25.29

Course from GB02 to GB03 S 70° 55' 34.08" E Dist 315.40

Point GB03 N 7,030,963.12 E 11,815,027.15 Sta 306+40.69

Ending chain GRAVELB description



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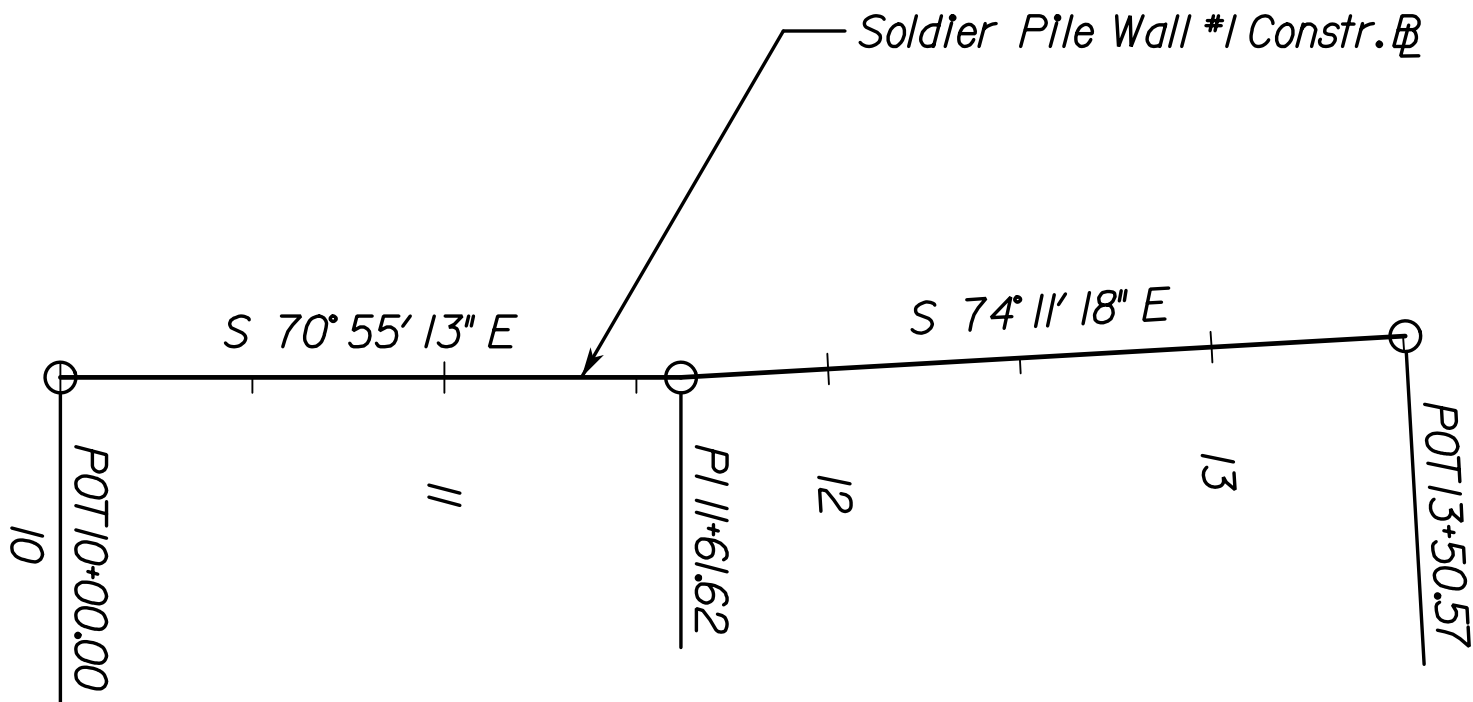
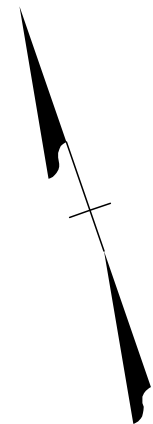
EMERGENCY POLICE - FIRE - RESCUE 911				
FAIRFAX COUNTY, VIRGINIA				
DEPARTMENT OF PUBLIC WORKS AND ENVIRONMENTAL SERVICES				
12000 GOVERNMENT CENTER PARKWAY, SUITE 449 FAIRFAX, VA., 22035-0052				
OFFICE OF CAPITAL FACILITIES 703-324-5800				
WIEHLE AVENUE (RTE 828) AT W&OD TRAIL CONSTRUCTION ALIGNMENT DATA SHEET PROJECT NO: 1400102-2013				
SCALE 1"=100'		DESIGNED: NDD DRAFTED: WRA CHECKED: RBH		SHEET 1F(1)
APPROVED BY THE TRANSPORTATION DESIGN DIVISION				

FUND # 500-C5000



PROJECT MANAGER \_ SCOTT RUEFFNER, P.E., (703) 877-5736 \_  
SURVEYED BY, DATE \_ FAIRFAX COUNTY, NOVEMBER 28, 2014 \_  
DESIGN BY \_ WHITMAN, REQUARDT & ASSOCIATES, LLP, (703) 293-9717 \_  
SUBSURFACE UTILITY BY, DATE \_ SO DEEP, INC., (703) 361-6005, DECEMBER 23, 2014

# RETAINING WALL CONSTRUCTION ALIGNMENT DATA SHEET



### Soldier Pile Wall #1 Constr.

Chain RW-1 contains:  
RW10 RW11 RW12

Beginning chain RW-1 description

Point RW10      N    7,031,544.25 E    11,813,343.64 Sta    10+00.00

Course from RW10 to RW11 S 70° 55' 12.71" E Dist 161.62

Point RW11      N    7,031,491.41 E    11,813,496.39 Sta    11+61.62

Course from RW11 to RW12 S 74° 11' 17.74" E Dist 188.94

Point RW12      N    7,031,439.93 E    11,813,678.18 Sta    13+50.57

Ending chain RW-1 description

### MSE Wall #2 Constr.

Chain RW-2 contains:  
RW20 RW21

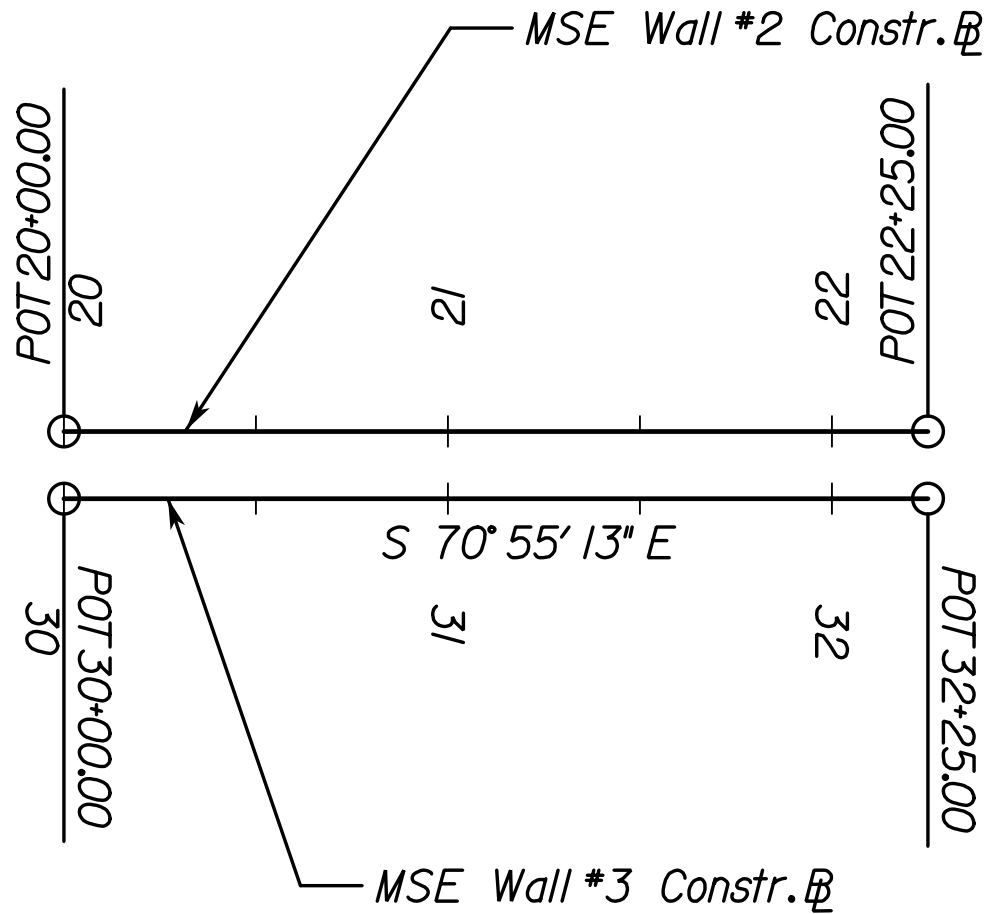
Beginning chain RW-2 description

Point RW20      N    7,031,417.73 E    11,813,765.23 Sta    20+00.00

Course from RW20 to RW21 S 70° 55' 12.71" E Dist 225.00

Point RW21      N    7,031,344.19 E    11,813,977.87 Sta    22+25.00

Ending chain RW-2 description



### MSE Wall #3 Constr.

Chain RW-3 contains:  
RW30 RW31

Beginning chain RW-3 description

Point RW30      N    7,031,401.20 E    11,813,759.51 Sta    30+00.00

Course from RW30 to RW31 S 70° 55' 12.71" E Dist 225.00

Point RW31      N    7,031,327.65 E    11,813,972.15 Sta    32+25.00

Ending chain RW-3 description

### MSE Wall #4 Constr.

Chain RW-4 contains:  
RW40 RW41 RW42 RW43

Beginning chain RW-4 description

Point RW40      N    7,031,311.50 E    11,814,072.38 Sta    40+00.00

Course from RW40 to RW41 S 70° 55' 12.70" E Dist 300.80

Point RW41      N    7,031,213.17 E    11,814,356.66 Sta    43+00.80

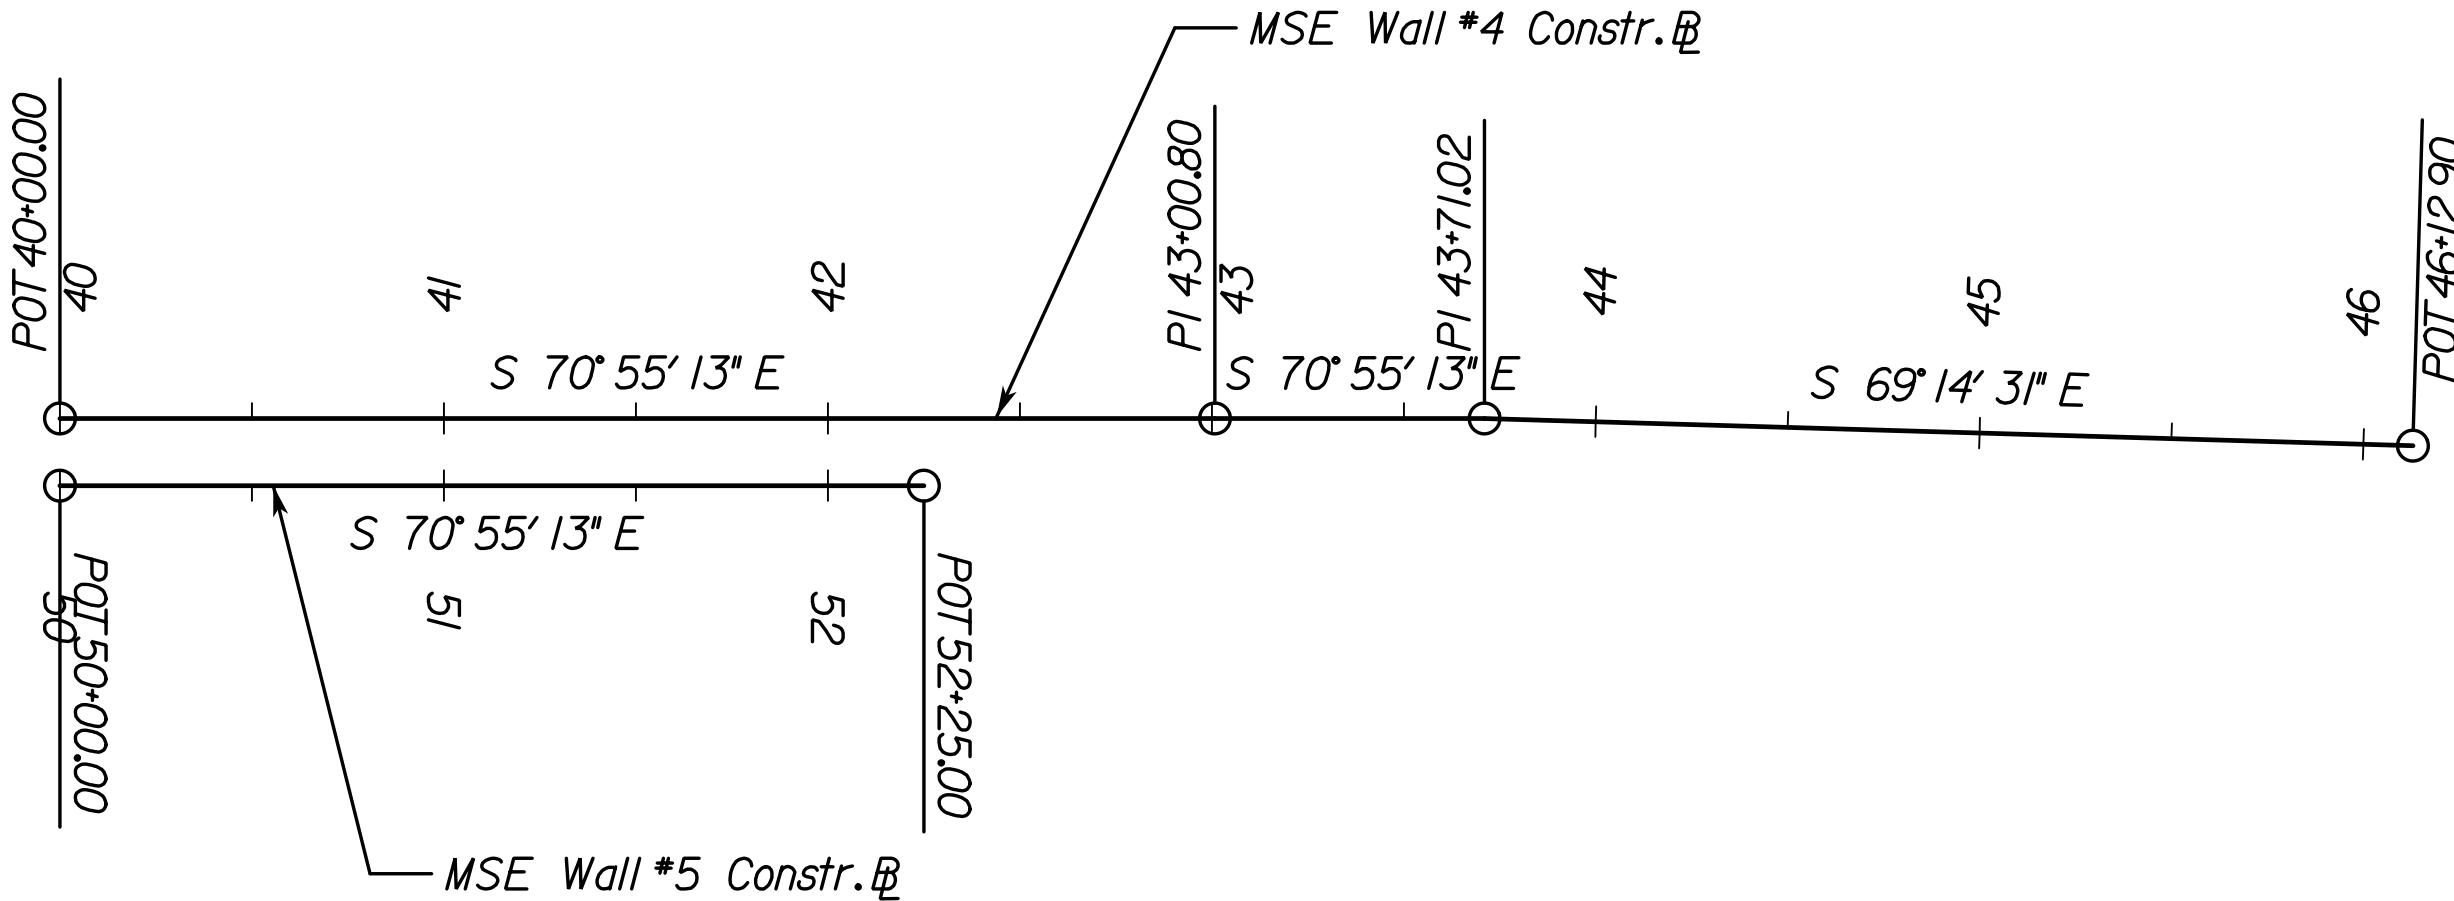
Course from RW41 to RW42 S 70° 55' 12.72" E Dist 70.21

Point RW42      N    7,031,190.22 E    11,814,423.01 Sta    43+71.02

Course from RW42 to RW43 S 69° 14' 31.42" E Dist 241.88

Point RW43      N    7,031,104.49 E    11,814,649.19 Sta    46+12.90

Ending chain RW-4 description



### MSE Wall #5 Constr.

Chain RW-5 contains:  
RW50 RW51

Beginning chain RW-5 description

Point RW50      N    7,031,294.96 E    11,814,066.66 Sta    50+00.00

Course from RW50 to RW51 S 70° 55' 12.71" E Dist 225.00

Point RW51      N    7,031,221.41 E    11,814,279.30 Sta    52+25.00

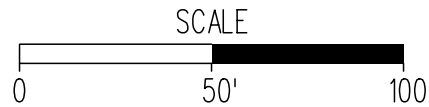
Ending chain RW-5 description

#### NOTES

- FOR SOLDIER PILE WALL BEGIN AND END STATIONS, SEE SHEET 10(2).
- FOR MSE WALL BEGIN AND END STATIONS, SEE SHEETS 6(24) - 6(25).



THESE PLANS ARE UNFINISHED  
AND UNAPPROVED AND ARE NOT  
TO BE USED FOR ANY TYPE  
OF CONSTRUCTION.



EMERGENCY POLICE - FIRE - RESCUE 911									
FAIRFAX COUNTY, VIRGINIA									
DEPARTMENT OF PUBLIC WORKS AND ENVIRONMENTAL SERVICES									
12000 GOVERNMENT CENTER PARKWAY, SUITE 449 FAIRFAX, VA., 22035-0052									
R E V I S I O N S						OFFICE OF CAPITAL FACILITIES 703-324-5800			
							WIEHLE AVENUE (RTE 828) AT W&OD TRAIL WALL ALIGNMENT DATA SHEET		
							PROJECT NO: 1400102-2013		
							SCALE 1"=50'	DESIGNED: NDD DRAFTED: WRA CHECKED: RBH	SHEET 1F(2)
							APPROVED BY THE TRANSPORTATION DESIGN DIVISION		



PROJECT MANAGER \_ SCOTT RUEFFNER, P.E., (703) 871-5736 \_ \_ \_ \_ \_  
SURVEYED BY, DATE \_ FAIRFAX COUNTY, NOVEMBER 28, 2014 \_ \_ \_ \_ \_  
DESIGN BY \_ WHITMAN, REQUARDT & ASSOCIATES, LLP, (703) 293-9717 \_ \_ \_  
SUBSURFACE UTILITY BY, DATE \_ SO DEEP, INC., (703) 361-6005, DECEMBER 23, 2014

UNDERGROUND UTILITY TEST HOLE INFORMATION

PLAN SHEET	TEST HOLE	OFFSET (FT)	STATION	OWNER	TYPE OF FACILITY	ELEV.
3	1	25.85 LT	110+06.04	PCCP	30" WATER LINE	388.18'
3	2	7.99 LT	110+67.11	LEVEL 3	(3) 1 3/4" FO CONDUIT	389.18'
3	3	4.25 RT	113+22.75	LEVEL 3	(3) 1 3/4" FO CONDUIT	385.03'
4	4	39.83 LT	404+12.71		3" CATV CONDUIT	379.65'
4	5	38.40 LT	404+11.33	LEVEL 3	(4) 2" FO CONDUIT	371.50'
4	6	35.01 LT	404+08.96	LEVEL 3	(2) 2" PLASTIC CONDUIT	378.47'
4	7	39.62 RT	404+09.67	COX LEVEL 3	(2) 2 1/2" CONDUIT (2) 2" CONDUIT 2.16' RPC DUCT 4 1/2" TELEPHONE CONDUIT	380.49'
4	10	7.11 RT	404+10.59		12 3/4" D.I. WATER LINE	372.42'
4	11	33.69 RT	404+07.31	VERIZON BUSINESS	(4) 1 1/2" FO CONDUIT	379.34'
4	12	26.11 RT	404+10.02		8 1/2" PLASTIC GAS LINE	374.46'
4	13	45.49 RT	404+09.61		(3) 2" ELECTRIC CABLE	381.12'
4	14	57.78 RT	404+09.55		(3) 2 1/4" ELECTRIC CABLE	377.68'
4	15	61.42 LT	403+84.53	COMCAST	(3) 1 3/4" FO CONDUIT	378.80'
4	16	38.08 RT	114+25.53		(3) 2" ELECTRIC CABLE	375.92'
4	17	48.78 RT	114+39.48	AT&T	4/12" FO CONDUIT	376.16'
4	18	49.24 LT	402+90.64	LEVEL 3	(4) 2" FO CONDUIT	373.02'
4	19	51.70 LT	402+90.87	NOT IDENTIFIED	1/2" CATV (3) 3/4" CATV (3) 1" CATV (2) CATV	377.55'
4	20	53.08 LT	402+90.87	LEVEL 3	(7+) FO CONDUIT	376.79'
4	21	56.58 LT	402+90.81	COX TRAFFIC CONTROL COMCAST LEVEL 3	(2) 2 1/2" FO CONDUIT 3 1/2" CONDUIT (3) 1 3/4" CONDUIT (2) 2" FO CONDUIT	379.00'
4	22	57.90 LT	402+87.68	LEVEL 3	4 1/2" FO CONDUIT	379.68'
4	23	73.59 LT	402+56.32		2 1/4" ELECTRIC CONDUIT	380.54'
4	24	23.43 RT	402+88.24	COX	2 1/2" FO CONDUIT 8 1/2" PLASTIC GAS LINE	375.46'
4	25	38.52 RT	402+88.72	LEVEL 3 ZAYO	(8) 2" FO CONDUIT (4) 2" FO CONDUIT	377.54'
4	26	41.18 RT	402+89.06		1.62' RPC DUCT (2) TELEPHONE CONDUIT	377.33'
4	27	43.01 RT	402+88.71	VERIZON BUSINESS COX	(4) 1 1/2" FO CONDUIT 2 1/2" FO CONDUIT	376.96'
4	28	45.37 RT	402+78.83	CENTURYLINK COX	HAND HOLE 2 1/2" FO CONDUIT	378.40'
4	29	58.97 RT	402+73.31	COMCAST	(3) 1 3/4" FO CONDUIT 4 1/2" PLASTIC CONDUIT	376.14'
5	30	8.03 RT	119+12.33	LEVEL 3	(3) 1 3/4" FO CONDUIT	368.12'
5	31	29.95 LT	119+07.25	VERIZON VERIZON	4 1/2" FO CONDUIT 2 1/4" CABLE	371.82'
5	32	73.70 LT	121+68.10	VERIZON VERIZON	4 1/2" FO CONDUIT 2 1/4" CABLE	358.85'
5	33	51.04 LT	123+79.55	PCCP	30" WATER LINE	365.17'
4	34	35.80 RT	404+09.66	ZAYO	(4) 2" FO CONDUIT	378.53'



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EMERGENCY POLICE - FIRE - RESCUE 911						
FAIRFAX COUNTY, VIRGINIA						
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12000 GOVERNMENT CENTER PARKWAY, SUITE 449 FAIRFAX, VA., 22035-0052						
REVISIONS					OFFICE OF CAPITAL FACILITIES 703-324-5800	
					WIEHLE AVENUE (RTE 828) AT W&OD TRAIL	
					UNDERGROUND UTILITY TEST HOLE INFORMATION	
					PROJECT NO: 1400102-2013	
					SCALE	DESIGNED: NDD
					1"=100'	DRAFTED: WRA
						CHECKED: RBH
						SHEET
						1G
					FUND # 500-C5000	



# SEQUENCE OF CONSTRUCTION



Whitman Requardt & Associates  
Fairfax, Virginia  
ROADWAY ENGINEER

## PROJECT DESCRIPTION

THIS TASK CONSISTS OF THE CONSTRUCTION OF IMPROVEMENTS TO THE W&OD TRAIL (BOTH ASPHALT AND GRAVEL PATHS) AND A BRIDGE OVER WIEHLE AVENUE. THE PROPOSED IMPROVEMENTS INCLUDE CONSTRUCTING A 12 FOOT WIDE ASPHALT TRAIL AND BRIDGE OVER WIEHLE AVENUE, NEW MSE WALLS, INSTALLING CURB RAMPS, NEW SIDEWALK, DRAINAGE IMPROVEMENTS AND CONSTRUCTING CURB AND GUTTER. THE PROJECT ALSO INCORPORATES RELOCATION OF AN EXISTING WATER MAIN AND UPGRADE TO THE EXISTING SIGNAL AT THE INTERSECTION OF WIEHLE AVENUE AND SUNSET HILLS ROAD.

WITHIN THE PROJECT LIMITS THE W&OD TRAIL WILL TRAVEL THROUGH MVRPA PROPERTY. AS THE PHYSICAL IMPROVEMENTS ARE LIMITED TO THE PATH AND SIDEWALK WORK, IMPACTS TO THE ROADWAYS WILL BE LIMITED TO WIEHLE AVENUE

## ALLOWABLE HOURS FOR CLOSURES

THE CONTRACTOR SHALL MAKE EVERY EFFORT TO MAINTAIN THE EXISTING TRAVEL LANES OPEN TO TRAFFIC AT ALL TIMES. LANE CLOSURES HOURS ARE IN ACCORDANCE WITH LANE CLOSURES IN NOVA DISTRICT MEMORDANDUM DATED 9/29/2016. LANE CLOSURES HOURS FOR CONSTRUCTION SHALL BE PERMITTED DURING THE FOLLOWING HOURS:

WIEHLE AVENUE (RTE.828) & SUNSET HILLS ROAD (RTE 675) URBAN MINOR ARTERIAL (GS-6)	
	SINGLE LANE CLOSURES OR SHOULDER
MONDAY TO THURSDAY	9:00AM TO 3:30PM 9:00PM TO 5:00AM
FRIDAY	9:00AM TO 2:00PM
FRIDAY TO SATURDAY	10:00PM TO 9:00AM
SATURDAY TO SUNDAY	9:00PM TO 9:00AM
SUNDAY TO MONDAY	10:00PM TO 5:00AM

W&OD TRAIL	
	TRAIL CLOSURE
MONDAY TO THURSDAY	9:00PM TO 5:00AM
FRIDAY	9:00PM TO 5:00AM
FRIDAY TO SATURDAY	9:00PM TO 5:00AM
SATURDAY TO SUNDAY	9:00PM TO 5:00AM
SUNDAY TO MONDAY	9:00PM TO 5:00AM

- SINGLE-LANE CLOSURES ARE ONLY PERMITTED FOR MULTIPLE-LANE ROADWAYS.

EXCEPT AS NECESSARY TO MAINTAIN TRAFFIC, WORK SHALL NOT BE PERFORMED ON THE FOLLOWING HOLIDAYS WITHOUT THE APPROVAL OF THE ENGINEER: NEW YEAR'S DAY, MARTIN LUTHER KING, JR. DAY, PRESIDENT'S DAY, MEMORIAL DAY, INDEPENDENCE DAY, LABOR DAY, COLUMBUS' DAY, VETERANS DAY, THANKSGIVING DAY, AND CHRISTMAS DAY. LANE CLOSURES WILL NOT BE PERMITTED FROM NOON THE DAY BEFORE A HOLIDAY UNTIL NOON THE DAY AFTER A HOLIDAY UNLESS OTHERWISE APPROVED BY THE ENGINEER. WHEN A HOLIDAY FALLS ON A FRIDAY, LANE CLOSURES ARE NOT PERMITTED FROM NOON THURSDAY UNTIL NOON ON MONDAY. WHEN THE HOLIDAY FALLS ON MONDAY, LANE CLOSURES ARE NOT PERMITTED FROM NOON FRIDAY UNTIL NOON ON TUESDAY. ADDITIONAL STATE HOLIDAYS MAY BE ADDED TO THIS LIST AT THE DIRECTION OF THE ENGINEER.

TOTAL CLOSURE OF WIEHLE AVENUE SHALL NOT EXCEED 20 MINUTES IN ACCORDANCE WITH TTC-50.0. CONTRACTOR SHALL USE A DETOUR IF WORK CAN NOT BE PERFORMED WITHIN THE ALLOWABLE CLOSURE TIMEFRAME.

## PUBLIC COMMUNICATIONS PLAN

THE CONTRACTOR SHALL SUBMIT A REQUEST FOR ALL LANE CLOSURES TO VDOT 10 DAYS IN ADVANCE OF THE CLOSURE. THE ENGINEER WILL COMMUNICATE WITH THE VDOT NORTHERN VIRGINIA PUBLIC AFFAIRS SECTION, FAIRFAX COUNTY SUPERVISORS, FEDERAL AGENCIES AND SCHOOLS IN CLOSE PROXIMITY, RADIO AND TELEVISION, EMERGENCY SERVICES, VDOT, AND THE TRAFFIC OPERATIONS CENTER, AS DETERMINED APPROPRIATE.



## GENERAL NOTES

- THE TMP FOR THIS PROJECT IS CATEGORIZED AS TYPE B, CATEGORY III.
- UNLESS OTHERWISE APPROVED OR DIRECTED BY THE ENGINEER, THE CONTRACTOR SHALL PLAN AND PROSECUTE THE WORK IN ACCORDANCE WITH THIS TRANSPORTATION MANAGEMENT PLAN.
- THE TRANSPORTATION MANAGEMENT PLAN (TMP) IS INTENDED AS A GUIDE. IT IS NOT INTENDED TO ENUMERATE EVERY DETAIL WHICH MUST BE CONSIDERED IN THE CONSTRUCTION OF THIS PROJECT, BUT ONLY TO SHOW THE GENERAL HANDLING OF EXISTING TRAFFIC. IT SHALL BE THE RESPONSIBILITY OF THE CONTRACTOR TO PRESENT A FORMAL TMP/MAINTENANCE OF TRAFFIC (MOT) PLAN TO THE ENGINEER FOR APPROVAL PRIOR TO ANY CONSTRUCTION THAT MAY AFFECT THE EXISTING TRAFFIC, INCLUDING THE MODIFICATION OF EXISTING TRAFFIC SIGNALS.
- ALL TRAFFIC MAINTENANCE SHALL CONFORM WITH THE FOLLOWING AND THE LATEST REVISIONS THERETO:
  - A. 2009 MANUAL ON UNIFORM TRAFFIC CONTROL DEVICES (REV. 2)
  - B. 2011 VIRGINIA SUPPLEMENT TO THE 2009 MUTCD (REV. 1)
  - C. 2011 VIRGINIA WORK AREA PROTECTION MANUAL (REV. 1)
  - D. 2016 VDOT ROAD AND BRIDGE STANDARDS (LATEST REVISION)
  - E. 2016 VDOT ROAD AND BRIDGE SPECIFICATIONS (LATEST REVISION)
- THE CONTRACTOR SHALL SUBMIT TRAFFIC CONTROL PLANS TO VDOT FOR APPROVAL. THE CONTRACTOR SHOULD REFER TO VIRGINIA WORK AREA PROTECTION MANUAL, SPECIFICALLY THE FOLLOWING STANDARDS:
  - TTC-27J - LANE CLOSURE OPERATION - FAR SIDE OF AN INTERSECTION
  - TTC-29J - TURN LANE CLOSURE OPERATION
  - TTC-35.0 - SIDEWALK CLOSURE AND BYPASS SIDEWALK OPERATION
  - TTC-36J - CROSSWALK CLOSURE AND PEDESTRIAN DETOUR OPERATION
  - TTC-50.0 - DISRUPTION OPERATION ON A MULTI-LANE ROADWAY.
  - TTC-53.0 - SIGNING FOR PROJECT LIMITS.
- FOR DETAILS OF PERMANENT CONSTRUCTION, REFER TO THE CONSTRUCTION PLANS (SHEETS 3-5).
- TEMPORARY LANE WIDTHS SHALL NOT BE LESS THAN 11 FT.
- AT THE CONCLUSION OF EACH WORKDAY, EQUIPMENT AND MATERIALS SHALL NOT BE STORED WITHIN THE ESTABLISHED 11.5' CLEAR ZONE AND/OR DEFLECTION ZONE OF PHYSICAL BARRIERS IN ACCORDANCE WITH THE WORK AREA PROTECTION MANUAL. ANY AREAS EXCAVATED BELOW THE EXISTING PAVEMENT SURFACE AND WITHIN THE CLEAR ZONE, SHALL BE BACK FILLED WITH APPROVED MATERIAL TO FORM AN APPROXIMATE 6:1 WEDGE AGAINST THE EXISTING PAVEMENT SURFACE FOR THE SAFETY AND PROTECTION OF VEHICULAR TRAFFIC. ALL COST FOR PLACING, MAINTAINING, AND REMOVING THE 6:1 WEDGE SHALL BE INCLUDED IN THE PRICE BID FOR OTHER ITEMS IN THE CONTRACT AND NO ADDITIONAL COMPENSATION WILL BE ALLOWED.
- IF UTILIZED, TRAFFIC BARRIER SERVICE SHALL BE INSTALLED AND REMOVED SO AS NOT TO PRESENT ANY BLUNT END OR HAZARD TO THE MOTORING PUBLIC. THE PLACEMENT AND REMOVAL OF THE TRAFFIC BARRIER SERVICE AND BARRICADES ARE TO BE COORDINATED BY THE PROJECT SAFETY OFFICER.
- THE EXISTING POSTED SPEED LIMITS SHALL BE MAINTAINED DURING CONSTRUCTION UNLESS OTHERWISE APPROVED BY THE ENGINEER.
- CONTRACTOR SHALL MAINTAIN ACCESS TO ALL DRIVEWAY ENTRANCES DURING CONSTRUCTION.
- TEMPORARY CLOSURE AFFECTING EGRESS TO ADJACENT PROPERTIES SHALL BE COORDINATED WITH AFFECTED PARTIES.
- CONTRACTOR SHALL MAINTAIN SAFE PASSAGE FOR PEDESTRIANS AND BICYCLISTS DURING CONSTRUCTION WHERE EXISTING FACILITIES ARE PRESENT.
- THE CONTRACTOR SHALL MAINTAIN ALL SIGNAGE WITHIN THE LIMITS OF CONSTRUCTION, SHOWN OR OTHERWISE, UNLESS DIRECTED BY THE ENGINEER. IF REMOVAL IS ALLOWED, CONTRACTOR SHALL STORE THE SIGNS PER VDOT STANDARDS, AND IF DIRECTED, REPLACE THEM AT THE COMPLETION OF THE PROJECT.
- CONTRACTOR SHALL ENSURE POSITIVE DRAINAGE FOR THE DURATION OF THE PROJECT. ADDITIONAL TEMPORARY MEASURES MAY BE NEEDED TO FACILITATE PROPER POSITIVE DRAINAGE.
- THE CONTRACTOR SHALL SCHEDULE ALL PHASES OF CONSTRUCTION IN SUCH MANNER THAT WATER, SEWER, CABLE, POWER, AND ANY OVERHANGING OR UNDERGROUND UTILITY SERVICES WILL NOT BE INTERRUPTED. THE COST OF ANY TEMPORARY CONNECTION, IN PART OR WHOLE, SHALL BE INCIDENTAL TO THE UTILITY RELOCATION/CONSTRUCTION. THE CONTRACTOR SHALL COORDINATE THEIR UTILITY ADJUSTMENTS/RELOCATION ACTIVITIES WITH THE OWNER OF THE UTILITY.
- ALL EROSION AND SEDIMENT CONTROL MEASURES AND TEMPORARY DRAINAGE SHALL BE IN PLACE PRIOR TO THE BEGINNING OF CONSTRUCTION.
- ALL PAVEMENT MARKINGS AND TRAFFIC FLOW ARROWS ARE SCHEMATIC ONLY. THE ACTUAL LOCATION AND APPLICATION OF PAVEMENT MARKINGS SHALL BE INSTALLED PER THE SIGNING AND PAVEMENT MARKINGS PLANS AND IN ACCORDANCE WITH SECTION 704 OF THE VDOT ROAD AND BRIDGE SPECIFICATIONS; THE MUTCD 2009 EDITION; THE 2016 ROAD AND BRIDGE STANDARDS; OR AS DIRECTED BY THE ENGINEER.
- THE CONTRACTOR SHALL NOTIFY THE ENGINEER IN WRITING A MINIMUM OF 10 WORKING DAYS PRIOR TO IMPLEMENTATION OF ANY WORK REQUIRING LANE SHIFTS, LANE CLOSURES, AND/OR PHASE CHANGES.
- THE CONTRACTOR IS RESPONSIBLE FOR COORDINATING THE CONSTRUCTION, SIGNING, AND TRAFFIC MANAGEMENT PLAN WITH OTHER ADJACENT PROJECTS UNDER CONSTRUCTION.
- DISPOSAL SITE AND STAGING AREA LOCATIONS SHALL BE THE RESPONSIBILITY OF THE CONTRACTOR. NO WORK SHALL BE PERFORMED UNTIL SUCH SITES HAVE BEEN ACCEPTED BY THE ENGINEER.
- WHEN POLICE PRESENCE IS REQUIRED FOR A LANE CLOSURE OPERATION, THE ENGINEER SHALL CONTACT THE VIRGINIA STATE POLICE DIVISION SEVEN HEADQUARTERS, 4977 ALLIANCE DRIVE, FAIRFAX, VIRGINIA, 22030, TELEPHONE 703-803-2660, OR THE FAIRFAX COUNTY POLICE DEPARTMENT, 12099 GOVERNMENT CENTER PARKWAY, FAIRFAX, VA 22035, TELEPHONE 703-691-2131 TO REQUEST POLICE SUPPORT AND GIVE THE POLICE A MINIMUM OF 5 DAYS ADVANCE NOTICE. THE ENGINEER SHALL NOTIFY THE POLICE OF ANY CANCELLATION AT LEAST 24 HOURS IN ADVANCE TO AVOID ADDITIONAL CHARGES. THE COST OF POLICE SUPPORT SHALL BE INCLUDED IN THE COST OF PROJECT MOBILIZATION.

## SEQUENCE OF CONSTRUCTION

ALL EROSION AND SEDIMENT CONTROL MEASURES SHALL BE INSTALLED PRIOR TO COMMENCING ANY CONSTRUCTION ACTIVITY.

CONTRACTOR SHALL INSTALL 6' CONSTRUCTION SAFETY FENCE AROUND WORK AREAS AS NEEDED TO ENSURE PUBLIC SAFETY. FENCE SHALL BE A MINIMUM OF 3' FROM THE EDGE OF PAVEMENT ON THE ACTIVE TRAIL.

PEDESTRIAN DETOURS SHALL BE INSTALLED ALONG WIEHLE AVENUE FOR CONSTRUCTION OF BRIDGE ABUTMENTS AND SIDEWALK IMPROVEMENTS AS SHOWN ON PLANS AND IN ACCORDANCE WITH FIGURE TTC-35.0 OF THE VWAPM.

CONTRACTOR SHALL MAINTAIN ACCESS TO ENTRANCES AND SAFE PASSAGE FOR PEDESTRIANS/BICYCLISTS DURING CONSTRUCTION WHERE EXISTING FACILITIES ARE PRESENT UNLESS OTHERWISE SHOWN. ACCESS TO THE W&OD TRAIL LOCATED WITHIN THE PROJECT LIMITS SHALL BE MAINTAINED DURING ALL PHASES OF CONSTRUCTION.

INSTALLATION OF SIGNING FOR THE PROJECT LIMITS SHALL BE IN ACCORDANCE WITH FIGURE TTC-53.0 OF THE VWAPM.

CONSTRUCTION ACTIVITIES SHALL NOT BE PERFORMED ON BOTH SIDES OF THE W&OD TRAIL UNLESS OTHERWISE APPROVED BY THE ENGINEER.

PHASE 1:

STAGE 1 - CONSTRUCT OPEN-CUT WATER LINE RELOCATION ACROSS WIEHLE AVENUE USING SIMILAR METHODS TO PHASE 4. CONTRACTOR SHALL MAINTAIN A MINIMUM OF AT LEAST 1 LANE OF TRAFFIC IN EACH DIRECTION AT ALL TIMES, UTILIZING TTC-27J, 29J, AND 36J.

STAGE 2 - CONTRACTOR SHALL CLOSE THE GRAVEL TRAIL BETWEEN ISAAC NEWTON SQUARE AND MICHAEL FARADAY COURT AND INSTALL PEDESTRIAN DETOUR SIGNING PER FIGURE 1 ON SHEET 1H(2). CONSTRUCT BRIDGE ABUTMENTS, MSE WALLS, AND TRAIL IMPROVEMENTS AS SHOWN ON THE PLANS.

STAGE 3 - CONSTRUCT THE TIE IN TO THE EXISTING W&OD TRAIL AND DRAINAGE IMPROVEMENTS AFFECTING THE ACTIVE TRAIL DURING OFF HOURS.

PHASE 2:

STAGE 1 - CONSTRUCT THE DRAINAGE IMPROVEMENTS AS SHOWN ON THE PLANS. BUILD BRIDGE ABUTMENTS, MSE WALLS, AND TRAIL IMPROVEMENTS AS SHOWN ON THE PLANS.

STAGE 2 - CONSTRUCT THE TIE IN TO THE EXISTING W&OD TRAIL DURING OFF HOURS.

PHASE 3:

THE CONTRACTOR SHALL SET UP A NIGHTTIME CLOSURE OF WIEHLE AVENUE BETWEEN SUNSET HILLS AND ROGER BACON DRIVE IN ACCORDANCE WITH FIGURE TTC-50.0 OF THE VA WAPM. INSTALL PREFABRICATED BRIDGE. THE CONTRACTOR SHALL COORDINATE THE ROAD CLOSURE WITH FAIRFAX COUNTY FIRE STATION 25 (703-437-7575).

PHASE 4:

STAGE 1 - CLOSE THE RIGHT TURN LANE ON SOUTHBOUND WIEHLE AVENUE IN ACCORDANCE WITH FIGURE TTC-29J OF THE VA WAPM AS NEEDED. CONSTRUCT THE NEW PAVEMENT, CURB AND GUTTER, SIDEWALK AND CURB RAMPS ON THE WEST SIDE OF WIEHLE AVENUE.

STAGE 2 - CLOSE THE OUTSIDE LANE ON NORTHBOUND WIEHLE AVENUE IN ACCORDANCE WITH FIGURE TTC-27J OF THE VA WAPM AS NEEDED. CONSTRUCT THE NEW PAVEMENT, CURB AND GUTTER, SIDEWALK AND CURB RAMPS ON THE EAST SIDE OF WIEHLE AVENUE.

STAGE 3 - CLOSE THE INSIDE LANE ON NORTHBOUND WIEHLE AVENUE IN ACCORDANCE WITH FIGURE TTC-27J OF THE VA WAPM. CLOSE THE LEFT TURN LANE ON SOUTHBOUND WIEHLE AVENUE IN ACCORDANCE WITH FIGURE TTC-29J OF THE VA WAPM. CONSTRUCT THE NEW CURB AS SHOWN ON THE PLANS. INSTALL FINAL ROADWAY MARKINGS.



Whitman, Requardt & Associates, LLP

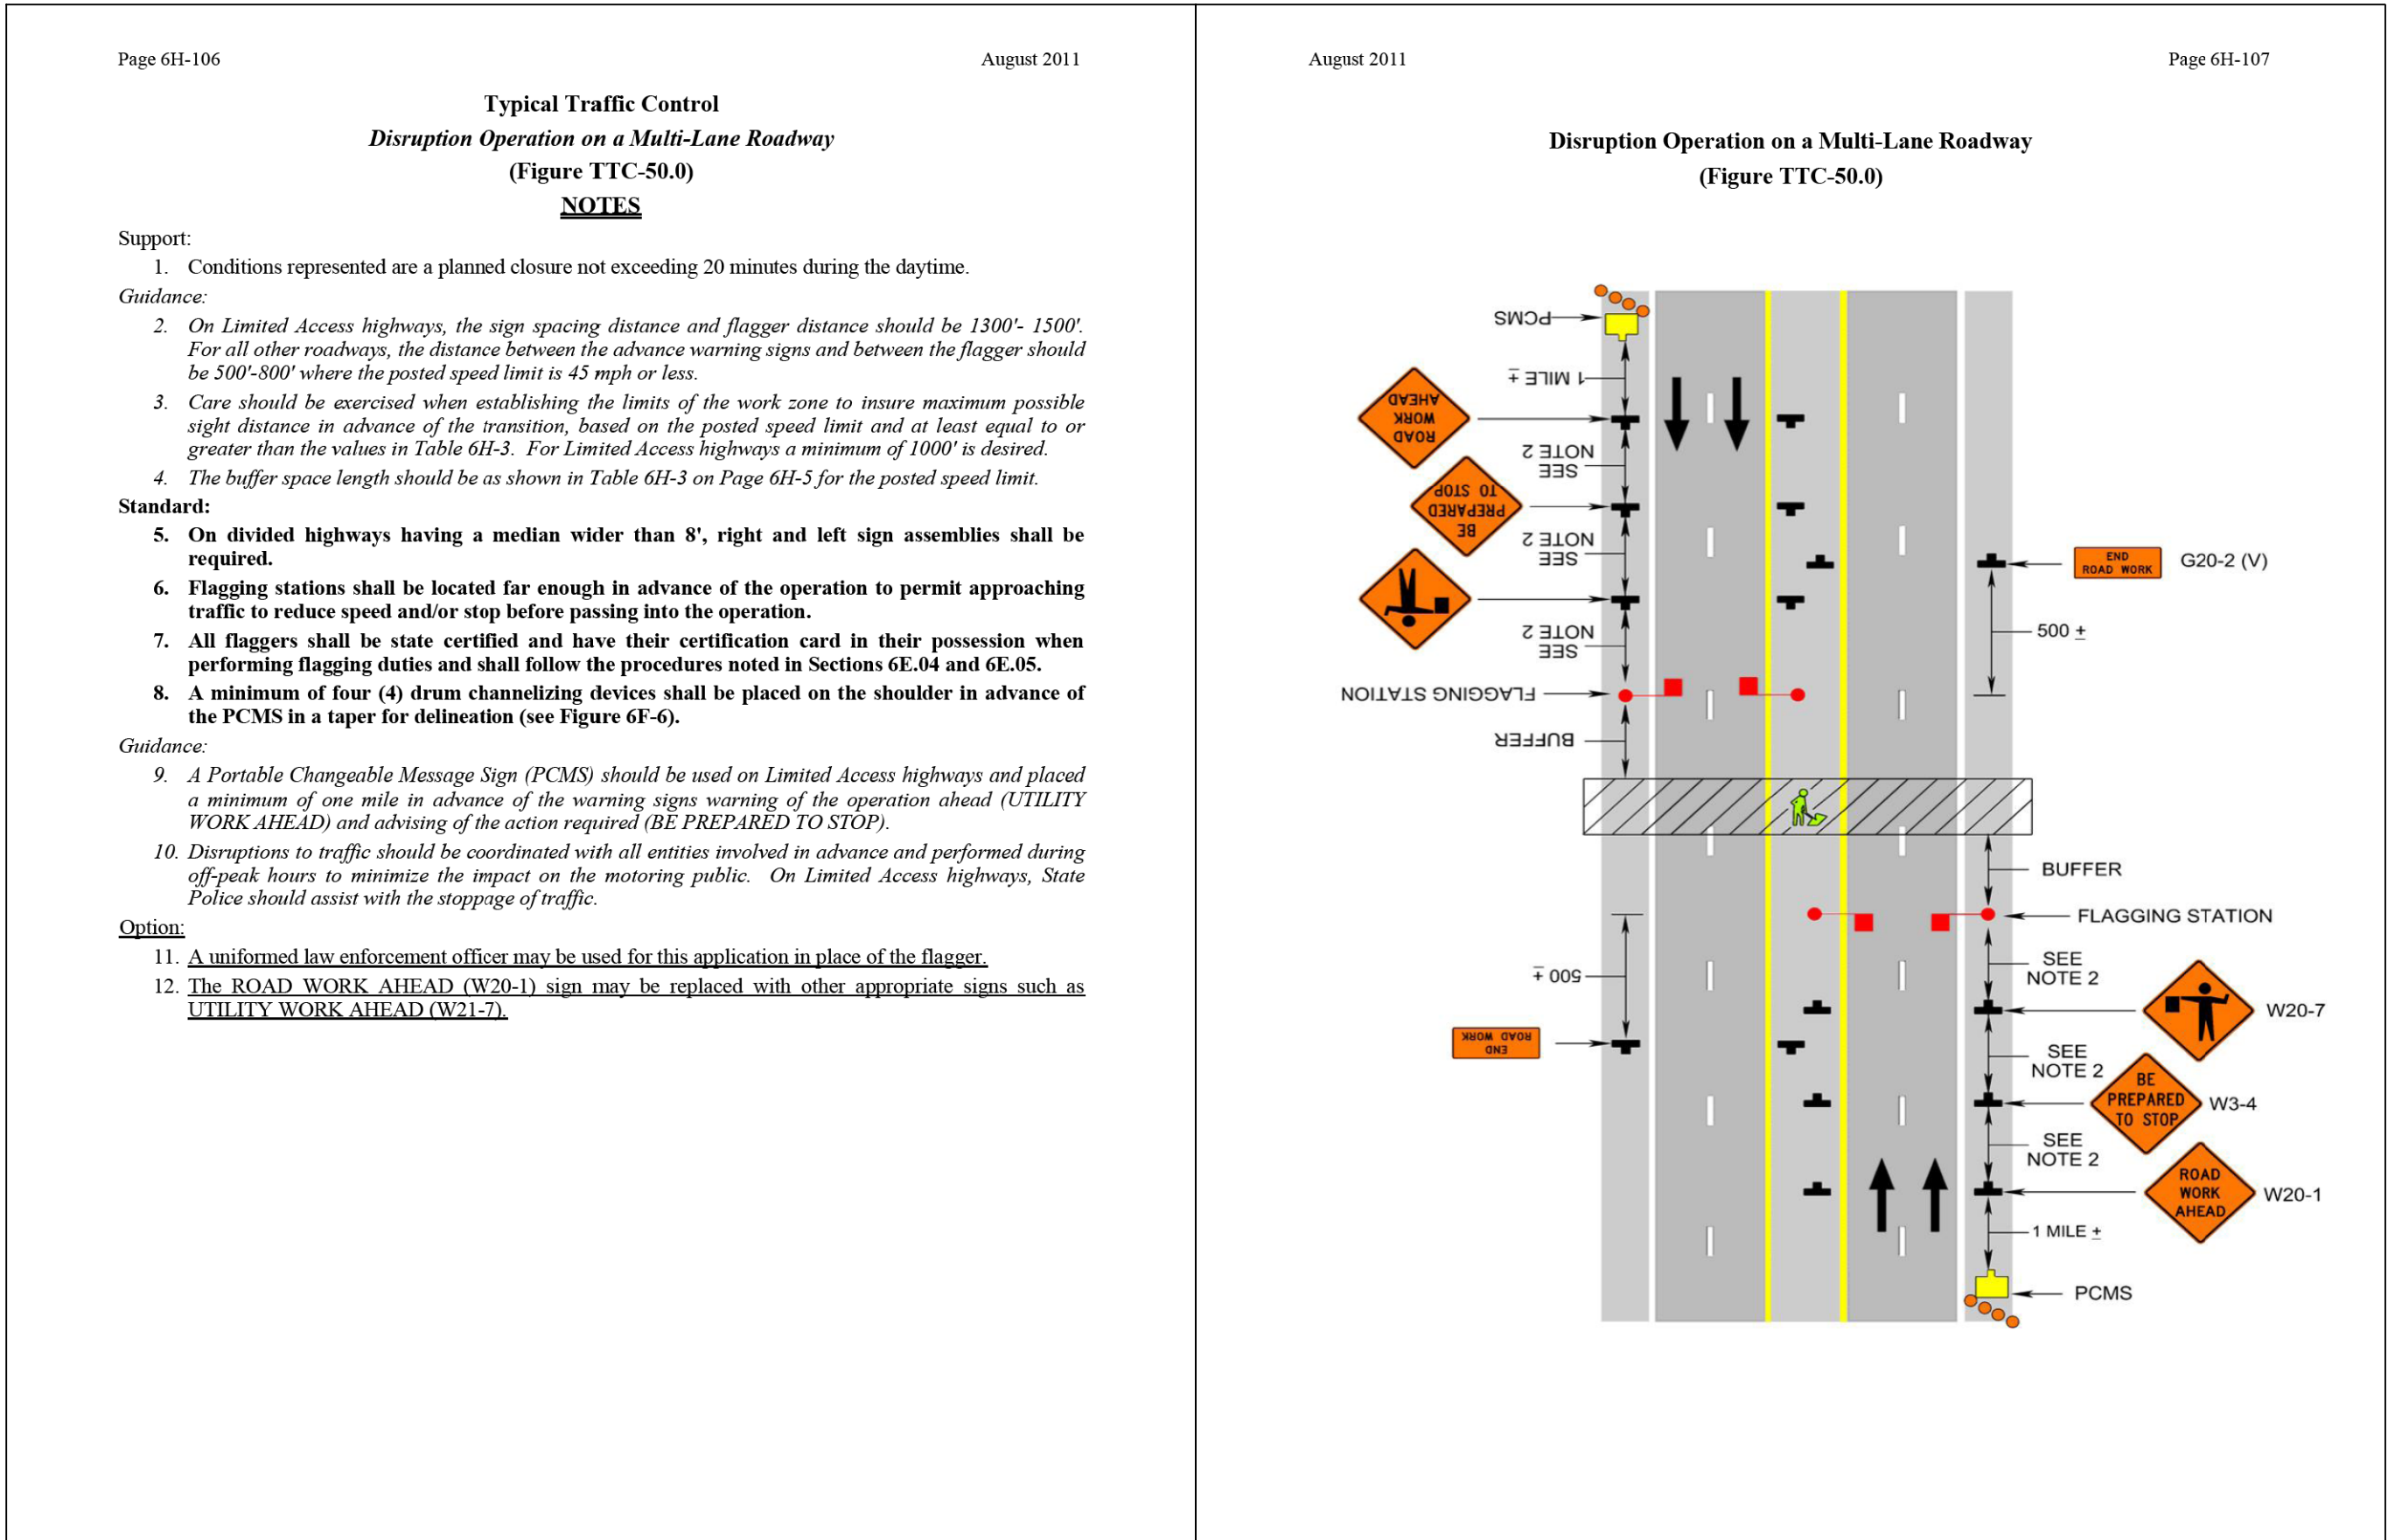
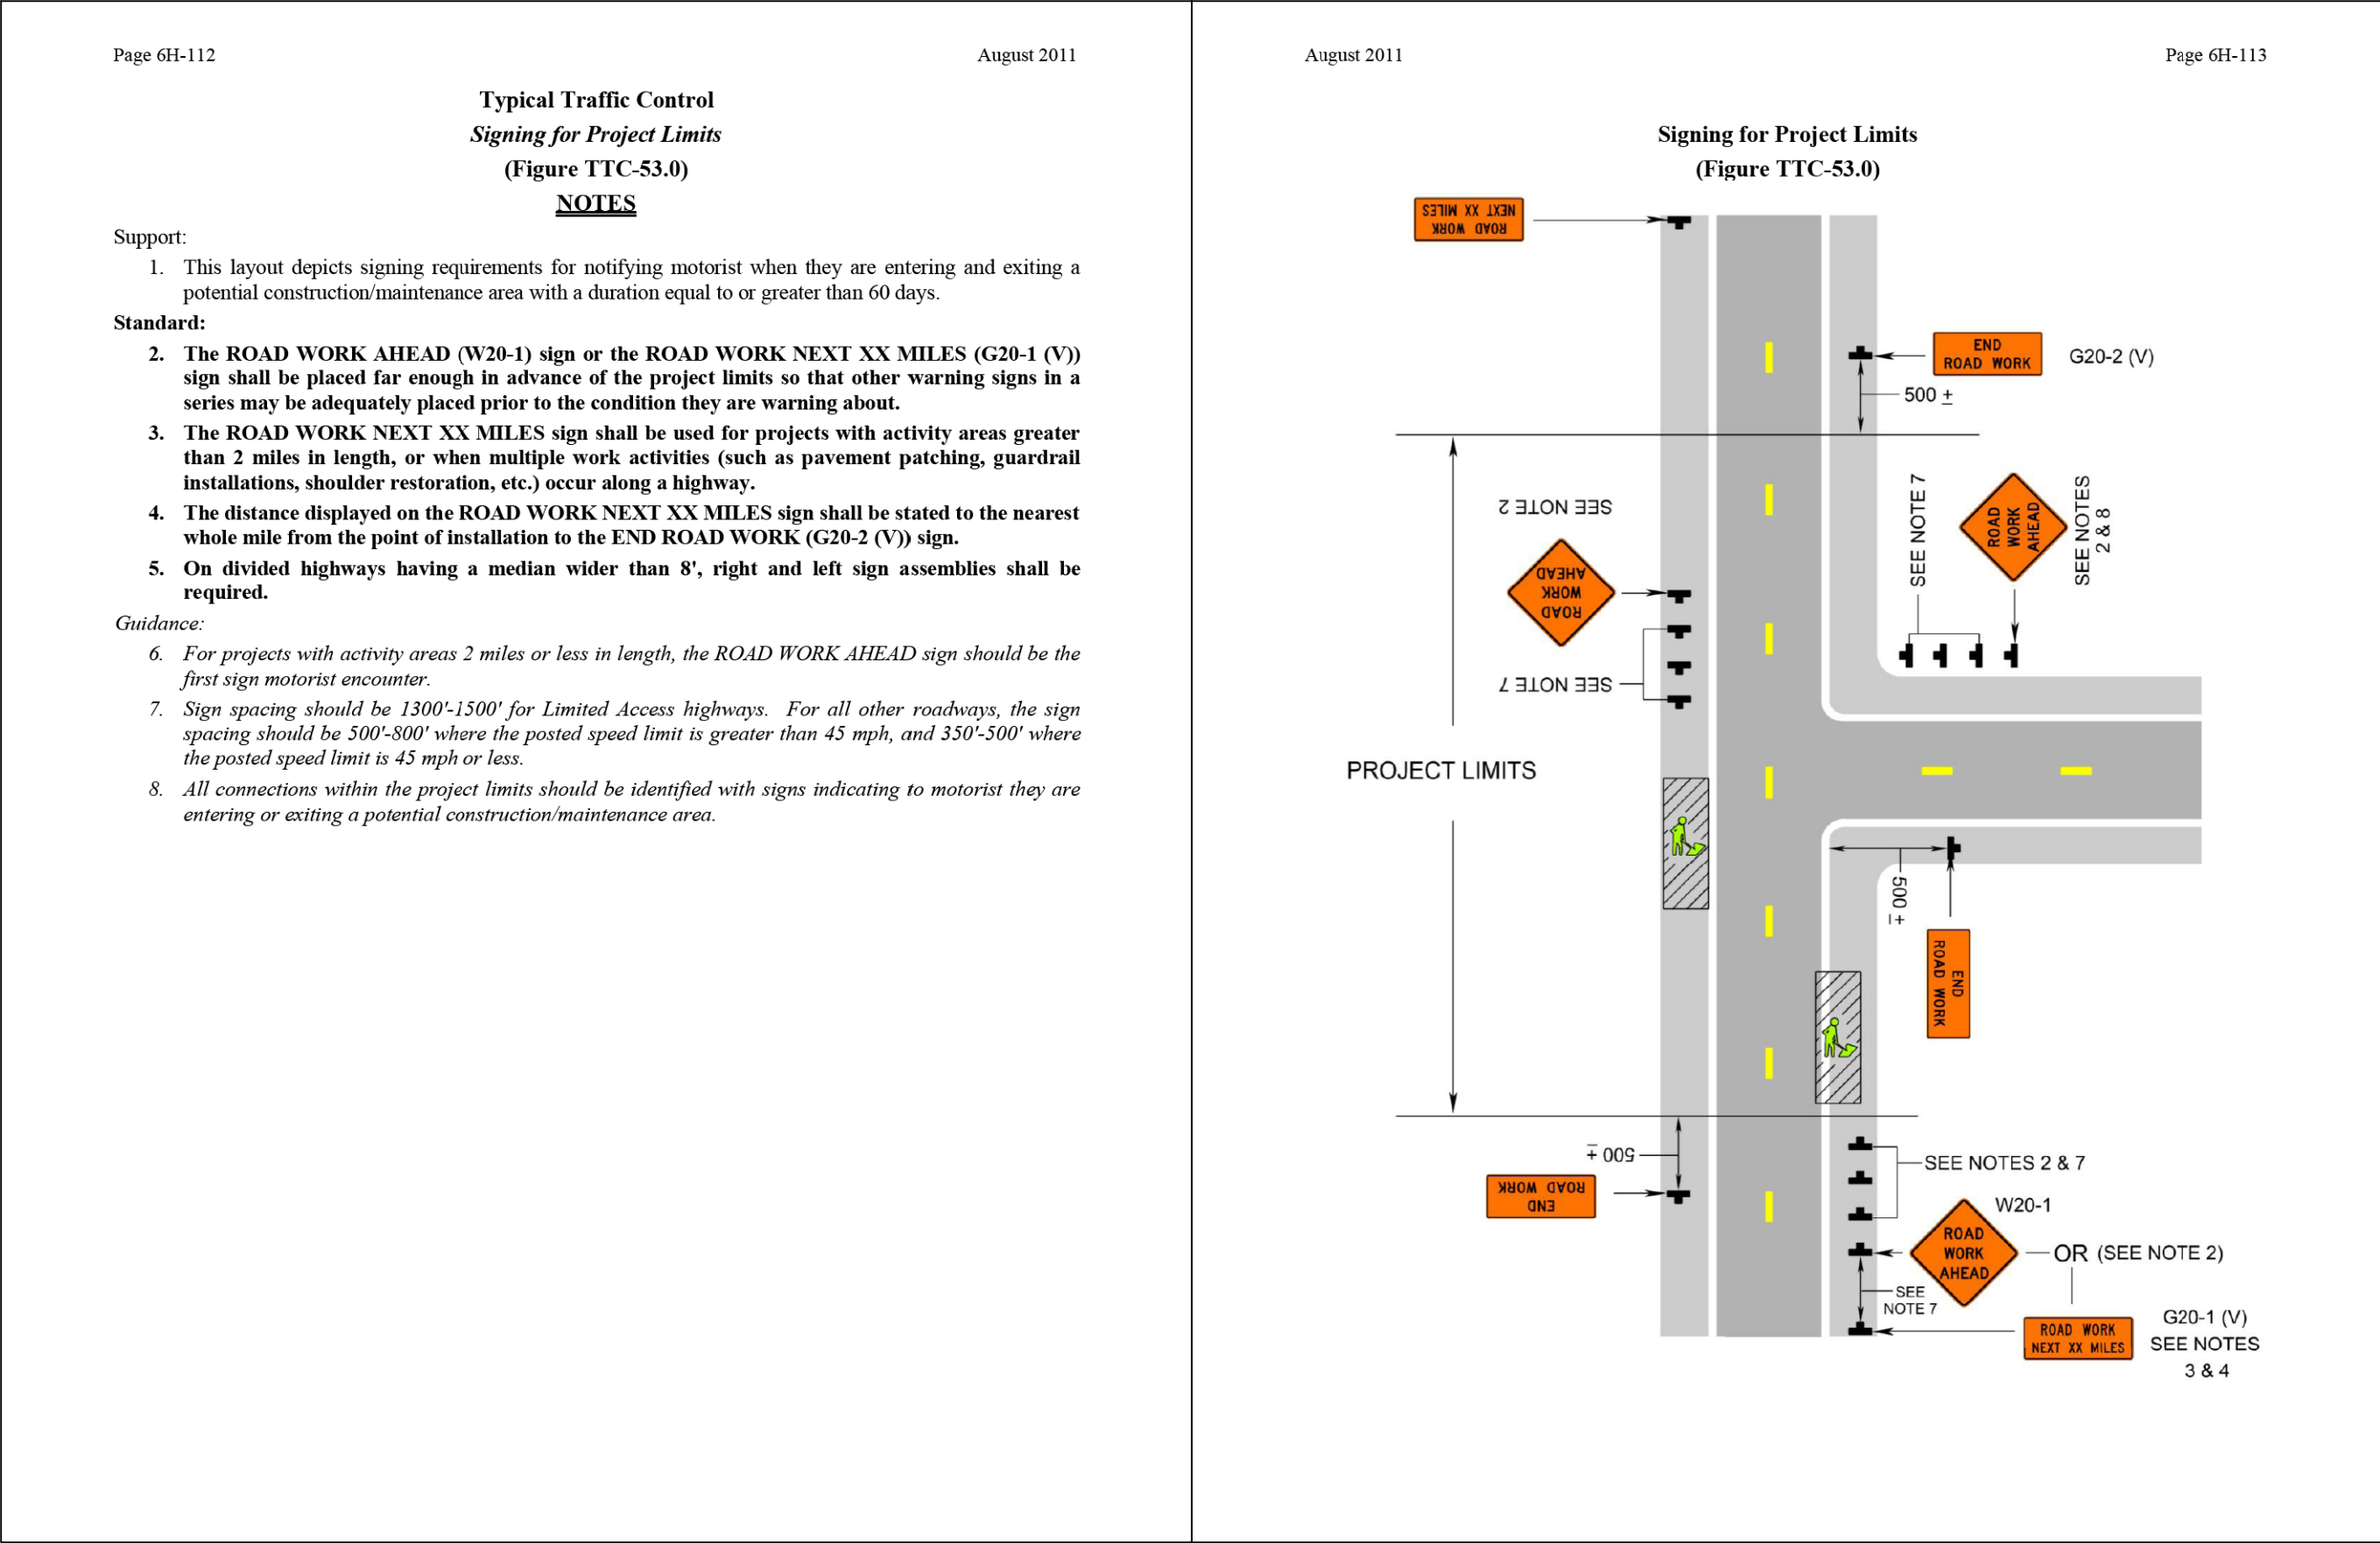
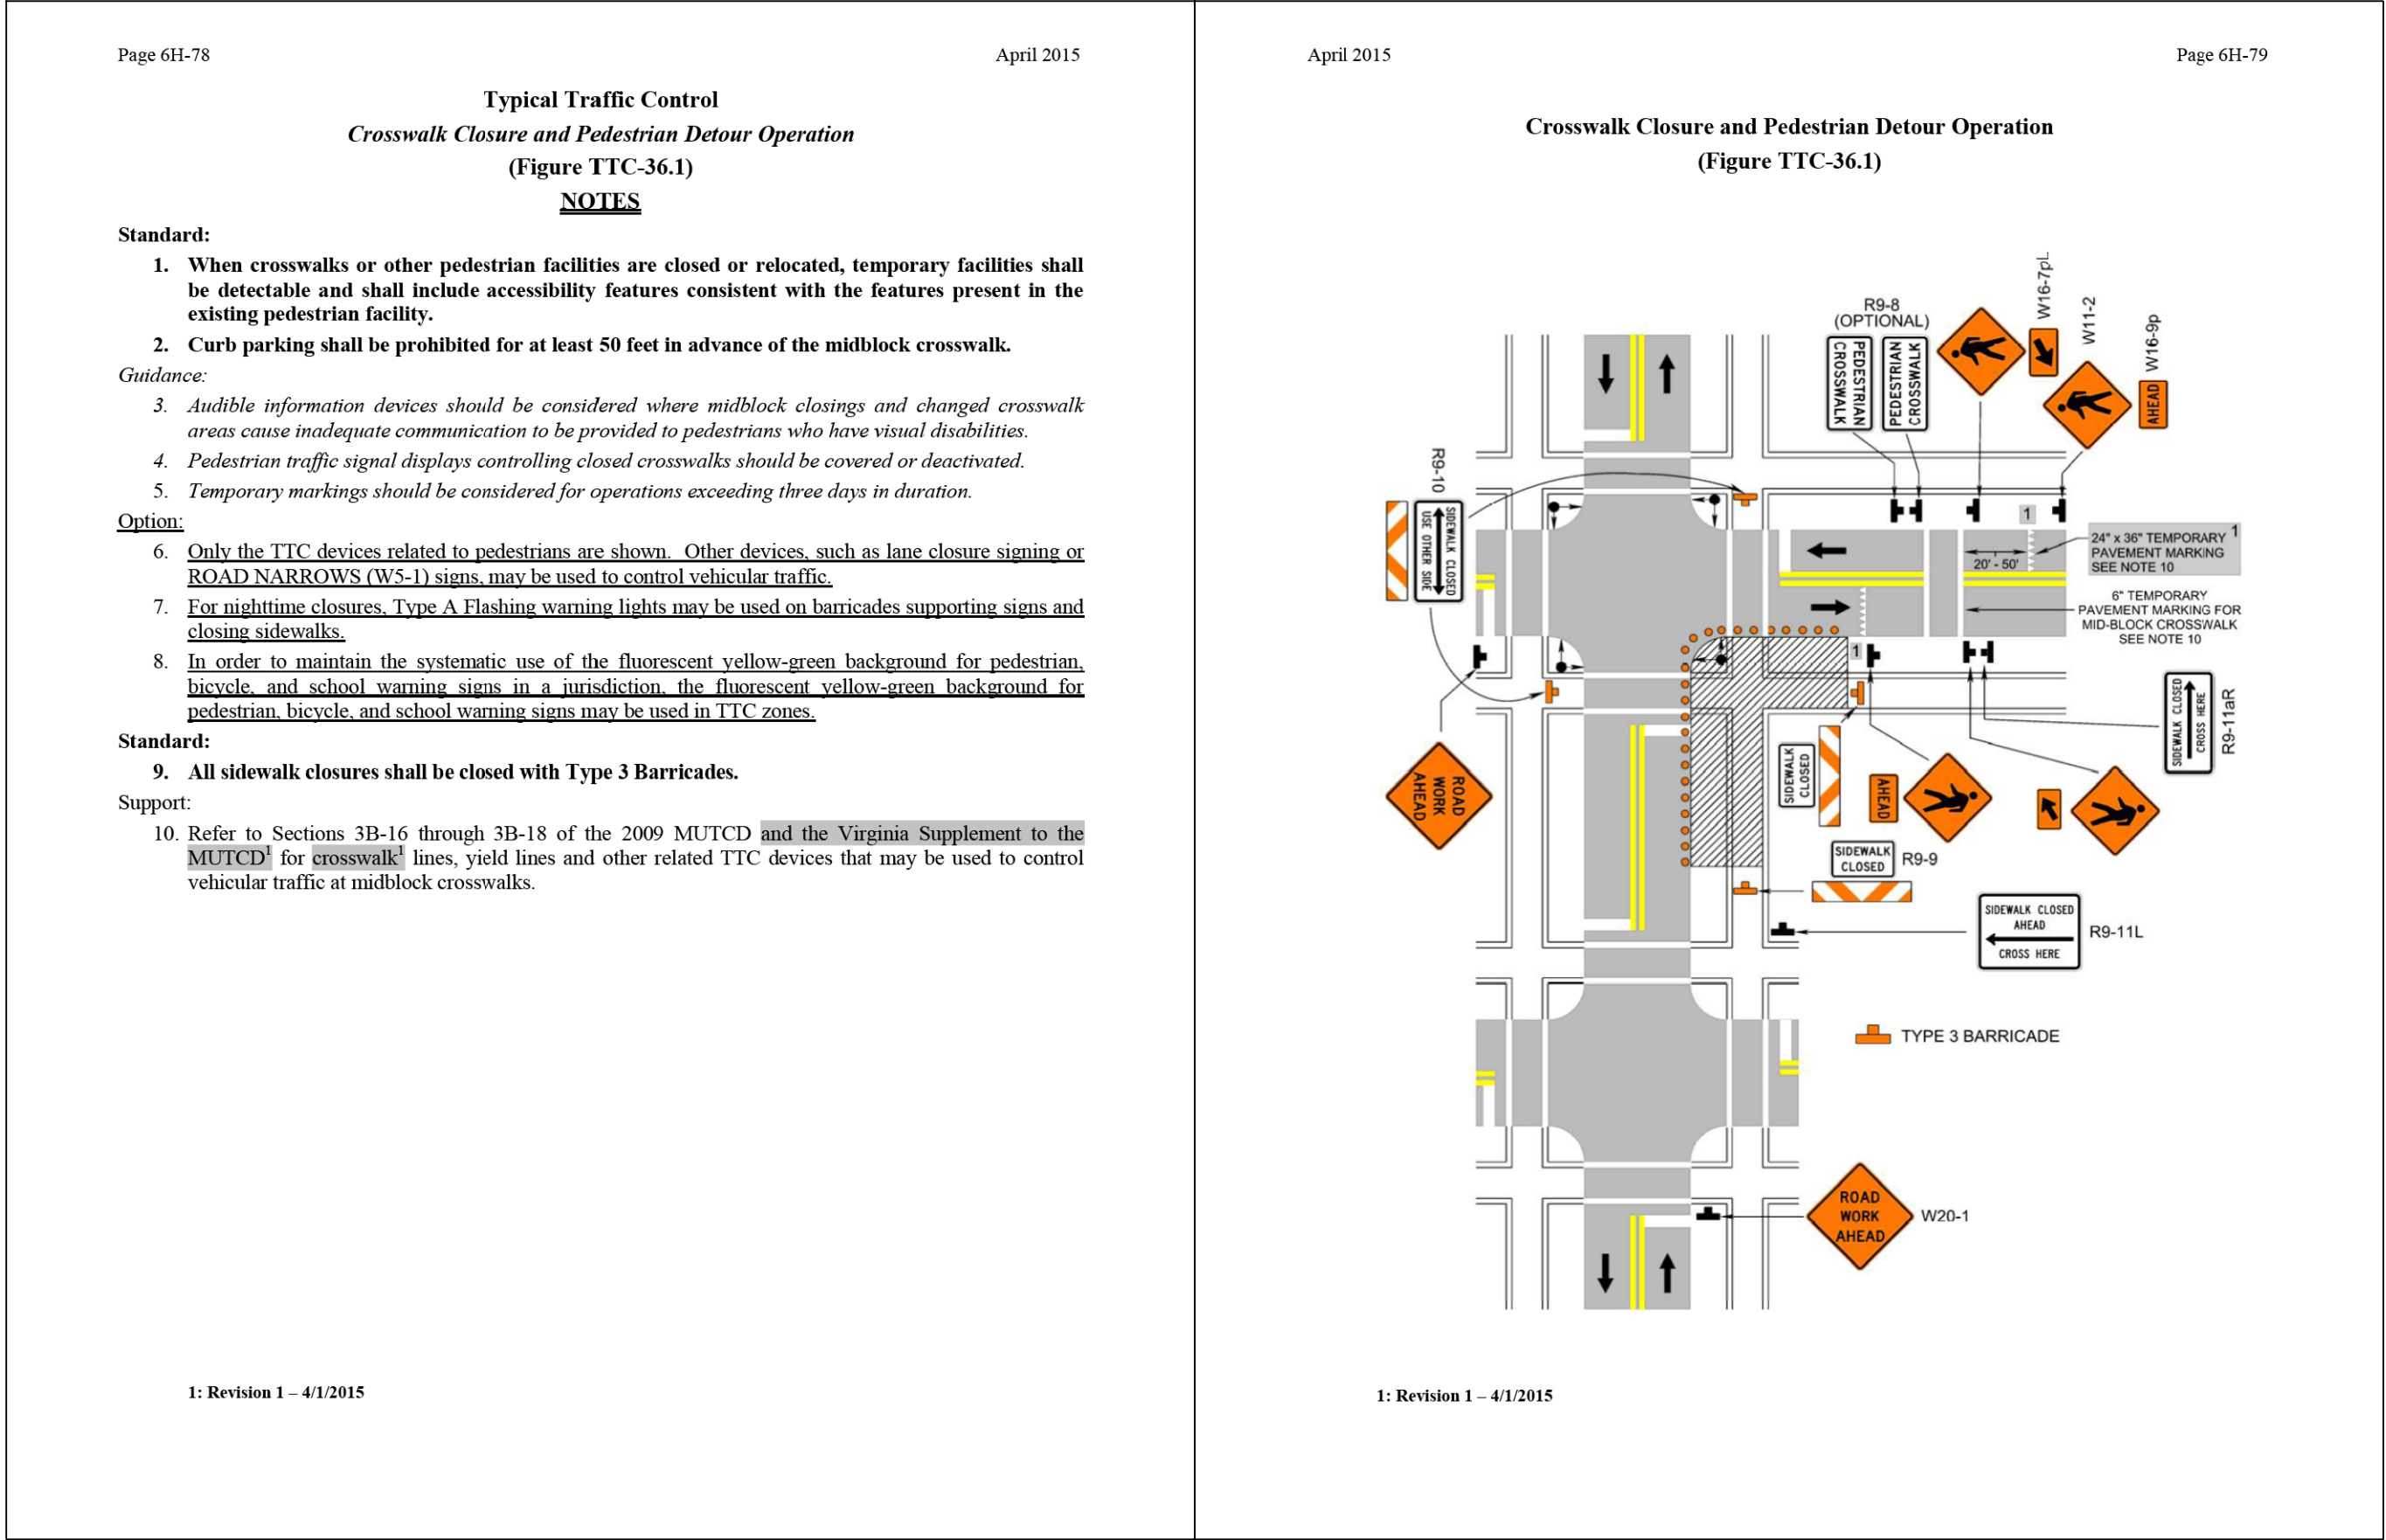
EMERGENCY POLICE - FIRE - RESCUE 911								
FAIRFAX COUNTY, VIRGINIA								
DEPARTMENT OF PUBLIC WORKS AND ENVIRONMENTAL SERVICES								
12000 GOVERNMENT CENTER PARKWAY, SUITE 449 FAIRFAX, VA., 22035-0052								
R					OFFICE OF CAPITAL FACILITIES 703-324-5800			
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S								
I					WIEHLE AVENUE (RTE 828) AT W&OD TRAIL SEQUENCE OF CONSTRUCTION PROJECT NO: 1400102-2013			
N								
O								
S	Δ#	DESCRIPTION	BY	APPROVED	DATE	SCALE NTS	DESIGNED: NDD DRAFTED: WRA CHECKED: RBH	SHEET 1H(1)
APPROVED BY THE TRANSPORTATION DESIGN DIVISION								

FUND # 500-C5000









EMERGENCY POLICE - FIRE - RESCUE 911					
FAIRFAX COUNTY, VIRGINIA					
DEPARTMENT OF PUBLIC WORKS AND ENVIRONMENTAL SERVICES					
12000 GOVERNMENT CENTER PARKWAY, SUITE 449 FAIRFAX, VA., 22035-0052					
R					OFFICE OF CAPITAL FACILITIES 703-324-5800
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Δ#	DESCRIPTION	BY	APPROVED	DATE	PROJECT NO: 1400102-2013
APPROVED BY THE TRANSPORTATION DESIGN DIVISION					SCALE NTS
					DESIGNED: NDD DRAFTED: WRA CHECKED: RBH
					SHEET 1H(3)



PROJECT MANAGER: SCOTT RUEFFNER, P.E. (703) 871-5736  
SURVEYED BY: DATE: FAIRFAX COUNTY, NOVEMBER 28, 2014  
DESIGN BY: WHITMAN, REQUARDT & ASSOCIATES, LLP (703) 293-9717  
SUBSURFACE UTILITY BY: DATE: SO DEEP, INC. (703) 361-6005 DECEMBER 23, 2014

# TEMPORARY CONSTRUCTION PLAN

## PHASE 1

### PHASE 1 CONSTRUCTION ACTIVITIES:


STAGE 1 - CONSTRUCT OPEN-CUT WATER MAIN RELOCATION ACROSS WIEHLE AVENUE. CONTRACTOR SHALL MAINTAIN A MINIMUM OF AT LEAST 1 LANE OF TRAFFIC IN EACH DIRECTION AT ALL TIMES, UTILIZING TTC-27J, 29J, AND 36J.

STAGE 2 - CONTRACTOR SHALL CLOSE THE GRAVEL TRAIL BETWEEN ISAAC NEWTON SQUARE AND MICHAEL FARADAY COURT AND INSTALL PEDESTRIAN DETOUR SIGNING PER FIGURE 10N SHEET 1H(2). CONSTRUCT BRIDGE ABUTMENTS, MSE WALLS, AND TRAIL IMPROVEMENTS AS SHOWN ON THE PLANS.

STAGE 3 - CONSTRUCT THE TIE IN TO THE EXISTING W&OD TRAIL AND DRAINAGE IMPROVEMENTS AFFECTING THE ACTIVE TRAIL DURING OFF HOURS.


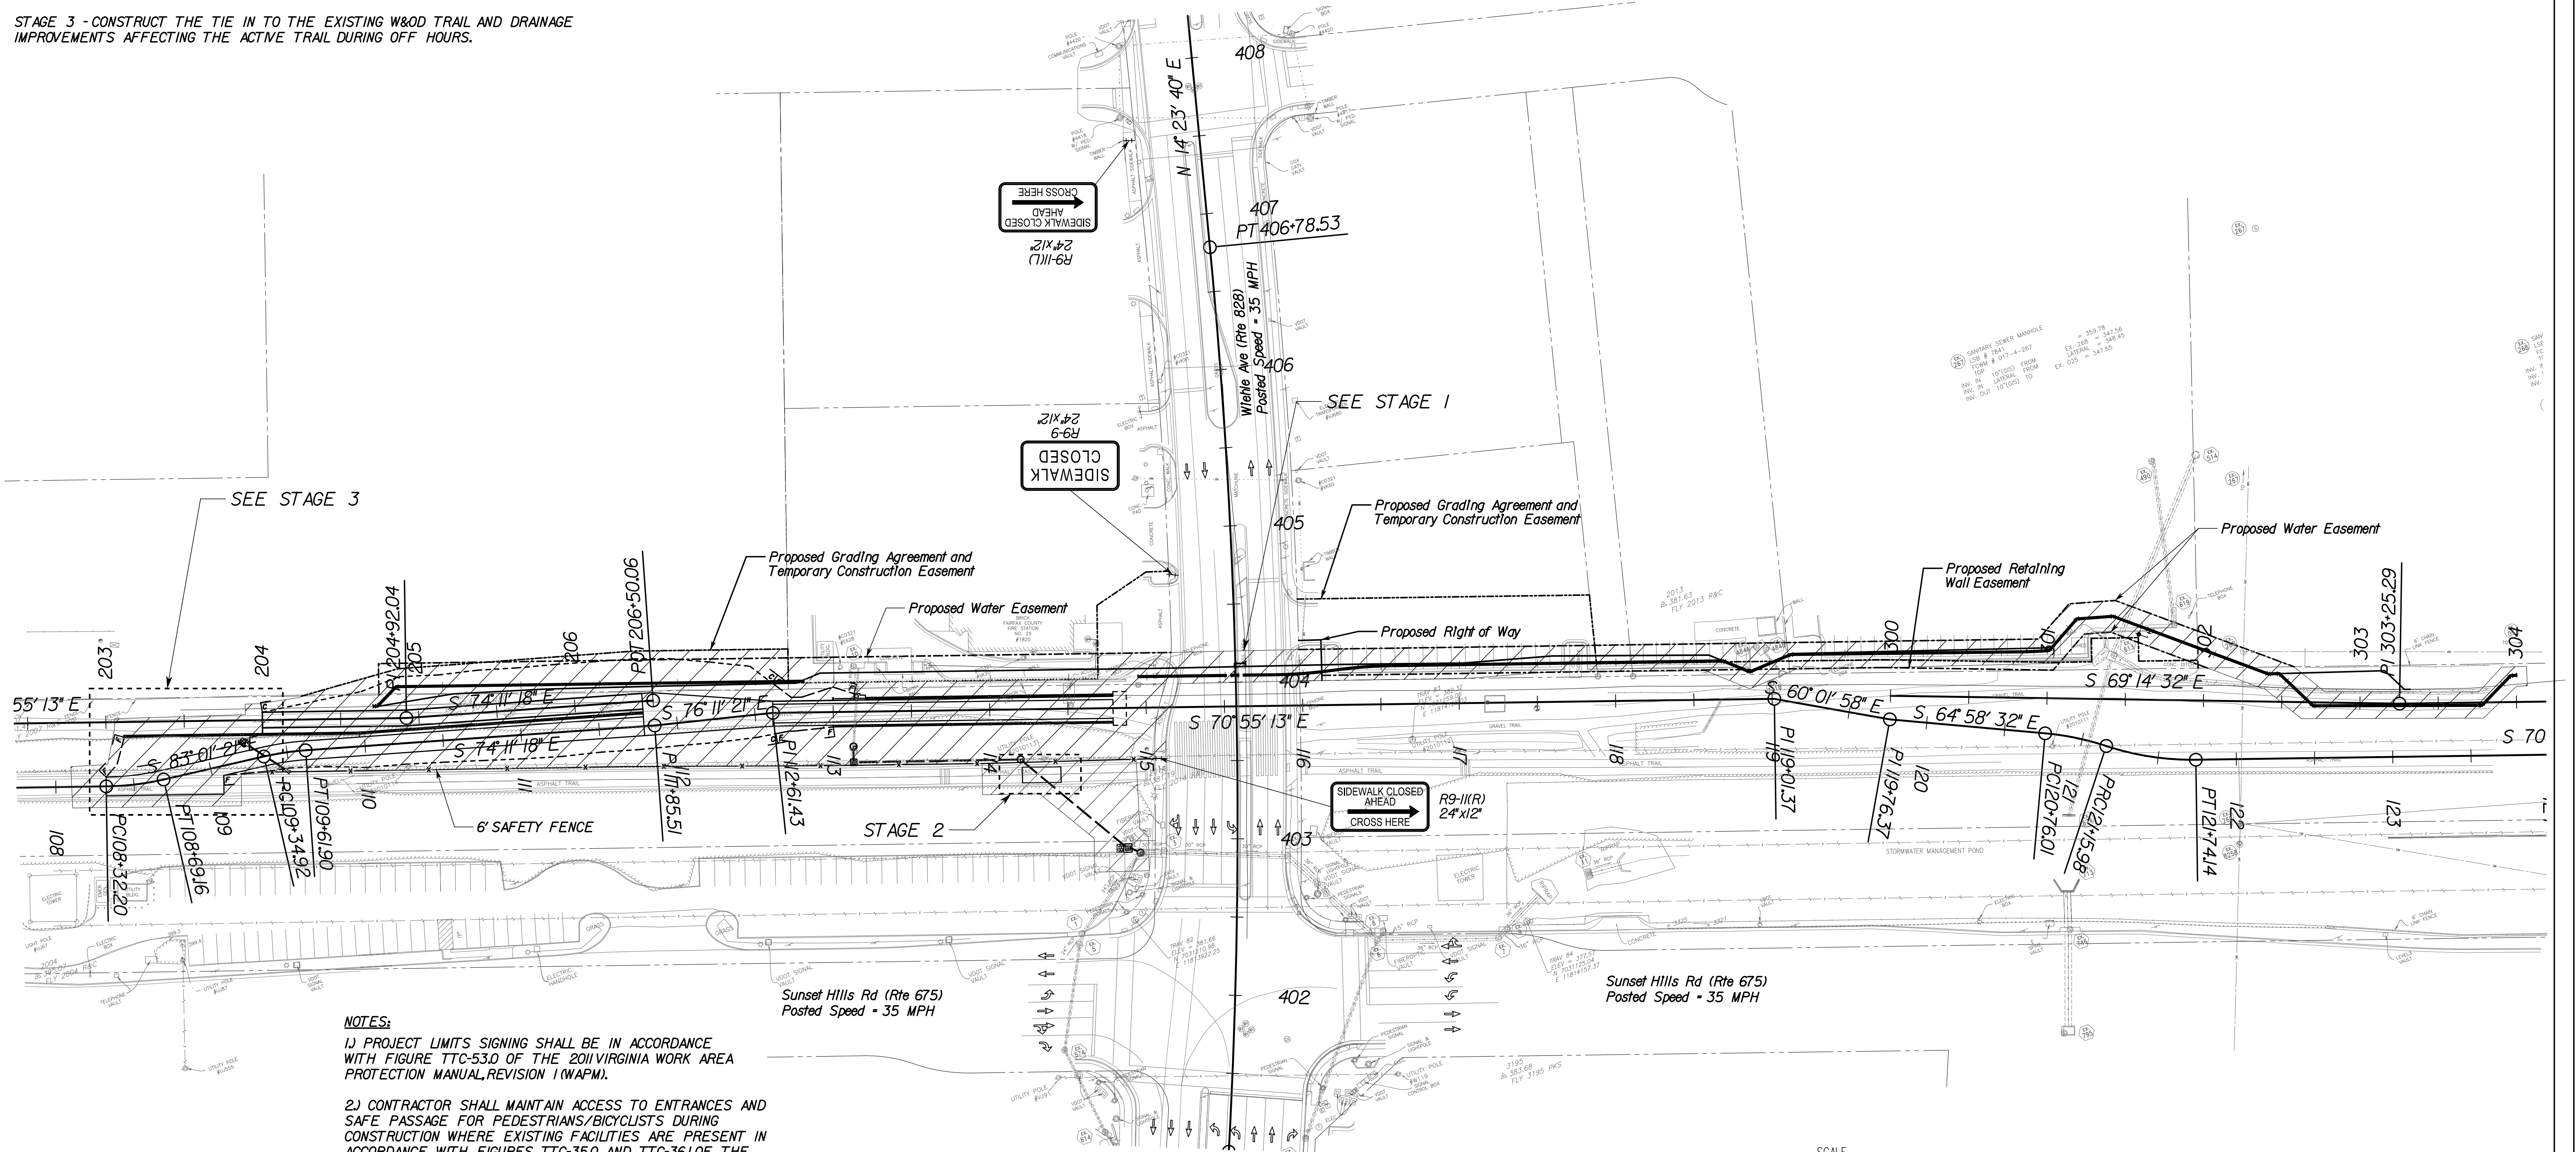
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Fairfax, Virginia  
ROADWAY ENGINEER




### NOTES:


- 1) PROJECT LIMITS SIGNING SHALL BE IN ACCORDANCE WITH FIGURE TTC-53.0 OF THE 2011 VIRGINIA WORK AREA PROTECTION MANUAL, REVISION 1 (WAPM).
- 2) CONTRACTOR SHALL MAINTAIN ACCESS TO ENTRANCES AND SAFE PASSAGE FOR PEDESTRIANS/BICYCLISTS DURING CONSTRUCTION WHERE EXISTING FACILITIES ARE PRESENT IN ACCORDANCE WITH FIGURES TTC-35.0 AND TTC-36J OF THE 2011 VIRGINIA WORK AREA PROTECTION MANUAL, REVISION 1 (WAPM).
- 3) CLOSE GRAVEL TRAIL BETWEEN ISAAC NEWTON SQUARE AND WIEHLE AVENUE AND MICHAEL FARADAY COURT AND WIEHLE AVENUE.
- 4) PHASE 1 STAGE 2 TO BE COMPLETED OFF HOURS 9:00 PM - 5:00 AM MONDAY THRU THURSDAY.
- 5) FOR NIGHTTIME CLOSURE, TYPE A FLASHING WARNING LIGHTS MAY BE USED ON BARRICADES SUPPORTING SIGNS AND CLOSING SIDEWALKS.
- 6) CONTRACTOR SHALL COORDINATE ROAD CONSTRUCTION ACTIVITIES WITH FAIRFAX COUNTY FIRE STATION 25.
- 7) CONTRACTOR MAY PERFORM PHASE 1 AND PHASE 2 CONCURRENTLY AS LONG AS ONE SIDEWALK ALONG WIEHLE AVENUE REMAINS OPEN TO PEDESTRIAN USE AT ALL TIMES.
- 8) W&OD MAINLINE ASPHALT TRAIL SHALL REMAIN OPEN AT ALL TIMES.

### LEGEND

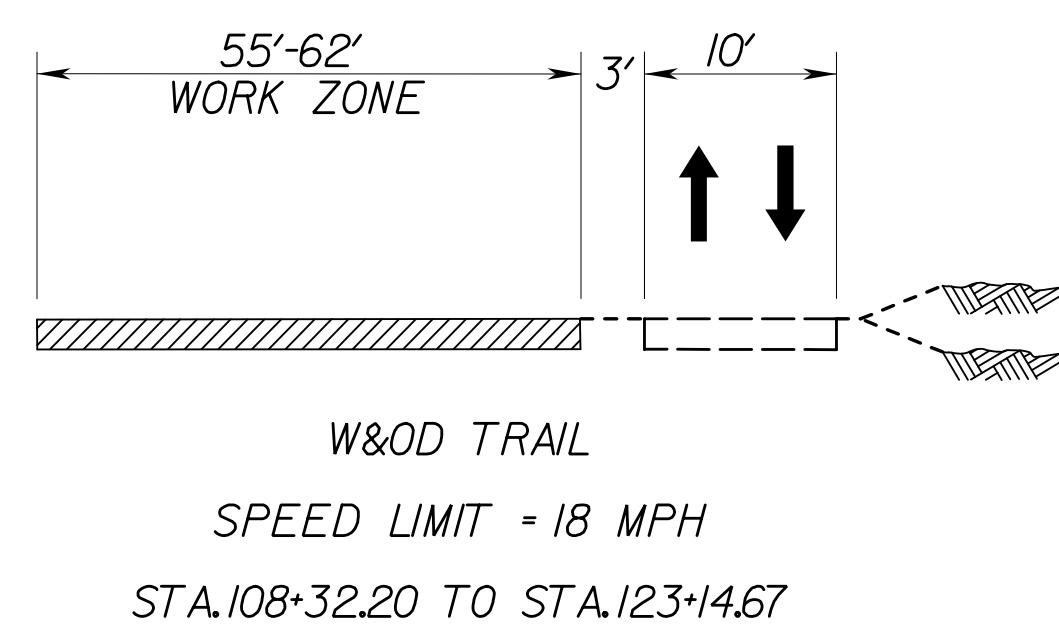- WORK ZONE AREA
- GROUP 2 CHANNELIZING DEVICE
- TYPE 3 BARRICADE
- ARROW BOARD ON TRAILER
- SIGN
- EXISTING DIRECTION OF TRAVEL
- TEMPORARY DIRECTION OF TRAVEL
- WORK VEHICLE



Whitman, Requardt & Associates, LLP

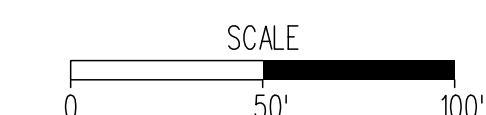

EMERGENCY POLICE - FIRE - RESCUE 911			
FAIRFAX COUNTY, VIRGINIA			
DEPARTMENT OF PUBLIC WORKS AND ENVIRONMENTAL SERVICES			
12000 GOVERNMENT CENTER PARKWAY, SUITE 449 FAIRFAX, VA., 22035-0052			
OFFICE OF CAPITAL FACILITIES		703-324-5800	
WIEHLE AVENUE (RTE 828)		AT W&OD TRAIL	
TRANSPORTATION MANAGEMENT PLAN		PROJECT NO: 1400102-2013	
SCALE 1"=50'		DESIGNED: NDD	SHEET 1H(4)
APPROVED BY THE TRANSPORTATION DESIGN DIVISION		DRAFTED: WRA	CHECKED: RBH

FUND # 500-C5000



PROJECT MANAGER: SCOTT RUEFFNER, P.E. (703) 877-5736  
SURVEYED BY: DATE: FAIRFAX COUNTY, NOVEMBER 28, 2014  
DESIGN BY: WHITMAN, REQUARDT & ASSOCIATES, LLP (703) 293-9717  
SUBSURFACE UTILITY BY: DATE: SO DEEP, INC. (703) 361-6005 DECEMBER 23, 2014

# TEMPORARY CONSTRUCTION PLAN

## PHASE 2


### PHASE 2 CONSTRUCTION ACTIVITIES:

STAGE 1 - CONSTRUCT THE DRAINAGE IMPROVEMENTS AS SHOWN ON THE PLANS.  
BUILD BRIDGE ABUTMENTS, MSE WALLS, AND TRAIL IMPROVEMENTS AS SHOWN ON THE PLANS.

STAGE 2 - CONSTRUCT THE TIE IN TO THE EXISTING W&OD TRAIL DURING OFF HOURS.




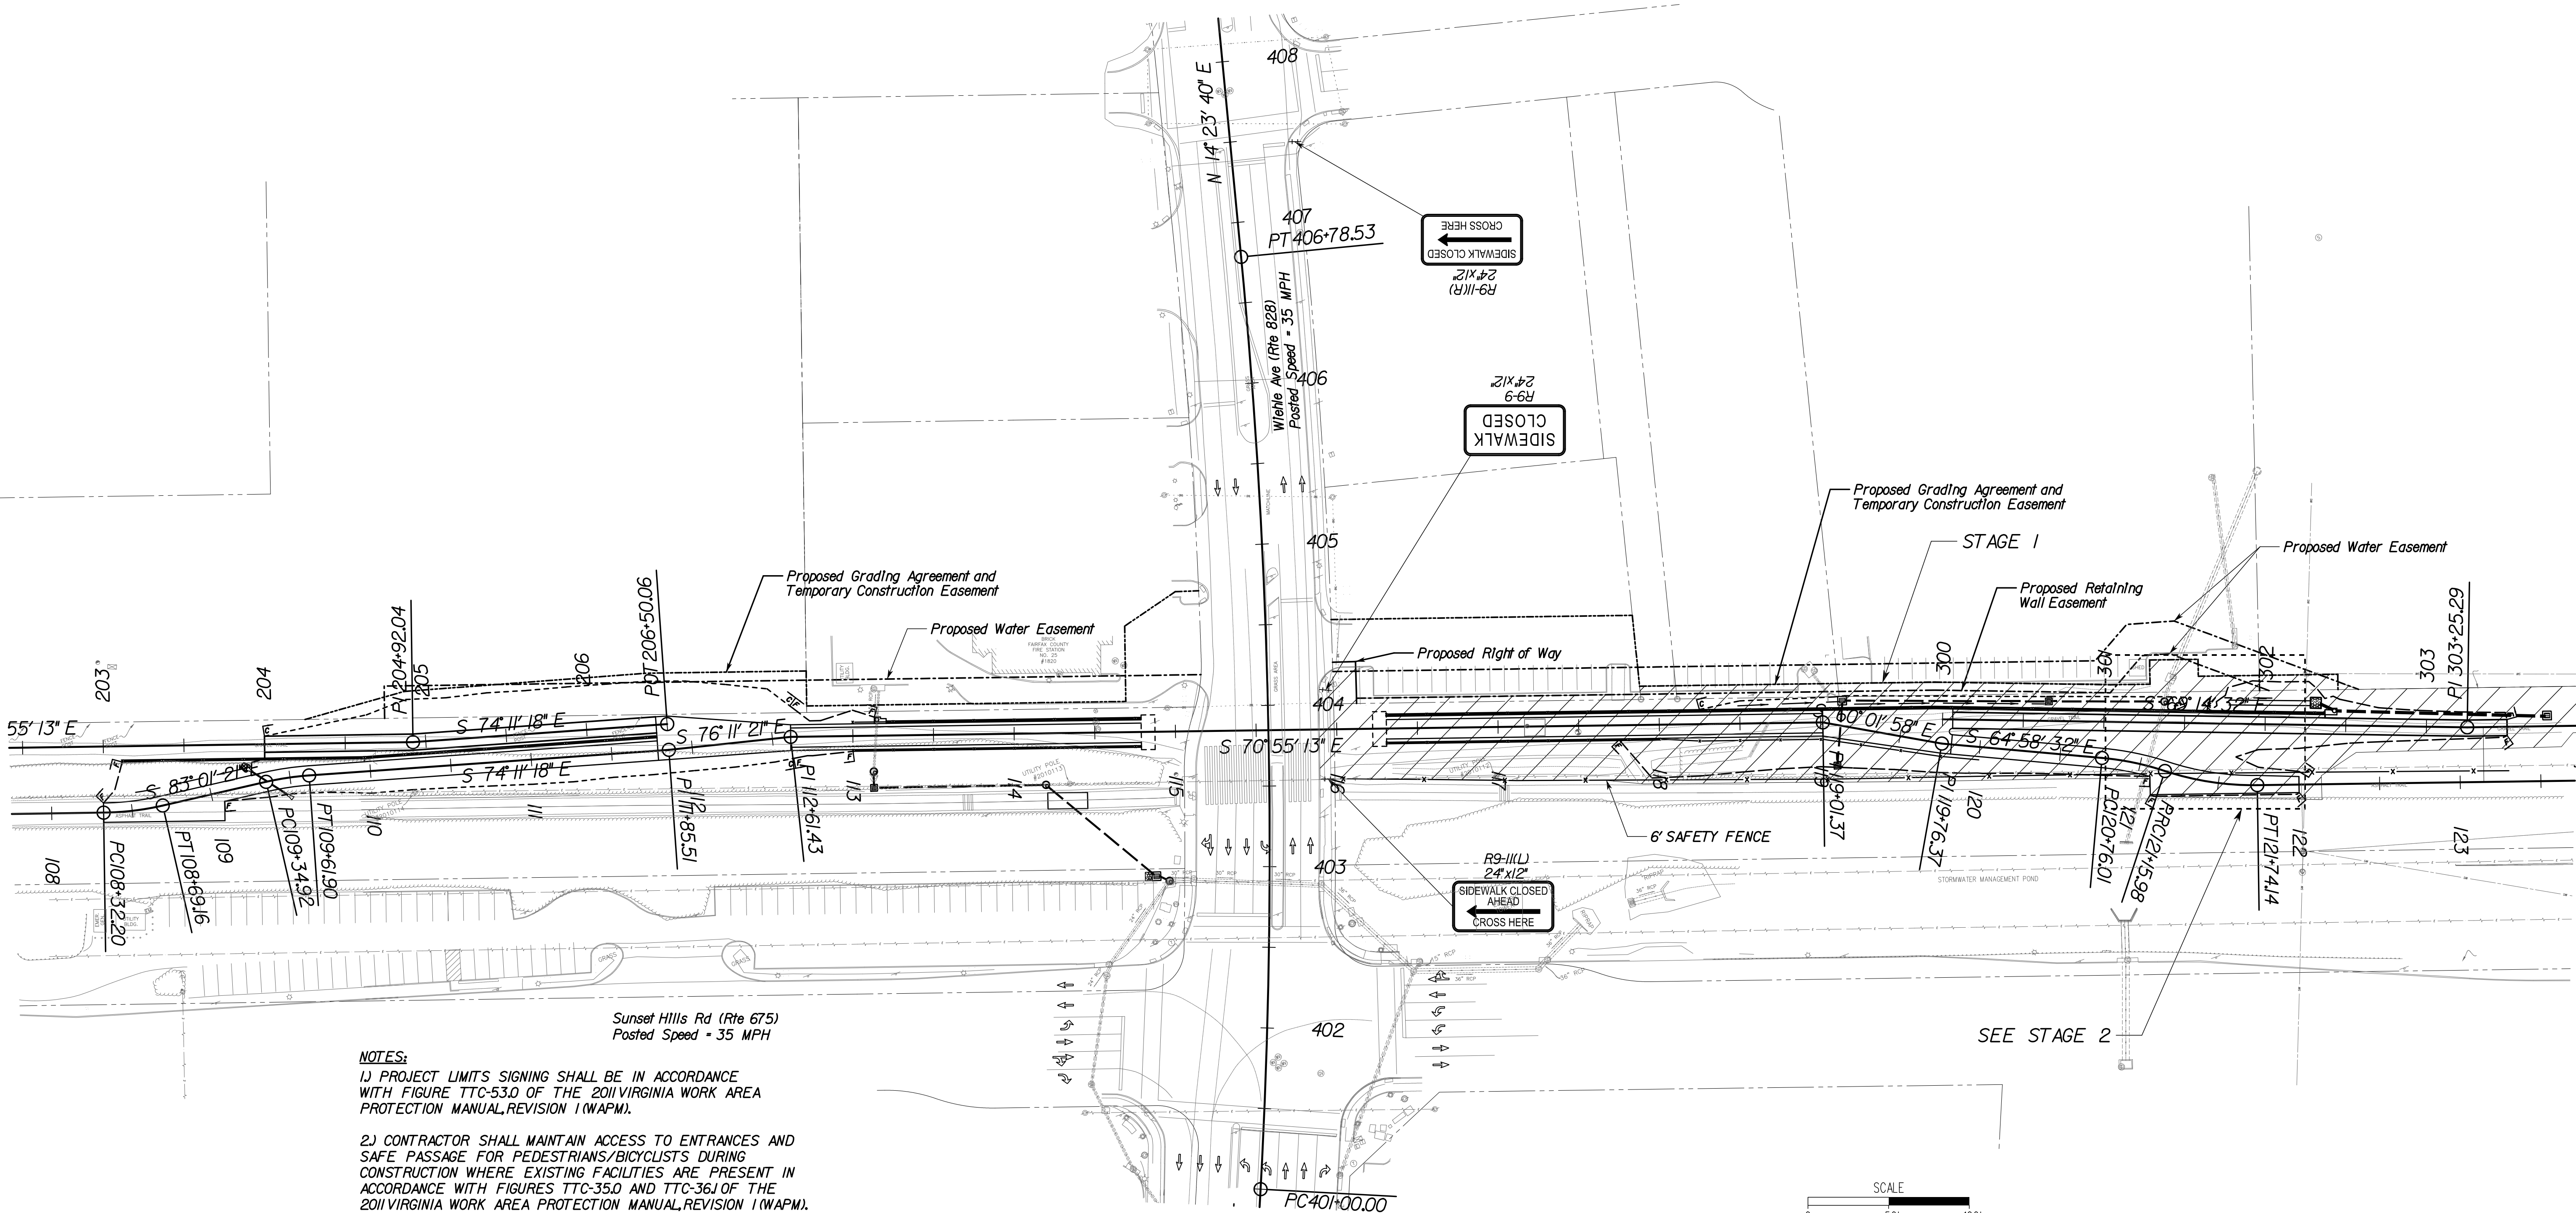Whitman Requardt & Associates  
Fairfax, Virginia  
ROADWAY ENGINEER




- NOTES:**
- 1) PROJECT LIMITS SIGNING SHALL BE IN ACCORDANCE WITH FIGURE TTC-53.0 OF THE 2011 VIRGINIA WORK AREA PROTECTION MANUAL, REVISION 1 (WAPM).
  - 2) CONTRACTOR SHALL MAINTAIN ACCESS TO ENTRANCES AND SAFE PASSAGE FOR PEDESTRIANS/BICYCLISTS DURING CONSTRUCTION WHERE EXISTING FACILITIES ARE PRESENT IN ACCORDANCE WITH FIGURES TTC-35.0 AND TTC-36.1 OF THE 2011 VIRGINIA WORK AREA PROTECTION MANUAL, REVISION 1 (WAPM).
  - 3) CLOSE GRAVEL TRAIL BETWEEN ISAAC NEWTON SQUARE AND WIEHLE AVENUE AND MICHAEL FARADAY COURT AND WIEHLE AVENUE.
  - 4) PHASE 2 STAGE 2 TO BE COMPLETED OFF HOURS: 9:00 PM - 5:00 AM MONDAY THRU THURSDAY.
  - 5) FOR NIGHTTIME CLOSURE, TYPE A FLASHING WARNING LIGHTS MAY BE USED ON BARRICADES SUPPORTING SIGNS AND CLOSING SIDEWALKS.
  - 6) CONTRACTOR SHALL COORDINATE CONSTRUCTION ACTIVITIES WITH FAIRFAX COUNTY FIRE STATION 25.
  - 7) CONTRACTOR MAY PERFORM PHASE 1 AND PHASE 2 CONCURRENTLY AS LONG AS ONE SIDEWALK ALONG WIEHLE AVENUE REMAINS OPEN TO PEDESTRIAN USE AT ALL TIMES.
  - 8) W&OD MAINLINE ASPHALT TRAIL SHALL REMAIN OPEN AT ALL TIMES.

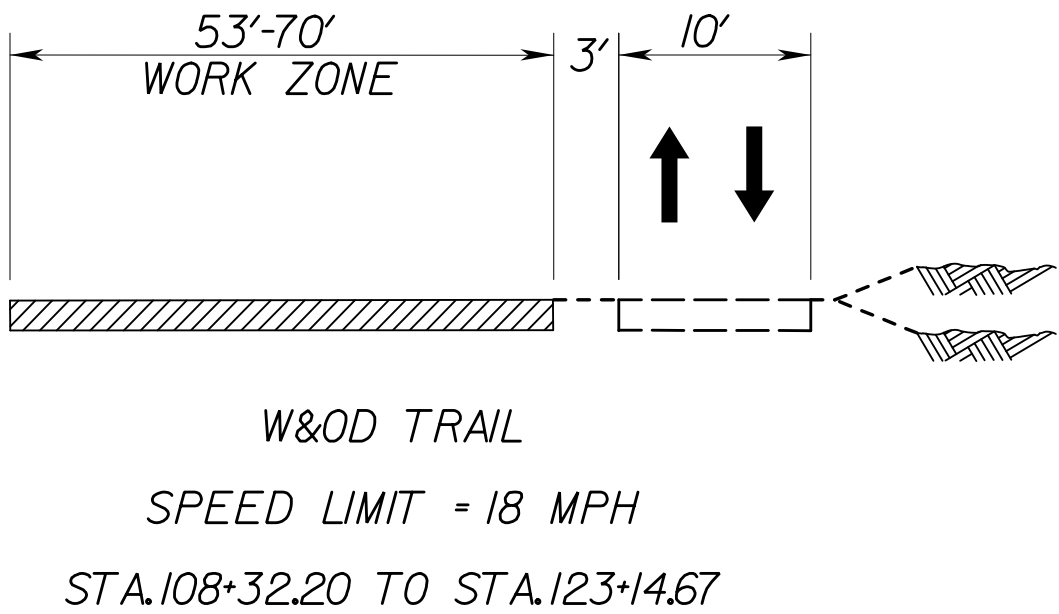- LEGEND**
- WORK ZONE AREA
  - GROUP 2 CHANNELIZING DEVICE
  - TYPE 3 BARRICADE
  - ARROW BOARD ON TRAILER
  - SIGN
  - EXISTING DIRECTION OF TRAVEL
  - TEMPORARY DIRECTION OF TRAVEL
  - WORK VEHICLE



Whitman, Requardt & Associates, LLP

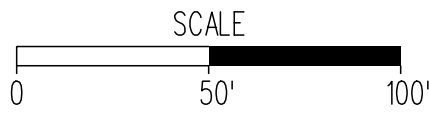

EMERGENCY POLICE - FIRE - RESCUE 911			
FAIRFAX COUNTY, VIRGINIA			
DEPARTMENT OF PUBLIC WORKS AND ENVIRONMENTAL SERVICES			
12000 GOVERNMENT CENTER PARKWAY, SUITE 449 FAIRFAX, VA., 22035-0052			
OFFICE OF CAPITAL FACILITIES		703-324-5800	
WIEHLE AVENUE (RTE 828)		AT W&OD TRAIL	
TRANSPORTATION MANAGEMENT PLAN		PROJECT NO: 1400102-2013	
SCALE 1"=50'		DESIGNED: NDD	SHEET 1H(5)
APPROVED BY THE TRANSPORTATION DESIGN DIVISION		DRAFTED: WRA	CHECKED: RBH

FUND # 500-C5000



PROJECT MANAGER: SCOTT RUEFFNER, P.E. (703) 871-5736  
SURVEYED BY, DATE: FAIRFAX COUNTY, NOVEMBER 28, 2014  
DESIGN BY: WHITMAN, REQUARDT & ASSOCIATES, LLP (703) 293-9717  
SUBSURFACE UTILITY BY, DATE: SO DEEP, INC. (703) 361-6005, DECEMBER 23, 2014

# TEMPORARY CONSTRUCTION PLAN

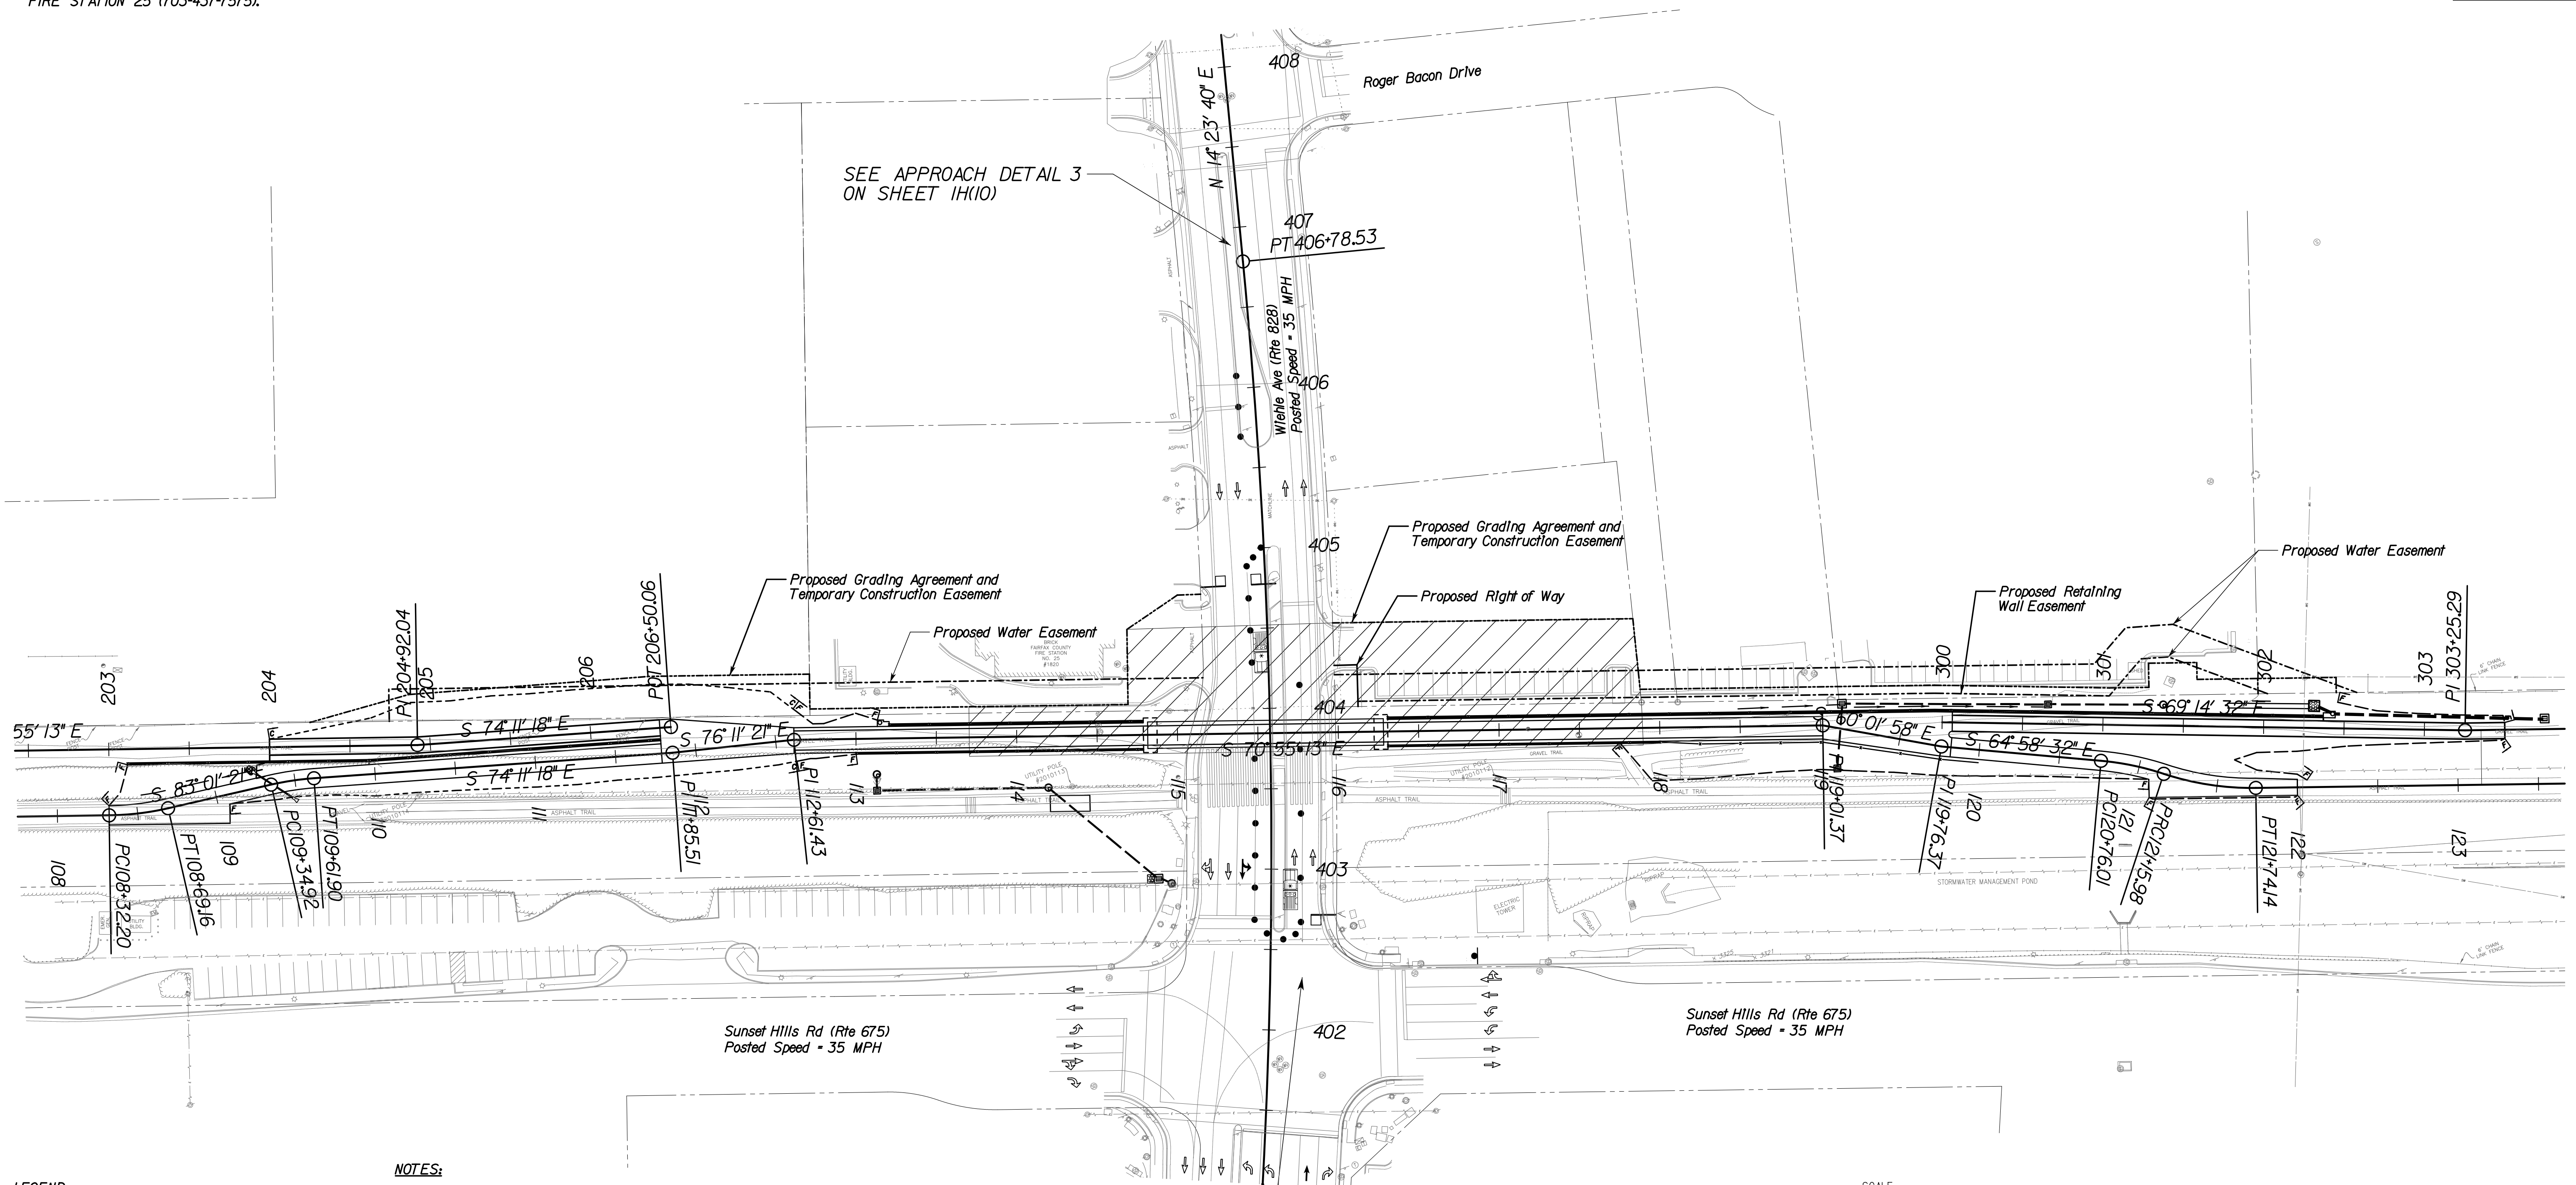
## PHASE 3

### PHASE 3 CONSTRUCTION ACTIVITIES:

THE CONTRACTOR SHALL SET UP A NIGHTTIME CLOSURE OF WIEHLE AVENUE BETWEEN SUNSET HILLS AND ROGER BACON DRIVE IN ACCORDANCE WITH FIGURE TTC-50.0 OF THE VA WAPM. INSTALL PREFABRICATED BRIDGE. THE CONTRACTOR SHALL COORDINATE THE ROAD CLOSURE WITH FAIRFAX COUNTY FIRE STATION 25 (703-437-7575).



Whitman Requardt & Associates  
Fairfax, Virginia  
ROADWAY ENGINEER



LEGEND	
	WORK ZONE AREA
	GROUP 2 CHANNELIZING DEVICE
	FLAGGER SERVICE
	TYPE 3 BARRICADE
	ARROW BOARD ON TRAILER
	SIGN
	EXISTING DIRECTION OF TRAVEL
	TEMPORARY DIRECTION OF TRAVEL
	WORK VEHICLE


### NOTES:

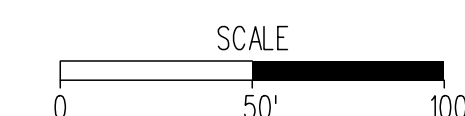- 1) PROJECT LIMITS SIGNING SHALL BE IN ACCORDANCE WITH FIGURE TTC-53.0 OF THE 2011 VIRGINIA WORK AREA PROTECTION MANUAL, REVISION 1 (WAPM).
- 2) CONTRACTOR SHALL MAINTAIN ACCESS TO ENTRANCES AND SAFE PASSAGE FOR PEDESTRIANS/BICYCLISTS DURING CONSTRUCTION WHERE EXISTING FACILITIES ARE PRESENT IN ACCORDANCE WITH FIGURES TTC-35.0 AND TTC-36.1 OF THE 2011 VIRGINIA WORK AREA PROTECTION MANUAL, REVISION 1 (WAPM).
- 3) DISRUPTION OPERATION ON A MULTI-LANE ROADWAY SHALL BE IN ACCORDANCE WITH TTC-50.0 AND PERFORMED DURING OFF HOURS.
- 4) CONTRACTOR SHALL UTILIZE POLICE ASSISTANCE FOR CLOSING WIEHLE AVENUE. CONTRACTOR SHALL REQUEST POLICE OFFICER PLACE VEHICLE IN FRONT OF ROAD CLOSURE SIGNS ON THE NORTH AND SOUTH SIDE OF THE WORK ZONE.

SEE APPROACH DETAIL 3  
ON SHEET 1H(10)

5) CONTRACTOR SHALL COORDINATE ROAD CLOSURE WITH FAIRFAX COUNTY FIRE STATION 25.

6) THE CONTRACTOR WILL HAVE THE UNENCUMBERED USE OF THE PARKING AREA ALONG THE SOUTH SIDE OF PARCEL \*0174-15-05-003A (PIZZA HUT), DURING THE BRIDGE ASSEMBLY ACTIVITY. ACCESS TO THE PIZZA HUT ENTRANCE SHALL BE MAINTAINED AT ALL TIMES DURING BUSINESS HOURS. THE REDUCTION IN PARKING FOR THIS PROPERTY SHALL NOT EXTEND FOR A PERIOD GREATER THAN 21 CALENDAR DAYS OR UPON INSTALLATION OF THE COMPLETED BRIDGE, WHICHEVER OCCURS FIRST.



EMERGENCY POLICE - FIRE - RESCUE 911			
FAIRFAX COUNTY, VIRGINIA			
DEPARTMENT OF PUBLIC WORKS AND ENVIRONMENTAL SERVICES			
12000 GOVERNMENT CENTER PARKWAY, SUITE 449 FAIRFAX, VA., 22035-0052			
OFFICE OF CAPITAL FACILITIES 703-324-5800			
WIEHLE AVENUE (RTE 828) AT W&OD TRAIL TRANSPORTATION MANAGEMENT PLAN PROJECT NO: 1400102-2013			
SCALE 1"=50'		DESIGNED: NDD DRAFTED: WRA CHECKED: RBH	SHEET 1H(6)
APPROVED BY THE TRANSPORTATION DESIGN DIVISION			


FUND # 500-C5000



PROJECT MANAGER: SCOTT RUEFFNER, P.E. (703) 871-5736  
SURVEYED BY: DATE: FAIRFAX COUNTY, NOVEMBER 28, 2014  
DESIGN BY: WHITMAN, REQUARDT & ASSOCIATES, LLP (703) 293-9717  
SUBSURFACE UTILITY BY: DATE: SO DEEP, INC. (703) 361-6005 DECEMBER 23, 2014



# TEMPORARY CONSTRUCTION PLAN PHASE 4

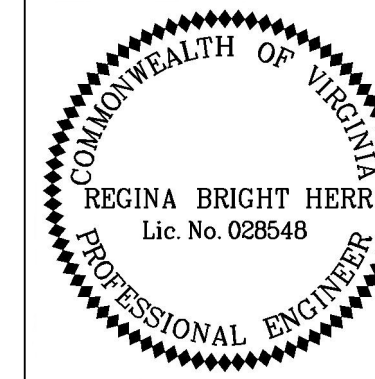



Whitman Requardt & Associates  
Fairfax, Virginia  
ROADWAY ENGINEER

## NOTES:

STAGE 1 - CLOSE THE RIGHT TURN LANE ON SOUTHBOUND WIEHLE AVENUE IN ACCORDANCE WITH FIGURE TTC-29J OF THE VA WAPM AS NEEDED. CONSTRUCT THE NEW PAVEMENT, CURB AND GUTTER, SIDEWALK AND CURB RAMPS ON THE WEST SIDE OF WIEHLE AVENUE.

STAGE 2 - CLOSE THE OUTSIDE LANE ON NORTHBOUND WIEHLE AVENUE IN ACCORDANCE WITH FIGURE TTC-27J OF THE VA WAPM AS NEEDED. CONSTRUCT THE NEW PAVEMENT, CURB AND GUTTER, SIDEWALK AND CURB RAMPS ON THE EAST SIDE OF WIEHLE AVENUE.
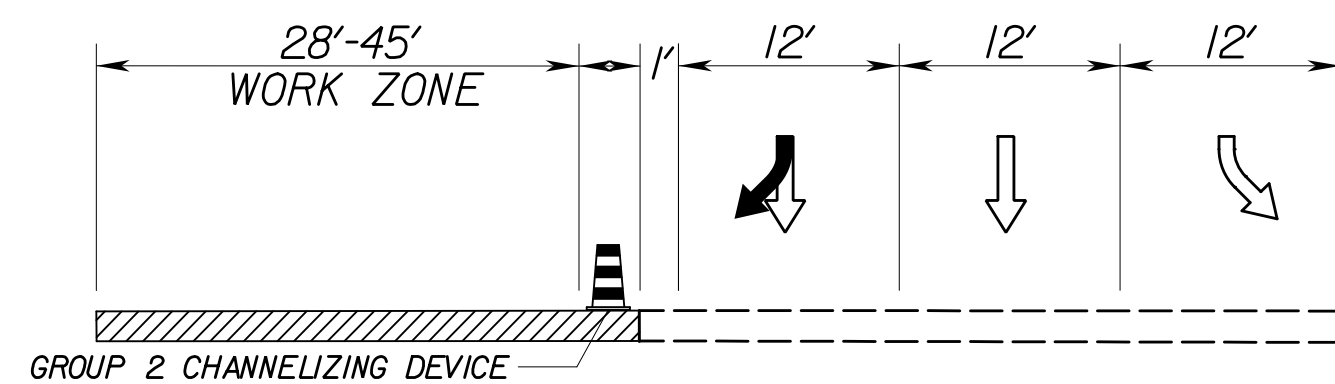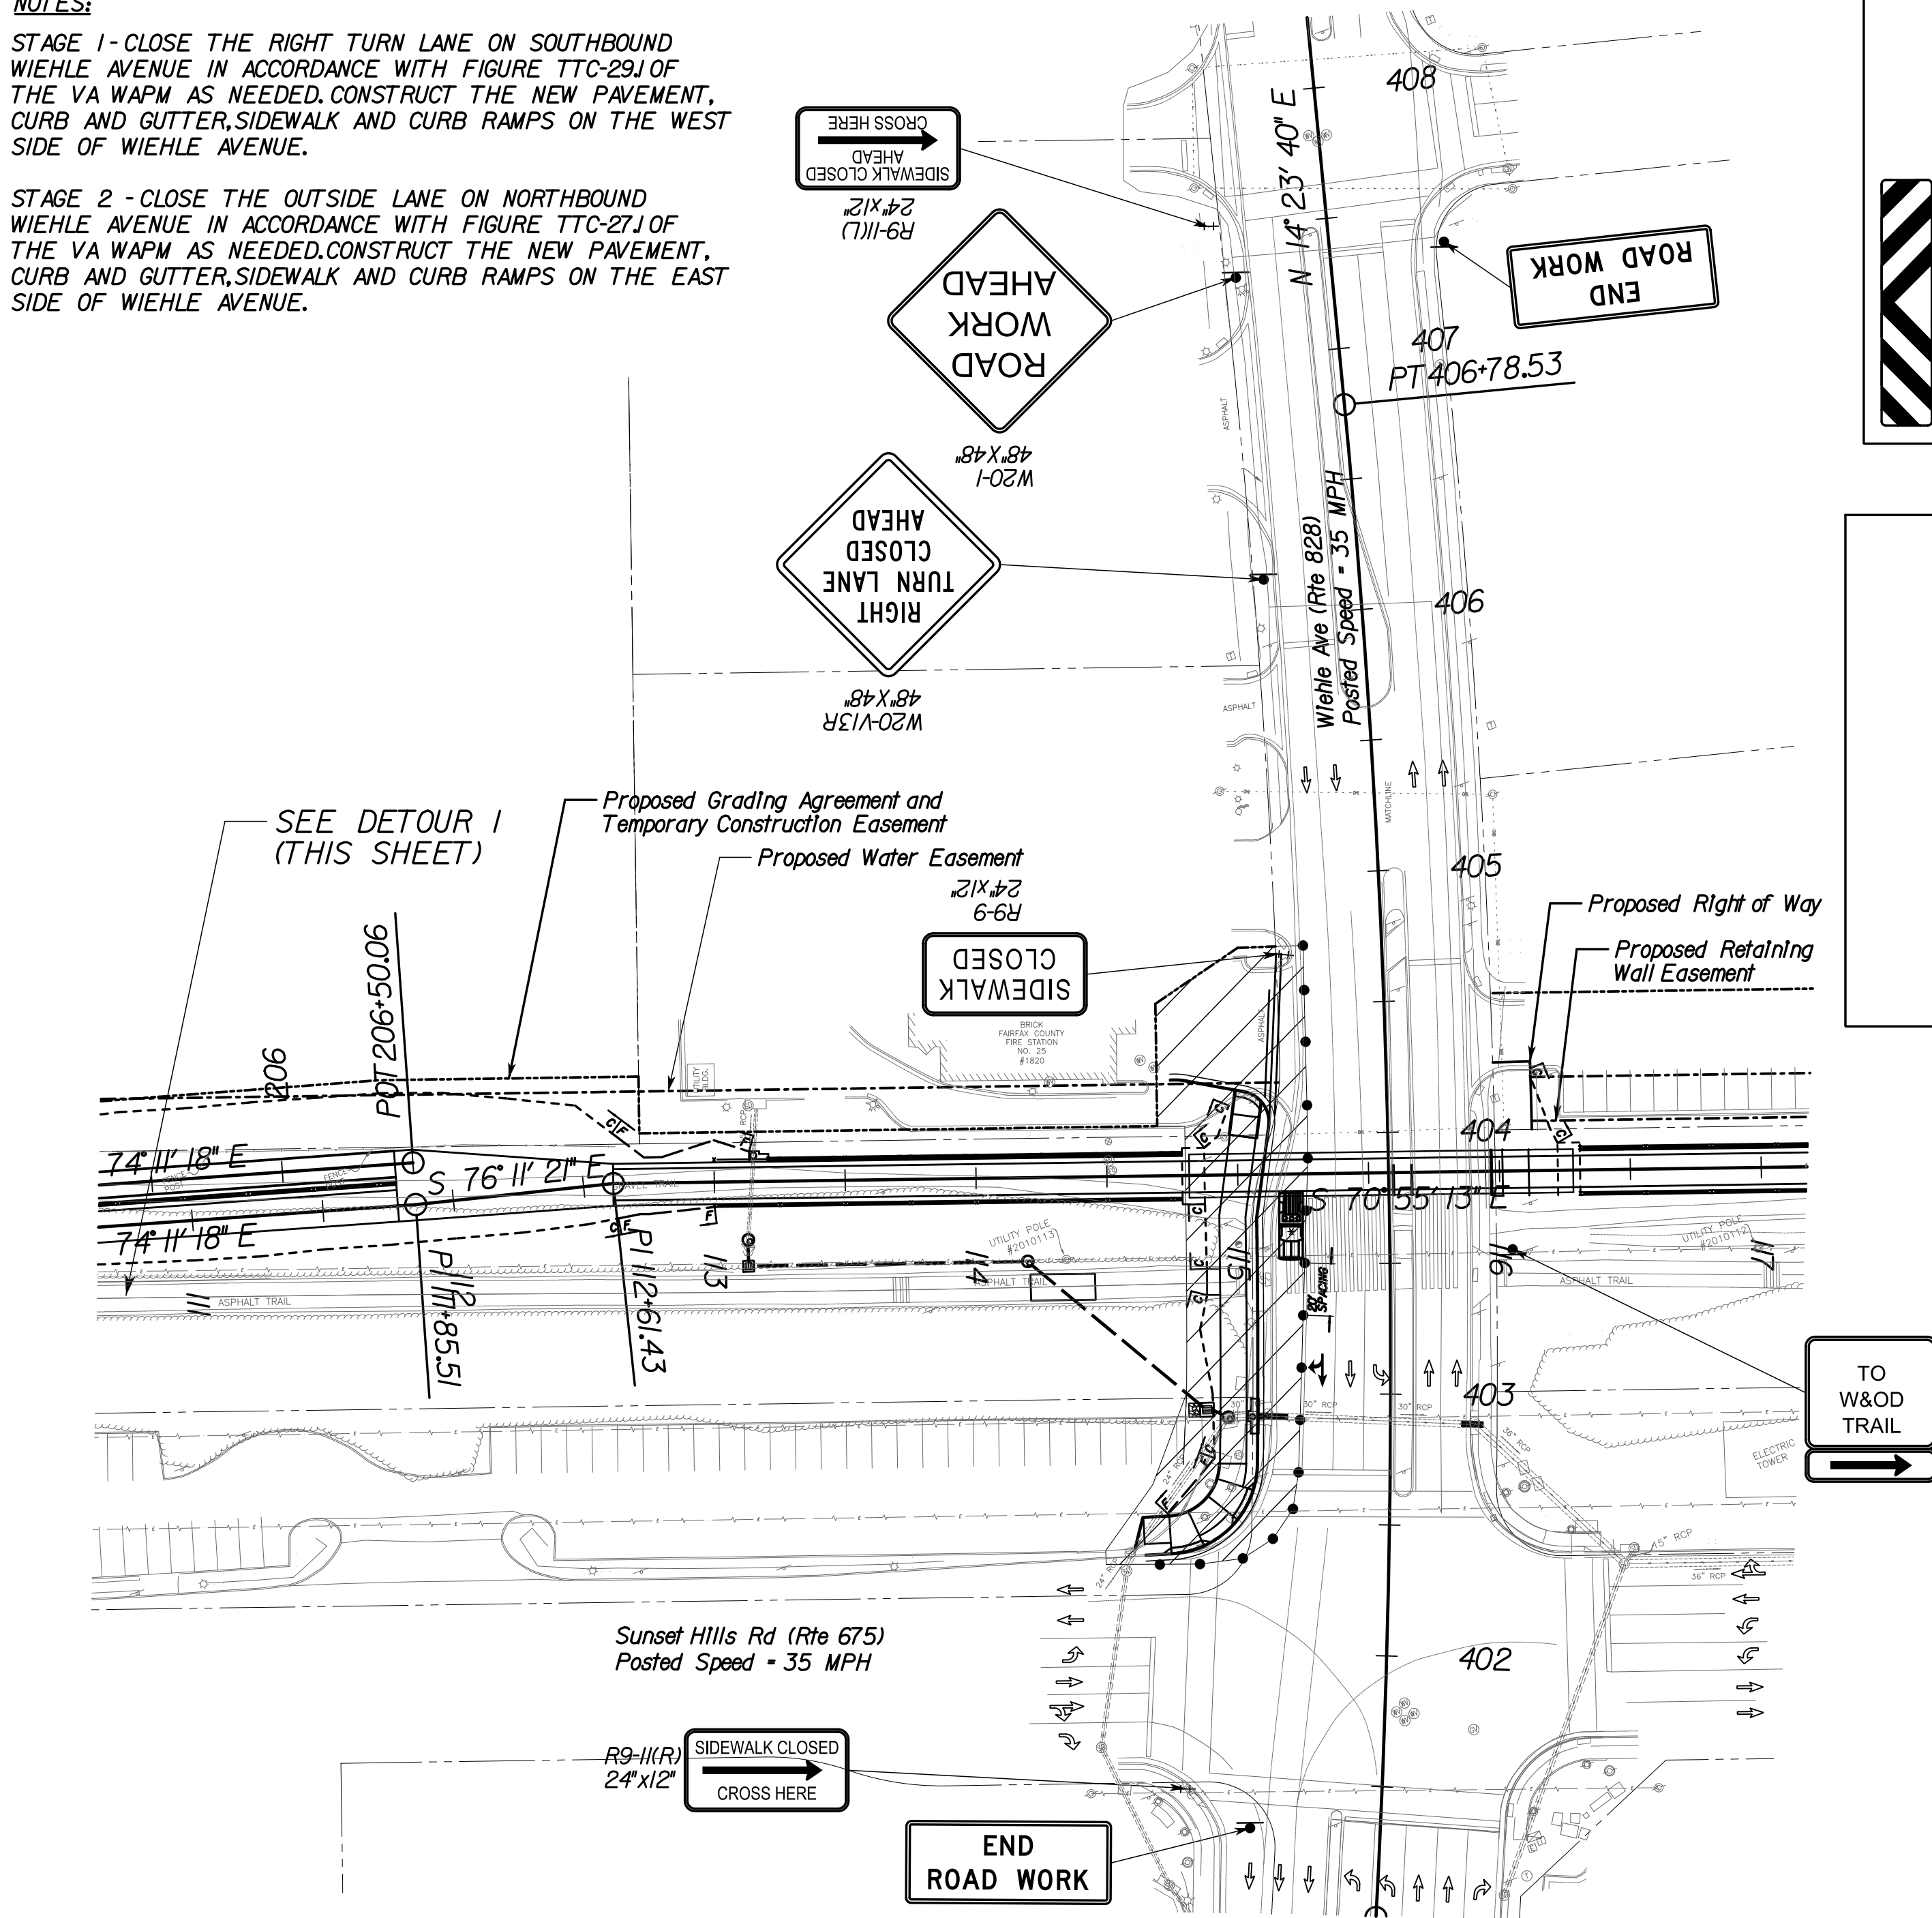
## STAGE 1



STAGE 1

UTILIZING TTC 29J - TURN LANE CLOSURE

SOUTHBOUND WIEHLE AVENUE


SPEED LIMIT = 35 MPH

STA. 402+33.31 TO STA. 404+19.78



## LEGEND

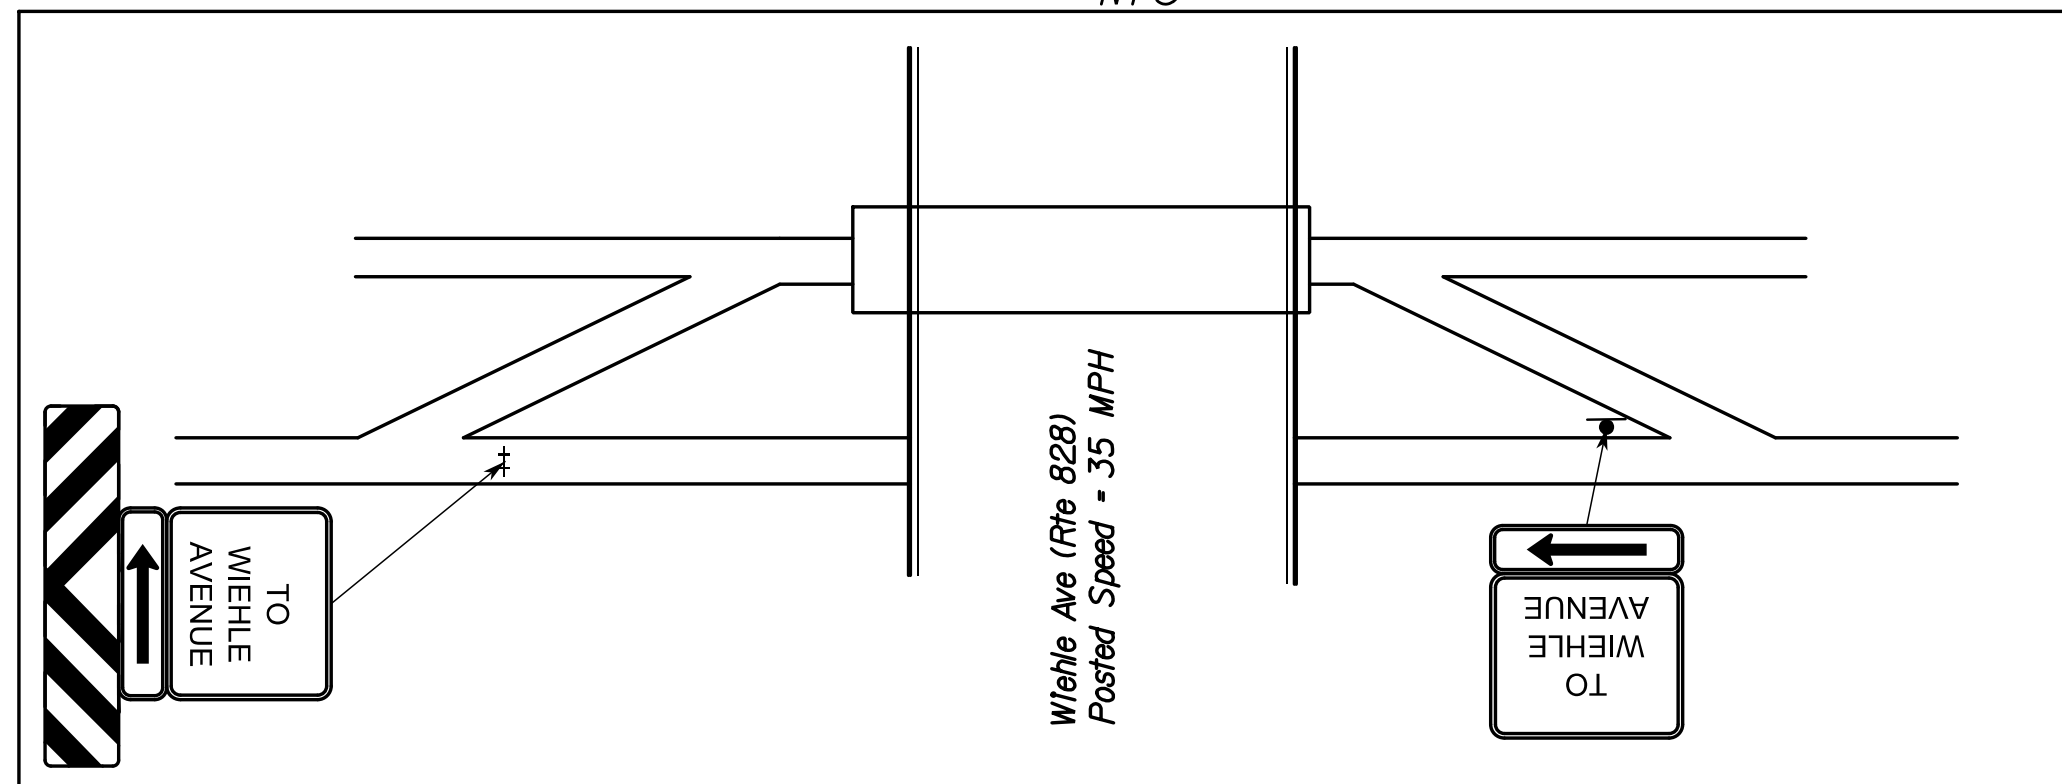- WORK ZONE AREA
- GROUP 2 CHANNELIZING DEVICE
- TYPE 3 BARRICADE
- ARROW BOARD ON TRAILER
- SIGN
- EXISTING DIRECTION OF TRAVEL
- TEMPORARY DIRECTION OF TRAVEL
- WORK VEHICLE

## DETOUR 1 NTS



## DETOUR 2 NTS

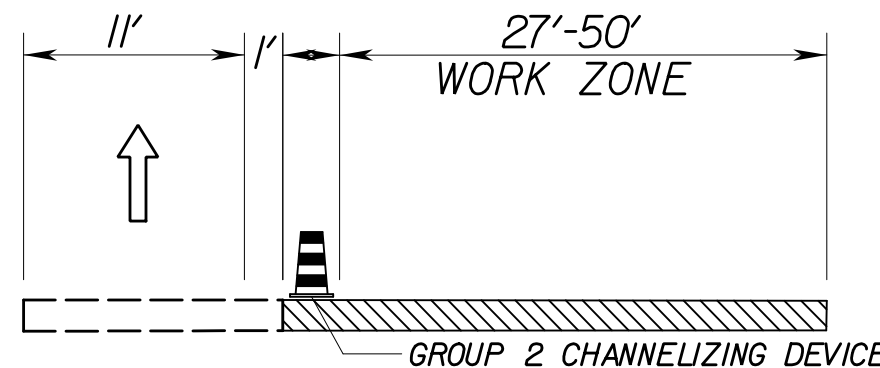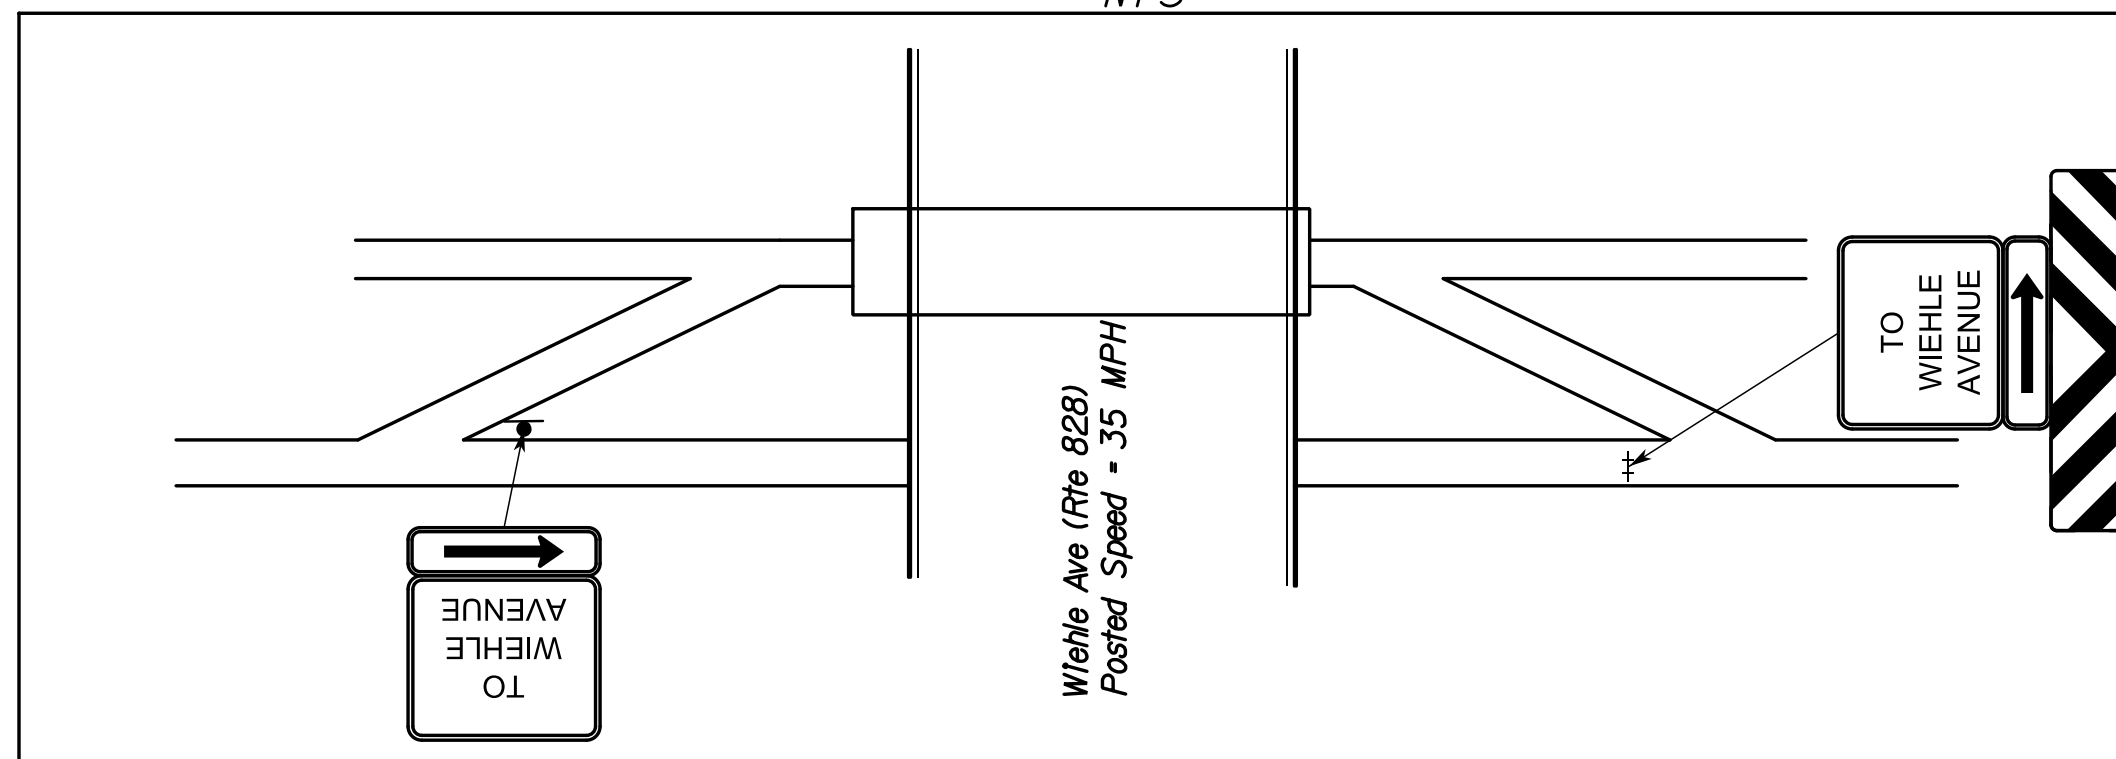

STAGE 2

UTILIZING TTC 27J - LANE CLOSURE ON  
THE FAR SIDE OF AN INTERSECTION

NORTHBOUND WIEHLE AVENUE


SPEED LIMIT = 35 MPH

STA. 402+34.42 TO STA. 404+25.50

## NOTES:

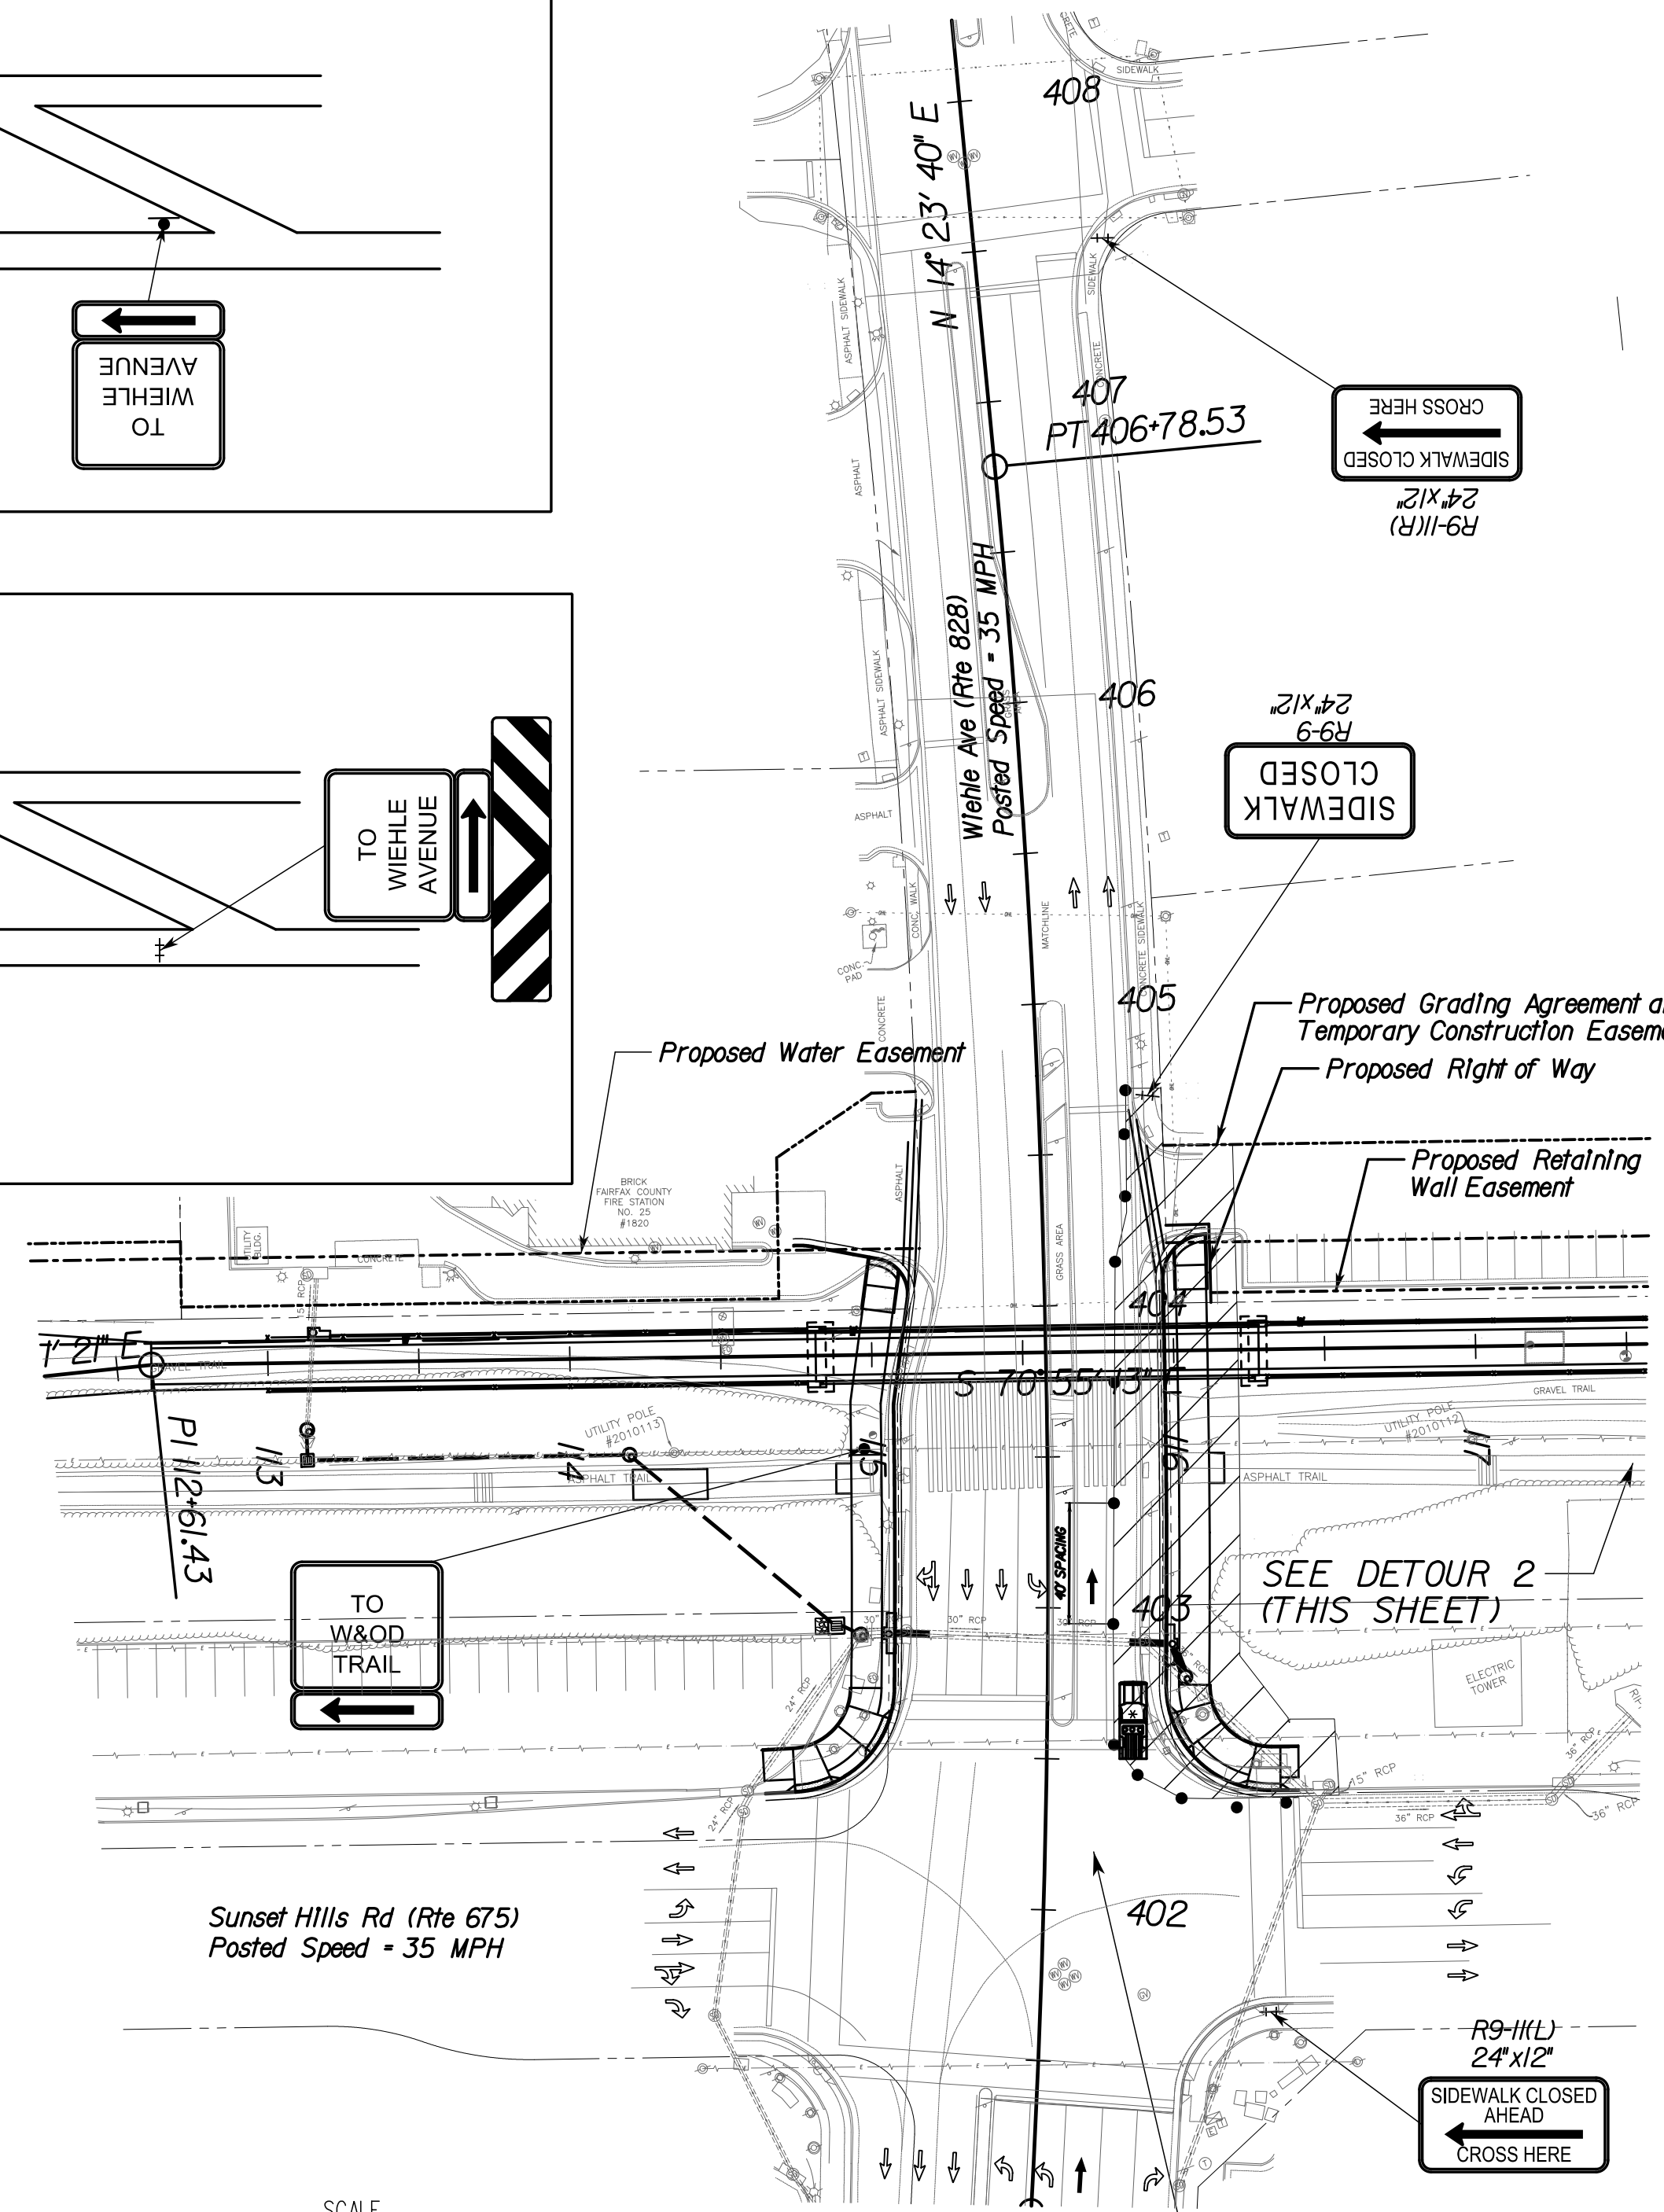- 1J PROJECT LIMITS SIGNING SHALL BE IN ACCORDANCE WITH FIGURE TTC-53.0 OF THE 2011 VIRGINIA WORK AREA PROTECTION MANUAL, REVISION 1 (WAPM).
- 2J CONTRACTOR SHALL MAINTAIN ACCESS TO ENTRANCES AND SAFE PASSAGE FOR PEDESTRIANS/BICYCLISTS DURING CONSTRUCTION WHERE EXISTING FACILITIES ARE PRESENT IN ACCORDANCE WITH FIGURES TTC-35.0 AND TTC-36J OF THE 2011 VIRGINIA WORK AREA PROTECTION MANUAL, REVISION 1 (WAPM).
- 3J CONTRACTOR SHALL CLOSE THE RIGHT TURN LANE ON SOUTHBOUND WIEHLE AVENUE IN ACCORDANCE WITH FIGURE TTC-29J OF THE VA WAPM.
- 4J CONTRACTOR SHALL CLOSE THE OUTSIDE LANE ON NORTHBOUND WIEHLE AVENUE IN ACCORDANCE WITH FIGURE TTC-27J OF THE VA WAPM.
- 5J FOR NIGHTTIME CLOSURE, TYPE A FLASHING WARNING LIGHTS MAY BE USED ON BARRICADES SUPPORTING SIGNS AND CLOSING SIDEWALKS.
- 6J CONTRACTOR SHALL COORDINATE ROAD CONSTRUCTION ACTIVITIES WITH FAIRFAX COUNTY FIRE STATION 25.
- 7J W&OD MAINLINE ASPHALT TRAIL SHALL REMAIN OPEN AT ALL TIMES.

## STAGE 2



EMERGENCY POLICE - FIRE - RESCUE 911

FAIRFAX COUNTY, VIRGINIA  
DEPARTMENT OF PUBLIC WORKS AND ENVIRONMENTAL SERVICES  
12000 GOVERNMENT CENTER PARKWAY, SUITE 449 FAIRFAX, VA., 22035-0052

OFFICE OF CAPITAL FACILITIES  
703-324-5800

WIEHLE AVENUE (RTE 828)  
AT W&OD TRAIL  
TRANSPORTATION MANAGEMENT PLAN  
PROJECT NO: 1400102-2013

SCALE 1"=50'

DESIGNED: NDD  
DRAFTED: WRA  
CHECKED: RBH

SHEET  
1H(7)

FUND # 500-C5000



PROJECT MANAGER: SCOTT RUEFFNER, P.E. (703) 877-5736  
SURVEYED BY, DATE: FAIRFAX COUNTY, NOVEMBER 28, 2014  
DESIGN BY: WHITMAN, REQUARDT & ASSOCIATES, LLP (703) 293-9717  
SUBSURFACE UTILITY BY, DATE: SO DEEP, INC. (703) 361-6005, DECEMBER 23, 2014




# TEMPORARY CONSTRUCTION PLAN
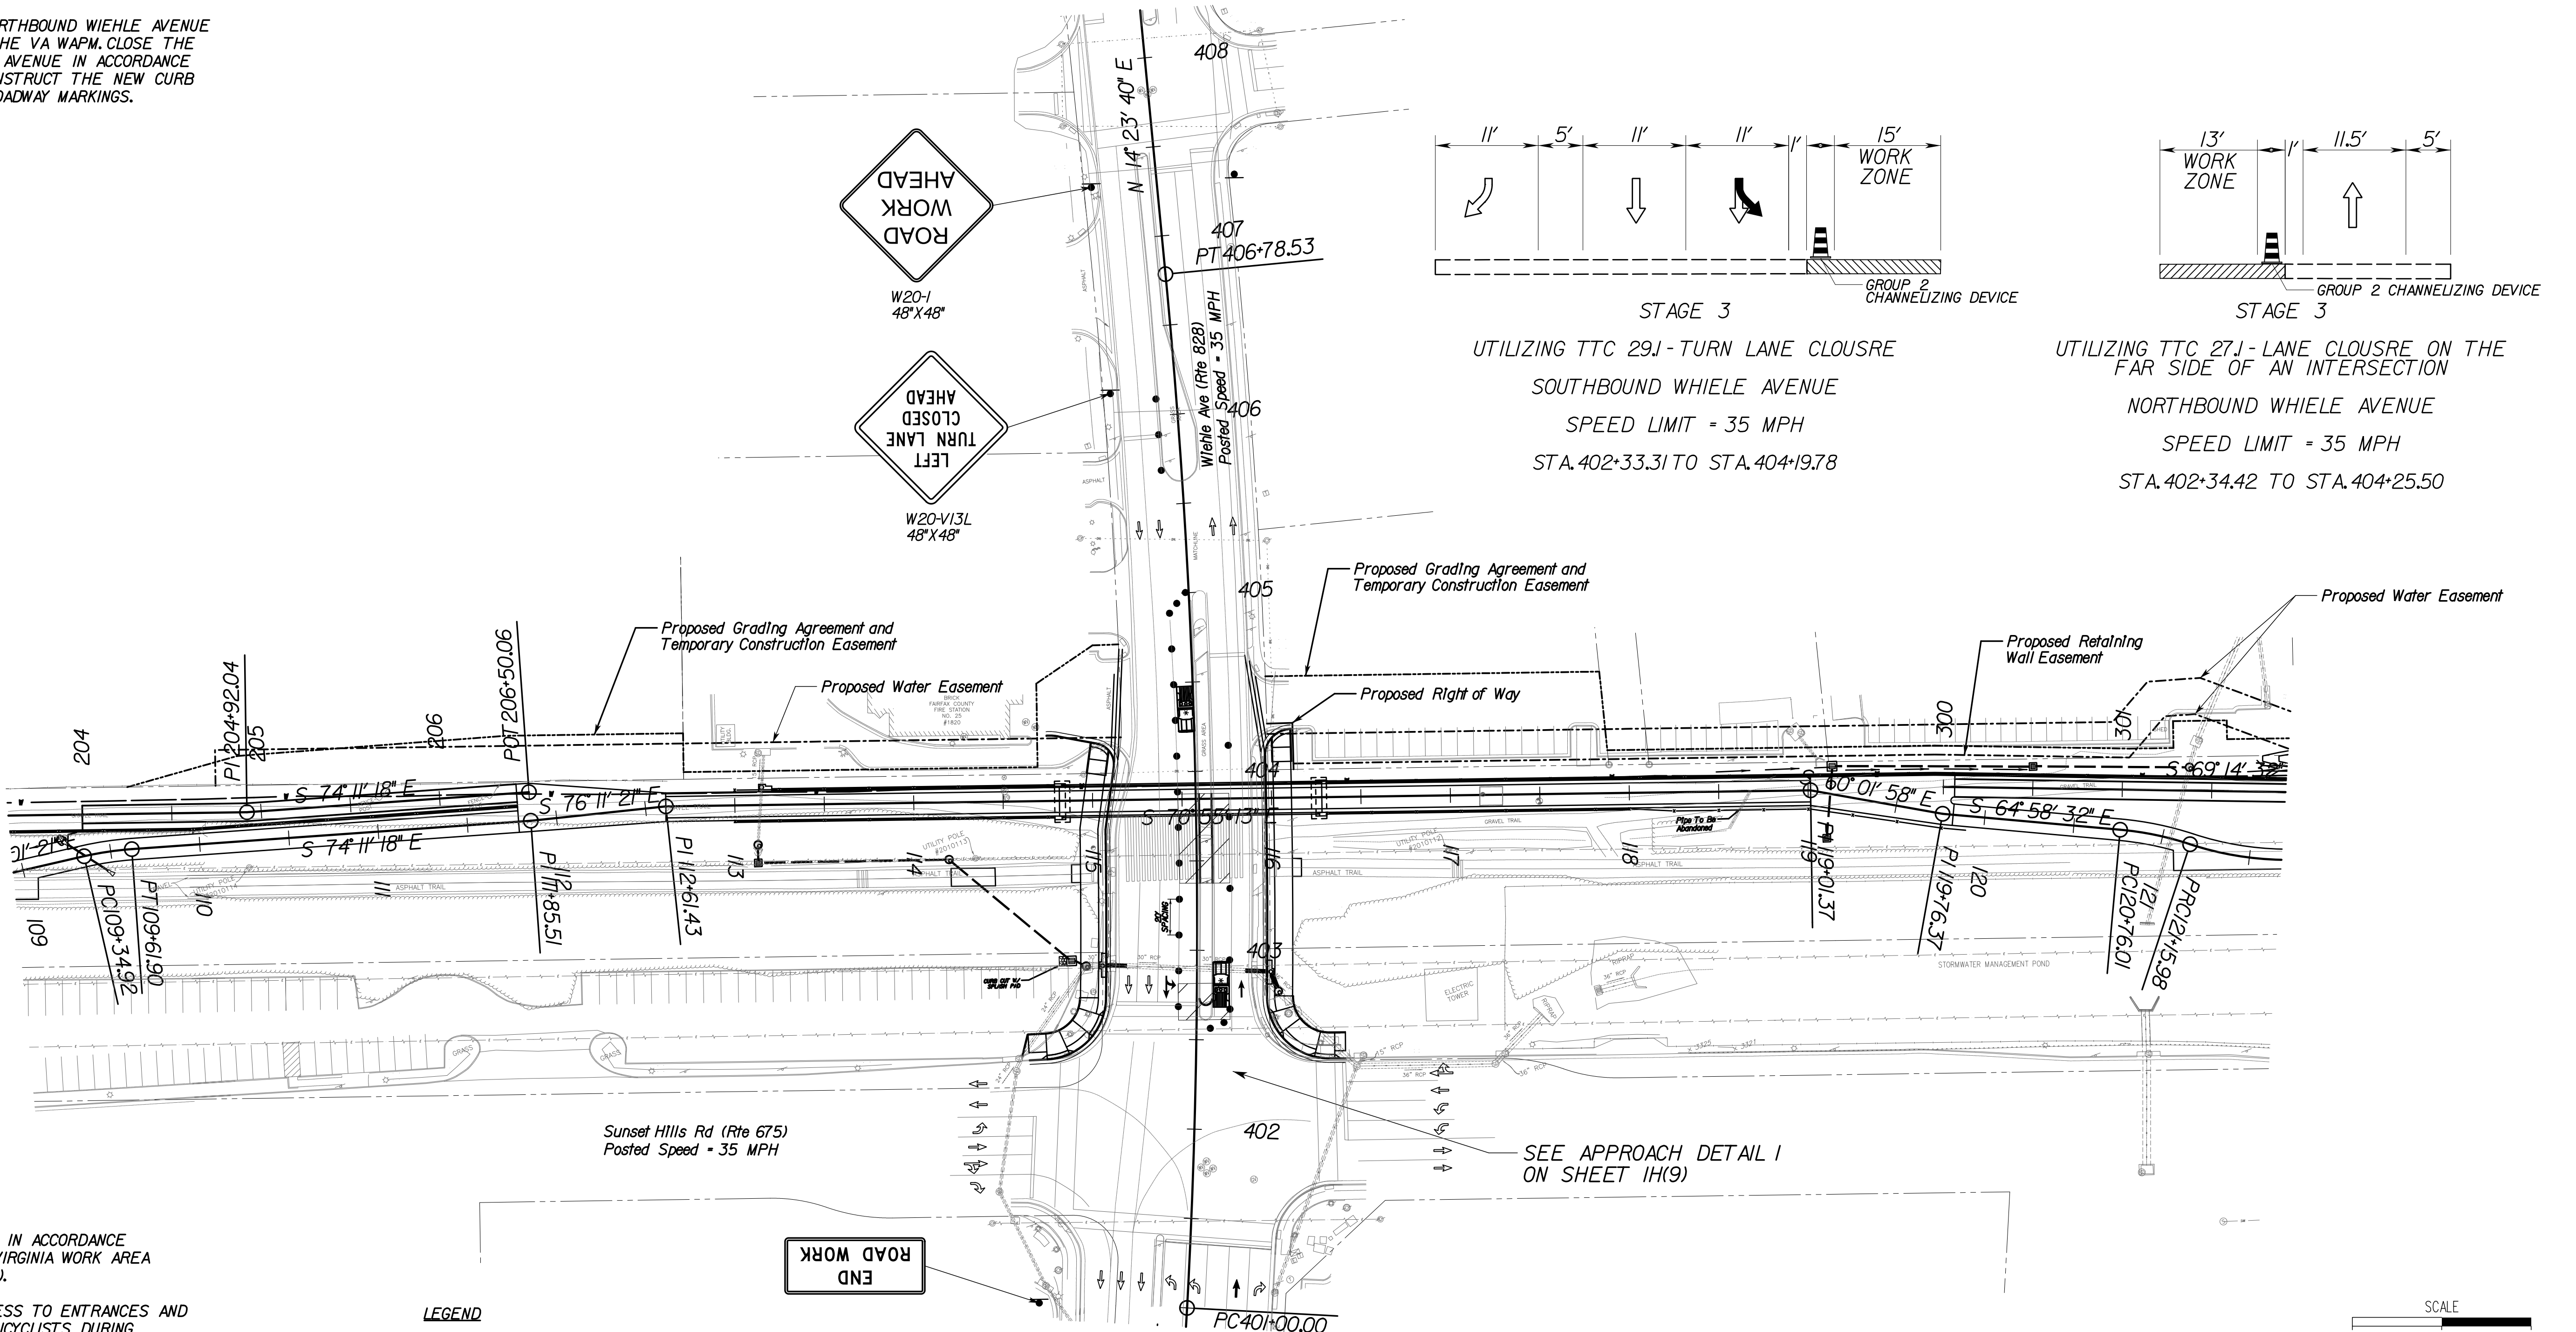
## PHASE 4

### STAGE 3



**NOTES:**  
STAGE 3 - CLOSE THE INSIDE LANE ON NORTHBOUND WIEHLE AVENUE IN ACCORDANCE WITH FIGURE TTC-27J OF THE VA WAPM. CLOSE THE LEFT TURN LANE ON SOUTHBOUND WIEHLE AVENUE IN ACCORDANCE WITH FIGURE TTC-29J OF THE VA WAPM. CONSTRUCT THE NEW CURB AS SHOWN ON THE PLANS. INSTALL FINAL ROADWAY MARKINGS.



**NOTES:**  
1) PROJECT LIMITS SIGNING SHALL BE IN ACCORDANCE WITH FIGURE TTC-53.0 OF THE 2011 VIRGINIA WORK AREA PROTECTION MANUAL, REVISION 1 (WAPM).  
2) CONTRACTOR SHALL MAINTAIN ACCESS TO ENTRANCES AND SAFE PASSAGE FOR PEDESTRIANS/BICYCLISTS DURING CONSTRUCTION WHERE EXISTING FACILITIES ARE PRESENT IN ACCORDANCE WITH FIGURES TTC-35.0 AND TTC-36J OF THE 2011 VIRGINIA WORK AREA PROTECTION MANUAL, REVISION 1 (WAPM).  
3) CONTRACTOR SHALL CLOSE THE INSIDE LANE ON NORTHBOUND WIEHLE AVENUE IN ACCORDANCE WITH FIGURE TTC-27J OF THE VA WAPM AND CLOSE THE LEFT TURN LANE ON SOUTHBOUND WIEHLE AVENUE IN ACCORDANCE WITH FIGURE TTC-29J OF THE VA WAPM.  
4) FOR NIGHTTIME CLOSURE, TYPE A FLASHING WARNING LIGHTS MAY BE USED ON BARRICADES SUPPORTING SIGNS AND CLOSING SIDEWALKS.  
5) CONTRACTOR SHALL COORDINATE ROAD CONSTRUCTION ACTIVITIES WITH FAIRFAX COUNTY FIRE STATION 25.  
6) W&OD MAINLINE ASPHALT TRAIL SHALL REMAIN OPEN AT ALL TIMES.

- LEGEND**
- WORK ZONE AREA
  - GROUP 2 CHANNELIZING DEVICE
  - TYPE 3 BARRICADE
  - ARROW BOARD ON TRAILER
  - SIGN
  - EXISTING DIRECTION OF TRAVEL
  - TEMPORARY DIRECTION OF TRAVEL
  - WORK VEHICLE

EMERGENCY POLICE - FIRE - RESCUE 911						
FAIRFAX COUNTY, VIRGINIA						
DEPARTMENT OF PUBLIC WORKS AND ENVIRONMENTAL SERVICES						
12000 GOVERNMENT CENTER PARKWAY, SUITE 449 FAIRFAX, VA., 22035-0052						
R E V I S I O N S					OFFICE OF CAPITAL FACILITIES 703-324-5800	
						WIEHLE AVENUE (RTE 828) AT W&OD TRAIL
						TRANSPORTATION MANAGEMENT PLAN
						PROJECT NO: 1400102-2013
						SCALE 1"=50'
					DESIGNED: NDD DRAFTED: WRA CHECKED: RBH	
					SHEET 1H(8)	







PROJECT MANAGER\_ SCOTT RUFFNER, P.E. (703) 877-5736 \_\_\_\_\_  
SURVEYED BY, DATE\_ FAIRFAX COUNTY, NOVEMBER 28, 2014 \_\_\_\_\_  
DESIGN BY\_ WHITMAN, REQUARDT & ASSOCIATES, LLP (703) 293-9717 \_\_\_\_\_  
SUBSURFACE UTILITY BY, DATE\_ SO DEEP, INC. (703) 361-6005 DECEMBER 23, 2014 \_\_\_\_\_

# TEMPORARY CONSTRUCTION PLAN



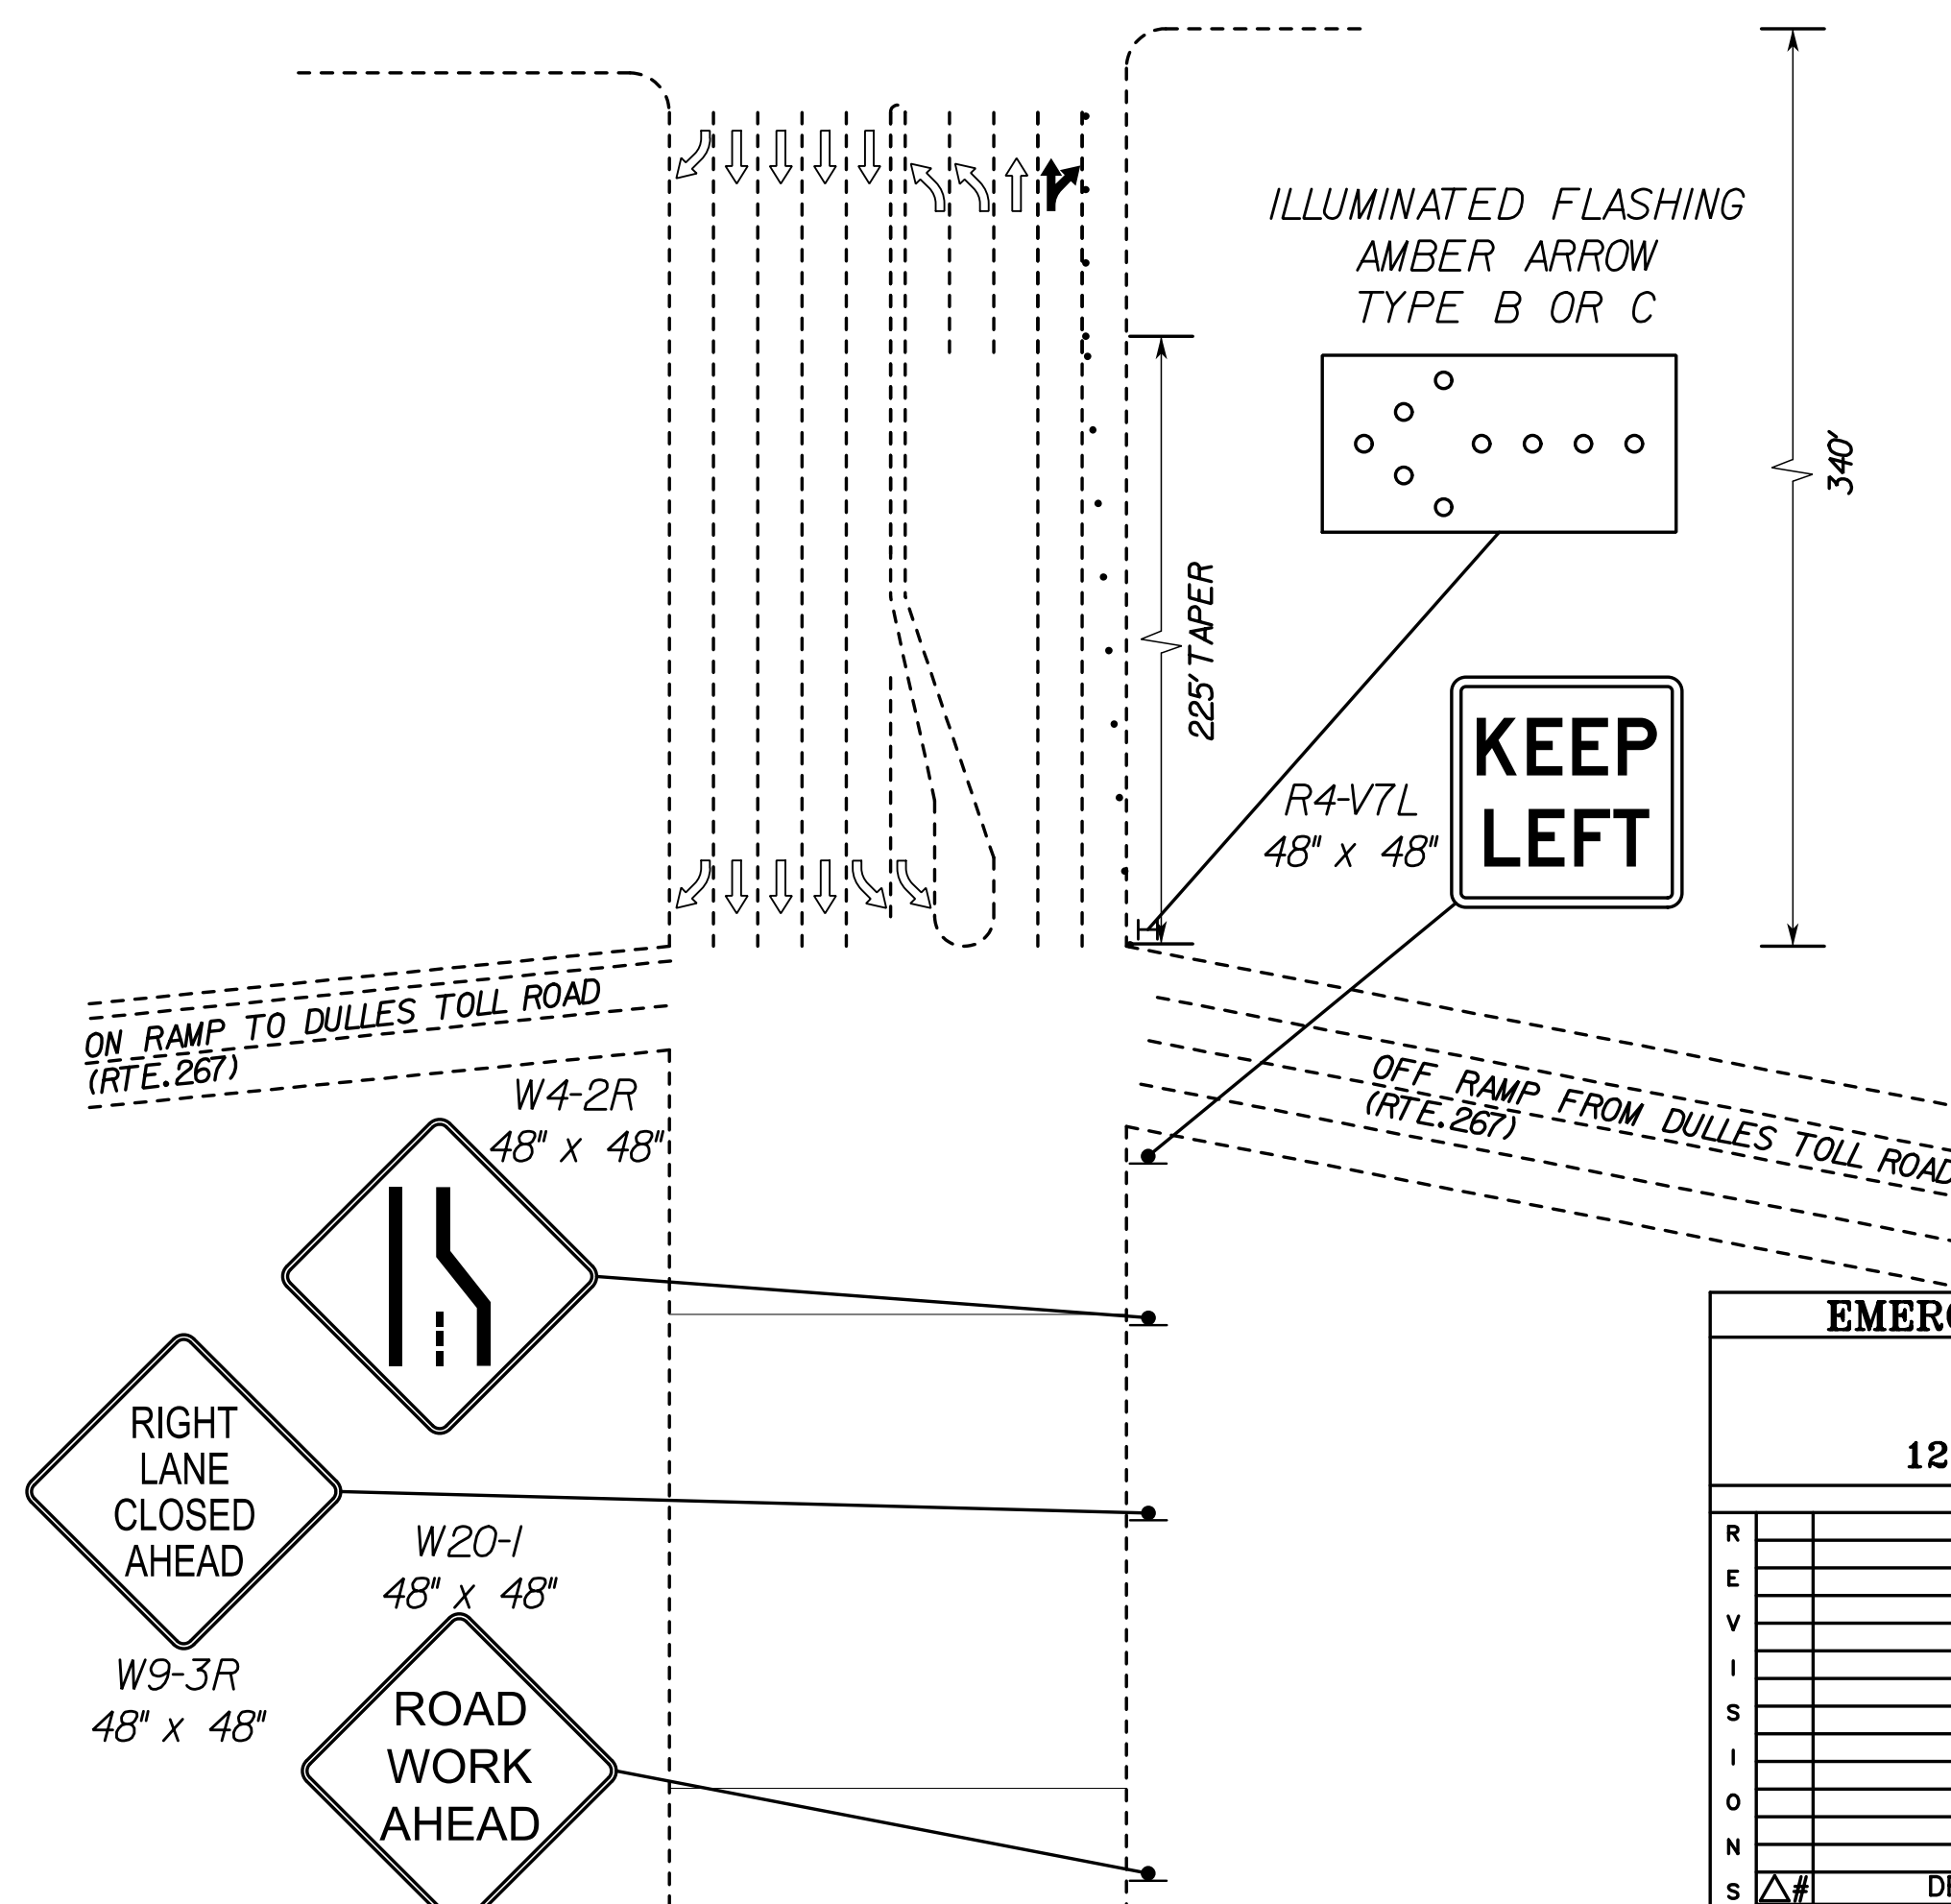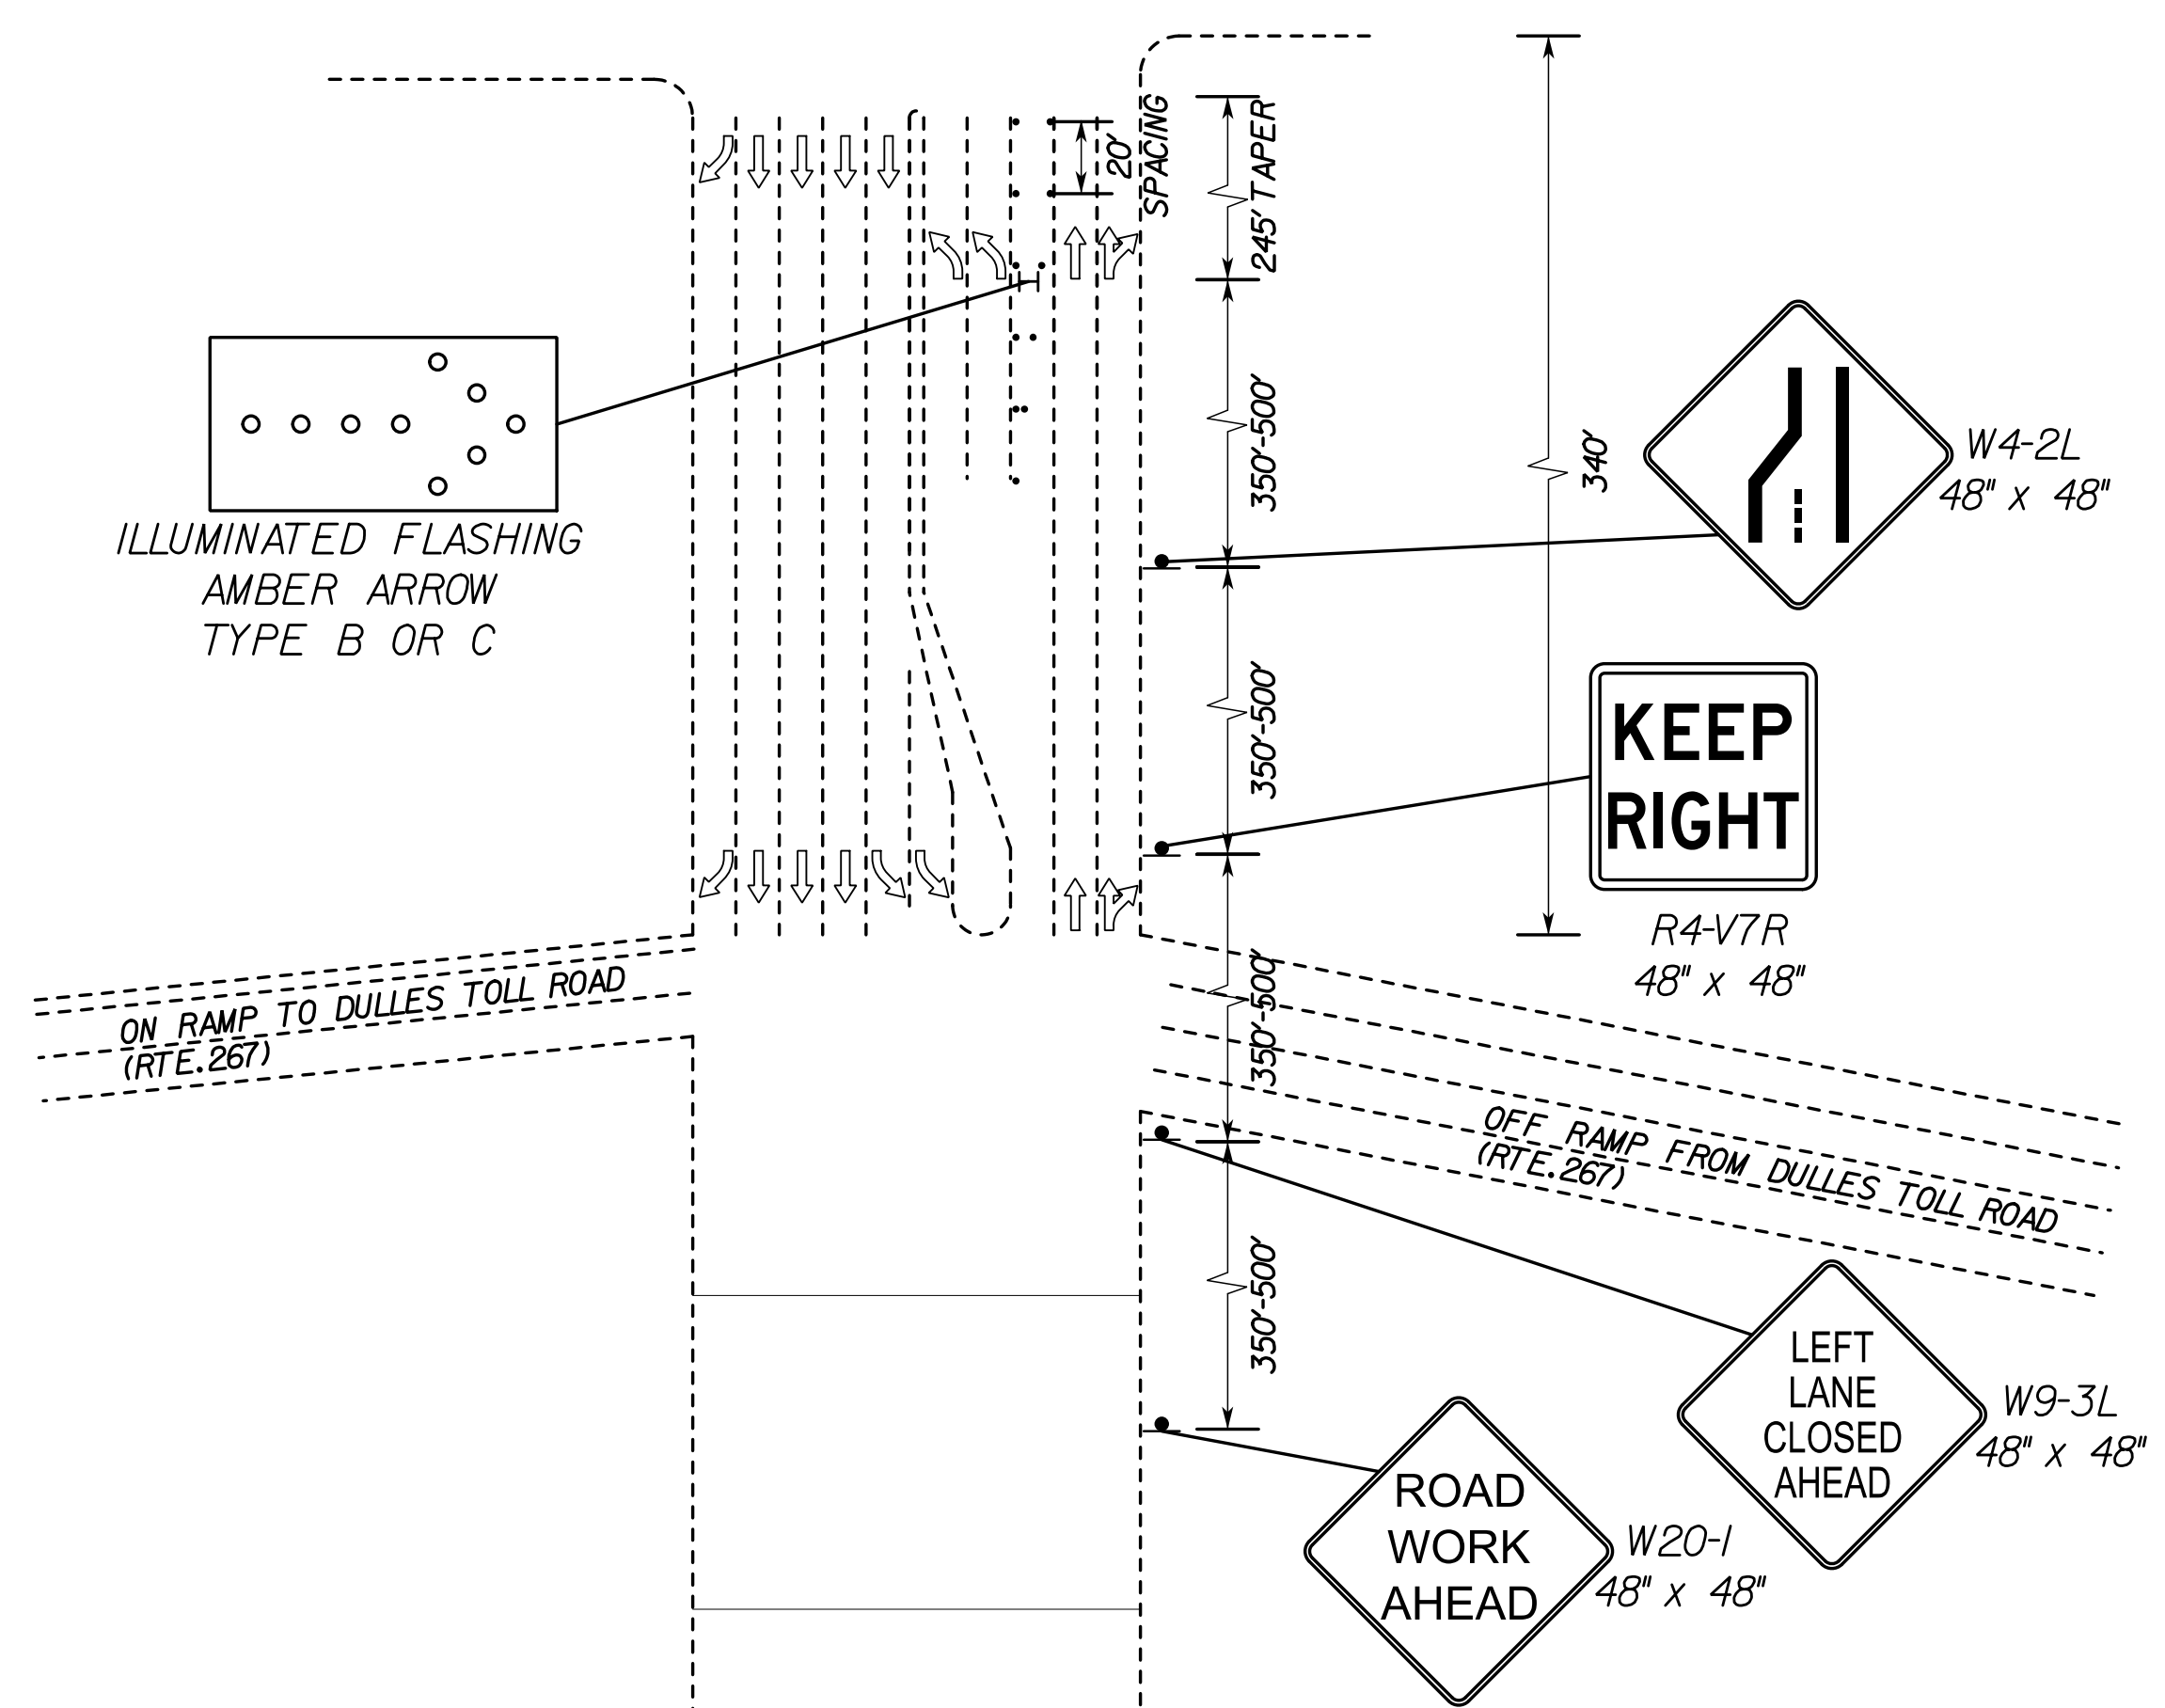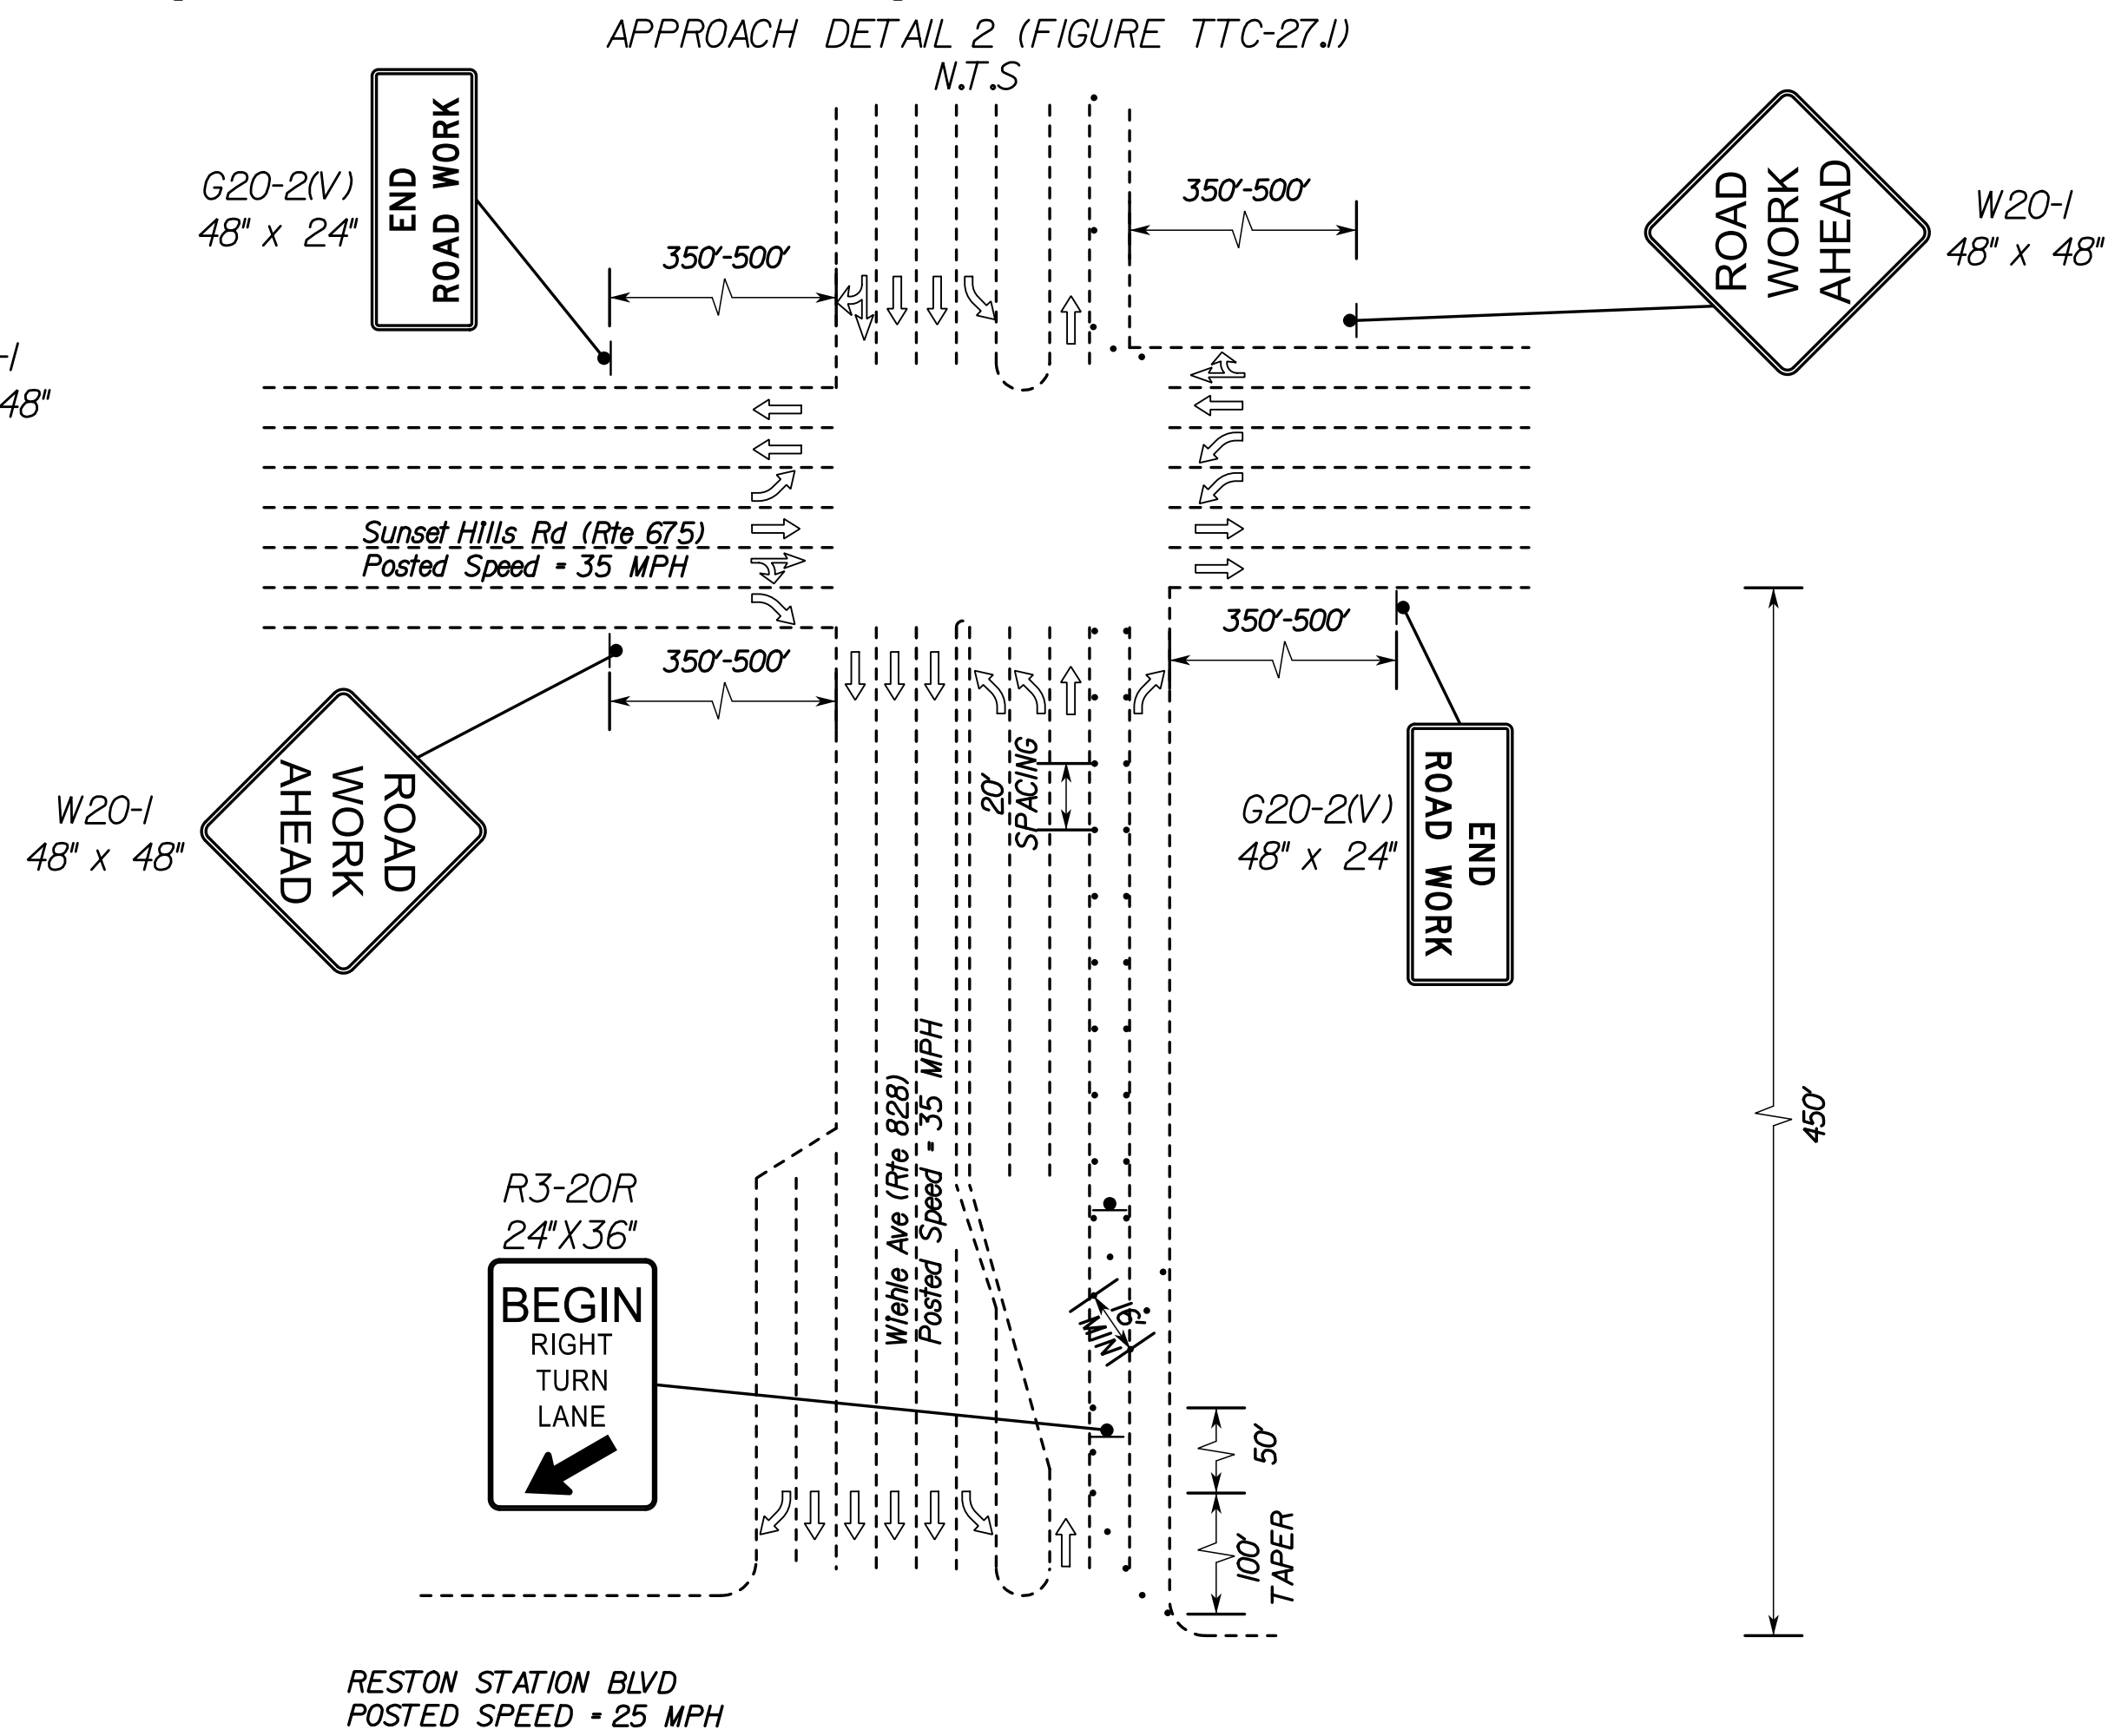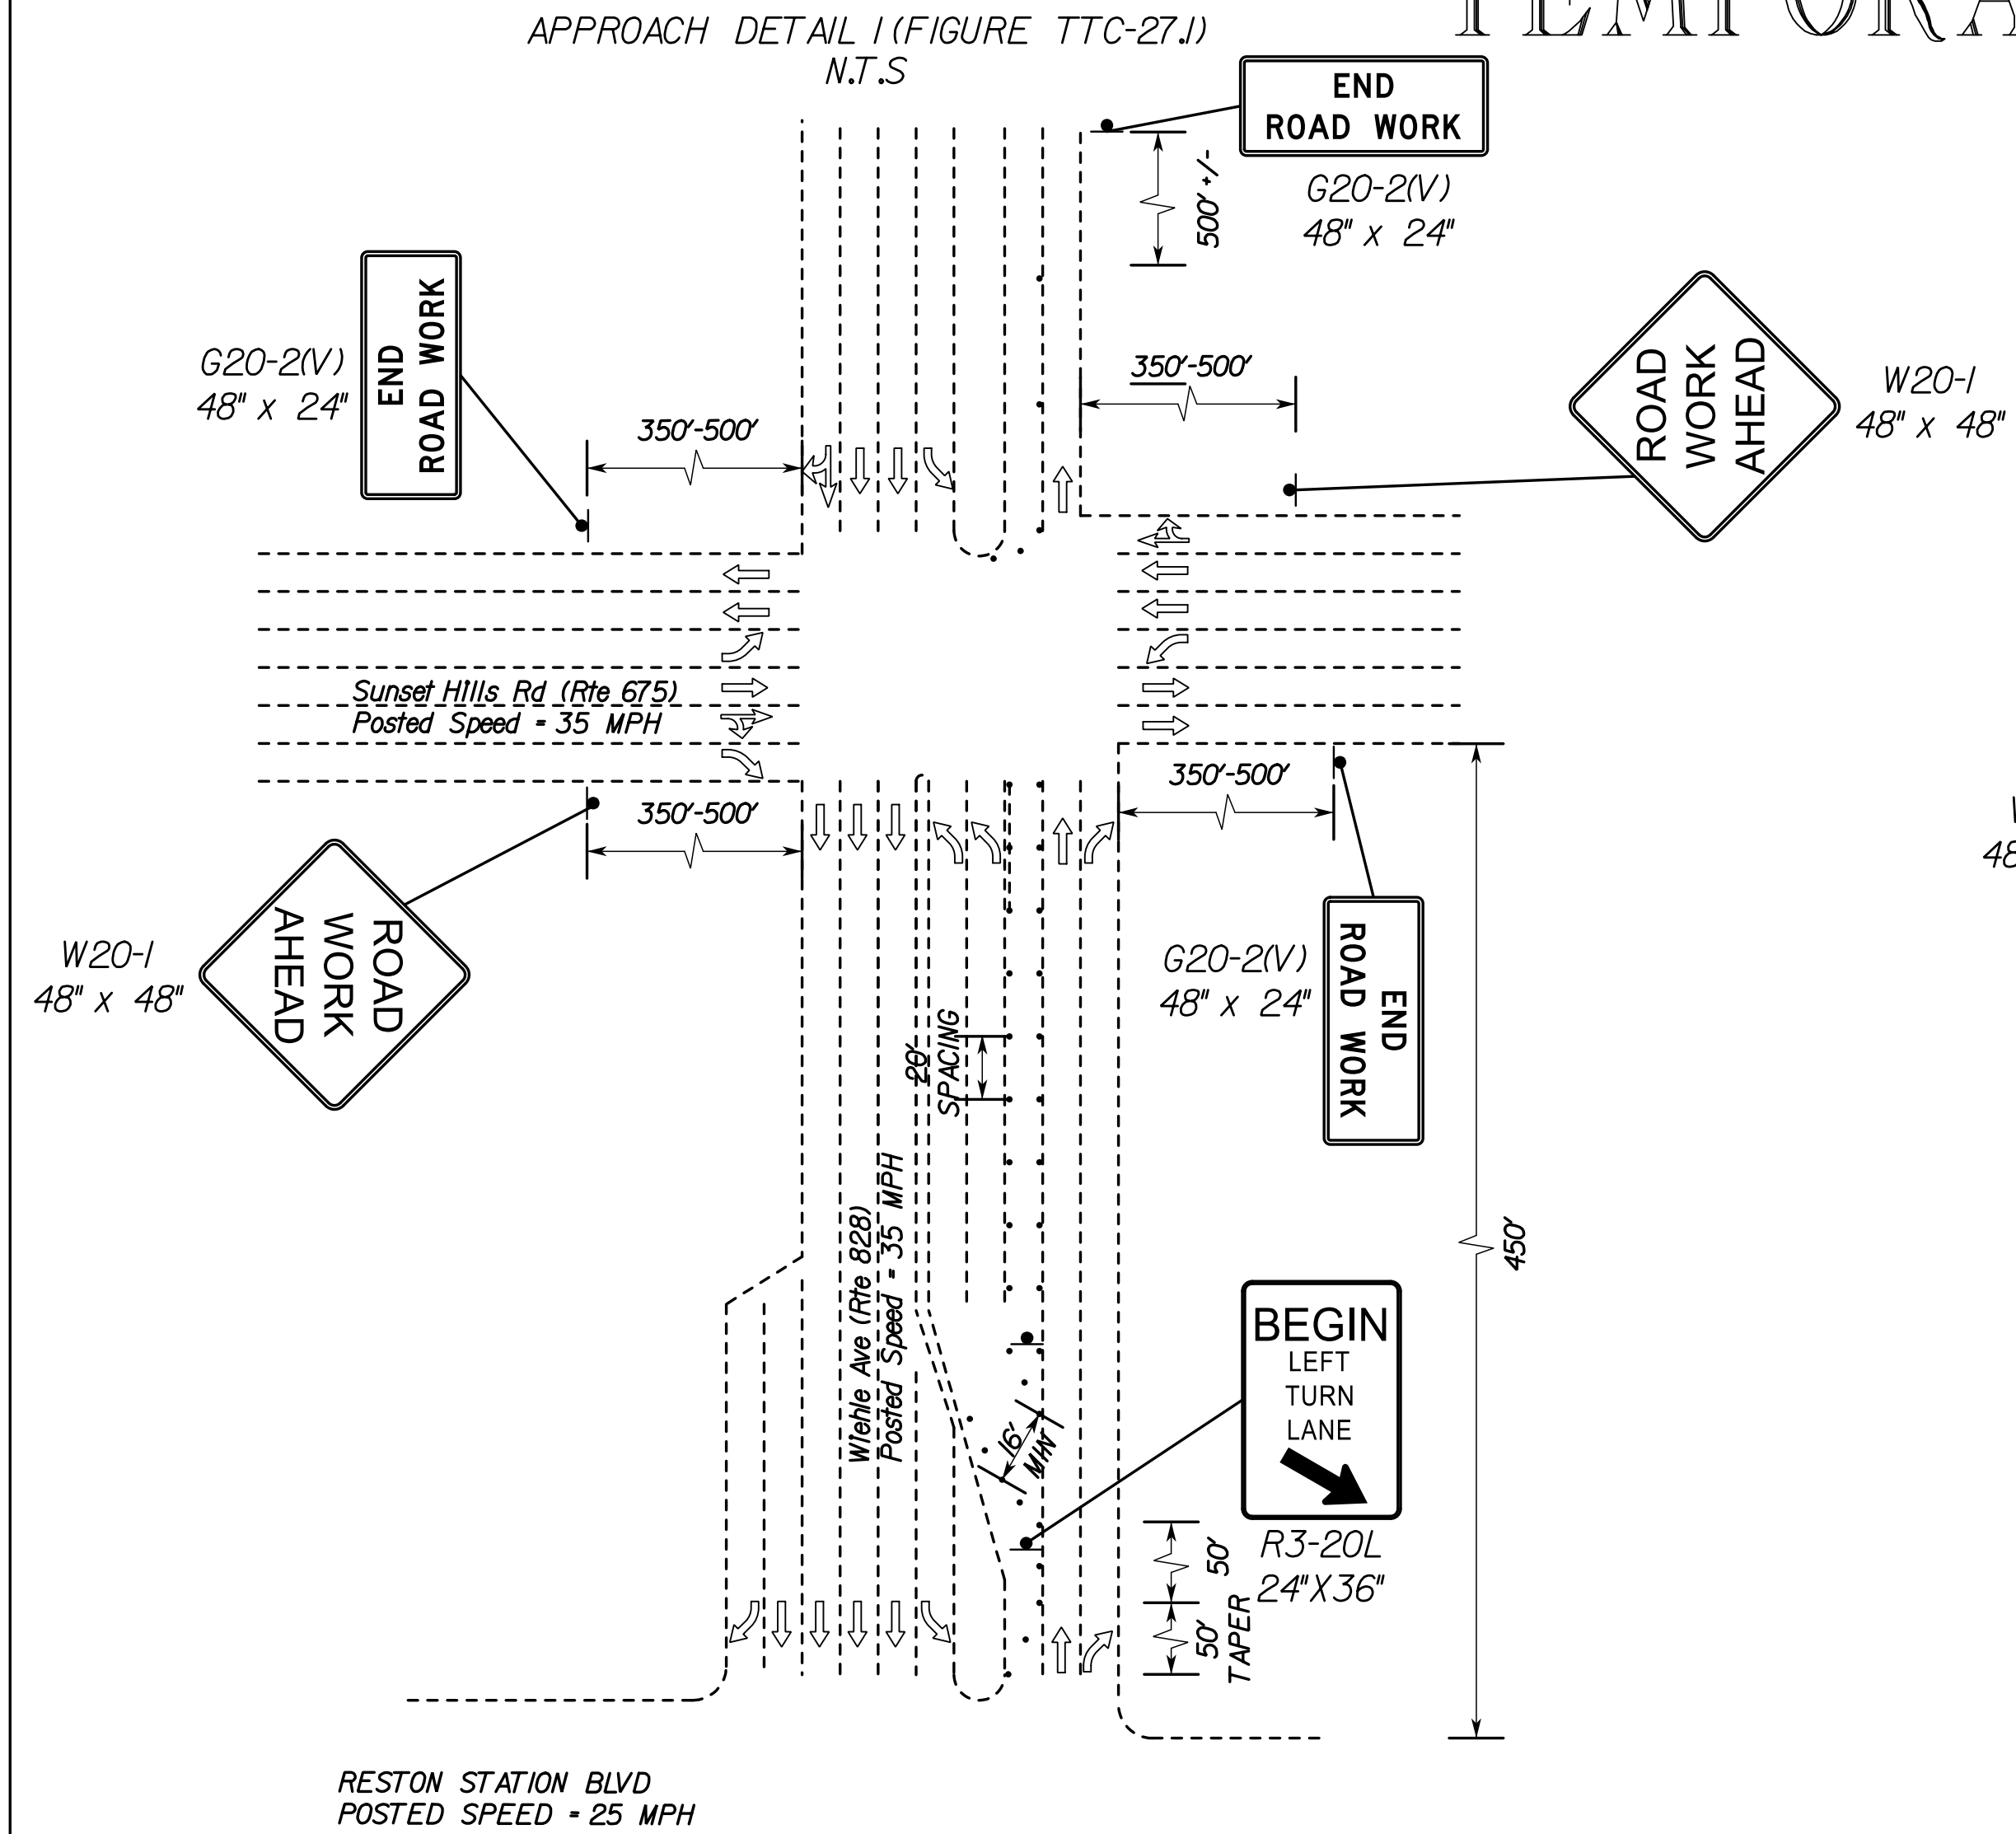Whitman Requardt & Associates  
Fairfax, Virginia  
ROADWAY ENGINEER



**Whitman, Requardt & Associates, LLP**

LEGEND

- |    |                               |
|----|-------------------------------|
|    | WORK ZONE AREA                |
| •  | GROUP 2 CHANNELIZING DEVICE   |
| ++ | TYPE 3 BARRICADE              |
| I  | ARROW BOARD ON TRAILER        |
| ↓  | SIGN                          |
|    | EXISTING DIRECTION OF TRAVEL  |
|    | TEMPORARY DIRECTION OF TRAVEL |
|    | WORK VEHICLE                  |

**EMERGENCY      POLICE – FIRE – RESCUE      911**

FAIRFAX COUNTY, VIRGINIA

DEPARTMENT OF PUBLIC WORKS AND ENVIRONMENTAL SERVICES  
12000 GOVERNMENT CENTER PARKWAY, SUITE 449 FAIRFAX, VA., 22035-0052

OFFICE OF CAPITAL FACILITIES  
703-324-5800

WIEHLE AVENUE (RTE 828)  
AT W&OD TRAIL  
TRANSPORTATION MANAGEMENT PLAN  
PROJECT NO: 1400102-2013

SCALE NTS	DESIGNED: NDD DRAFTED: WRA CHECKED: RBH	SHEET 1H(9)
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FUND #	500-C5000
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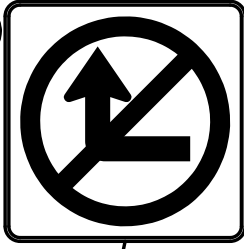


PROJECT MANAGER: SCOTT RUEFFNER, P.E. (703) 871-5736  
SURVEYED BY: DATE: FAIRFAX COUNTY, NOVEMBER 28, 2014  
DESIGN BY: WHITMAN, REQUARDT & ASSOCIATES, LLP (703) 293-9717  
SUBSURFACE UTILITY BY: DATE: SO DEEP, INC. (703) 361-6005, DECEMBER 23, 2014

APPROACH DETAIL 3 (FIGURE TTC-50.0)  
N.T.S.

MATCHLINE (THIS SHEET)



R03-01  
24" x 24"



# TEMPORARY CONSTRUCTION PLAN

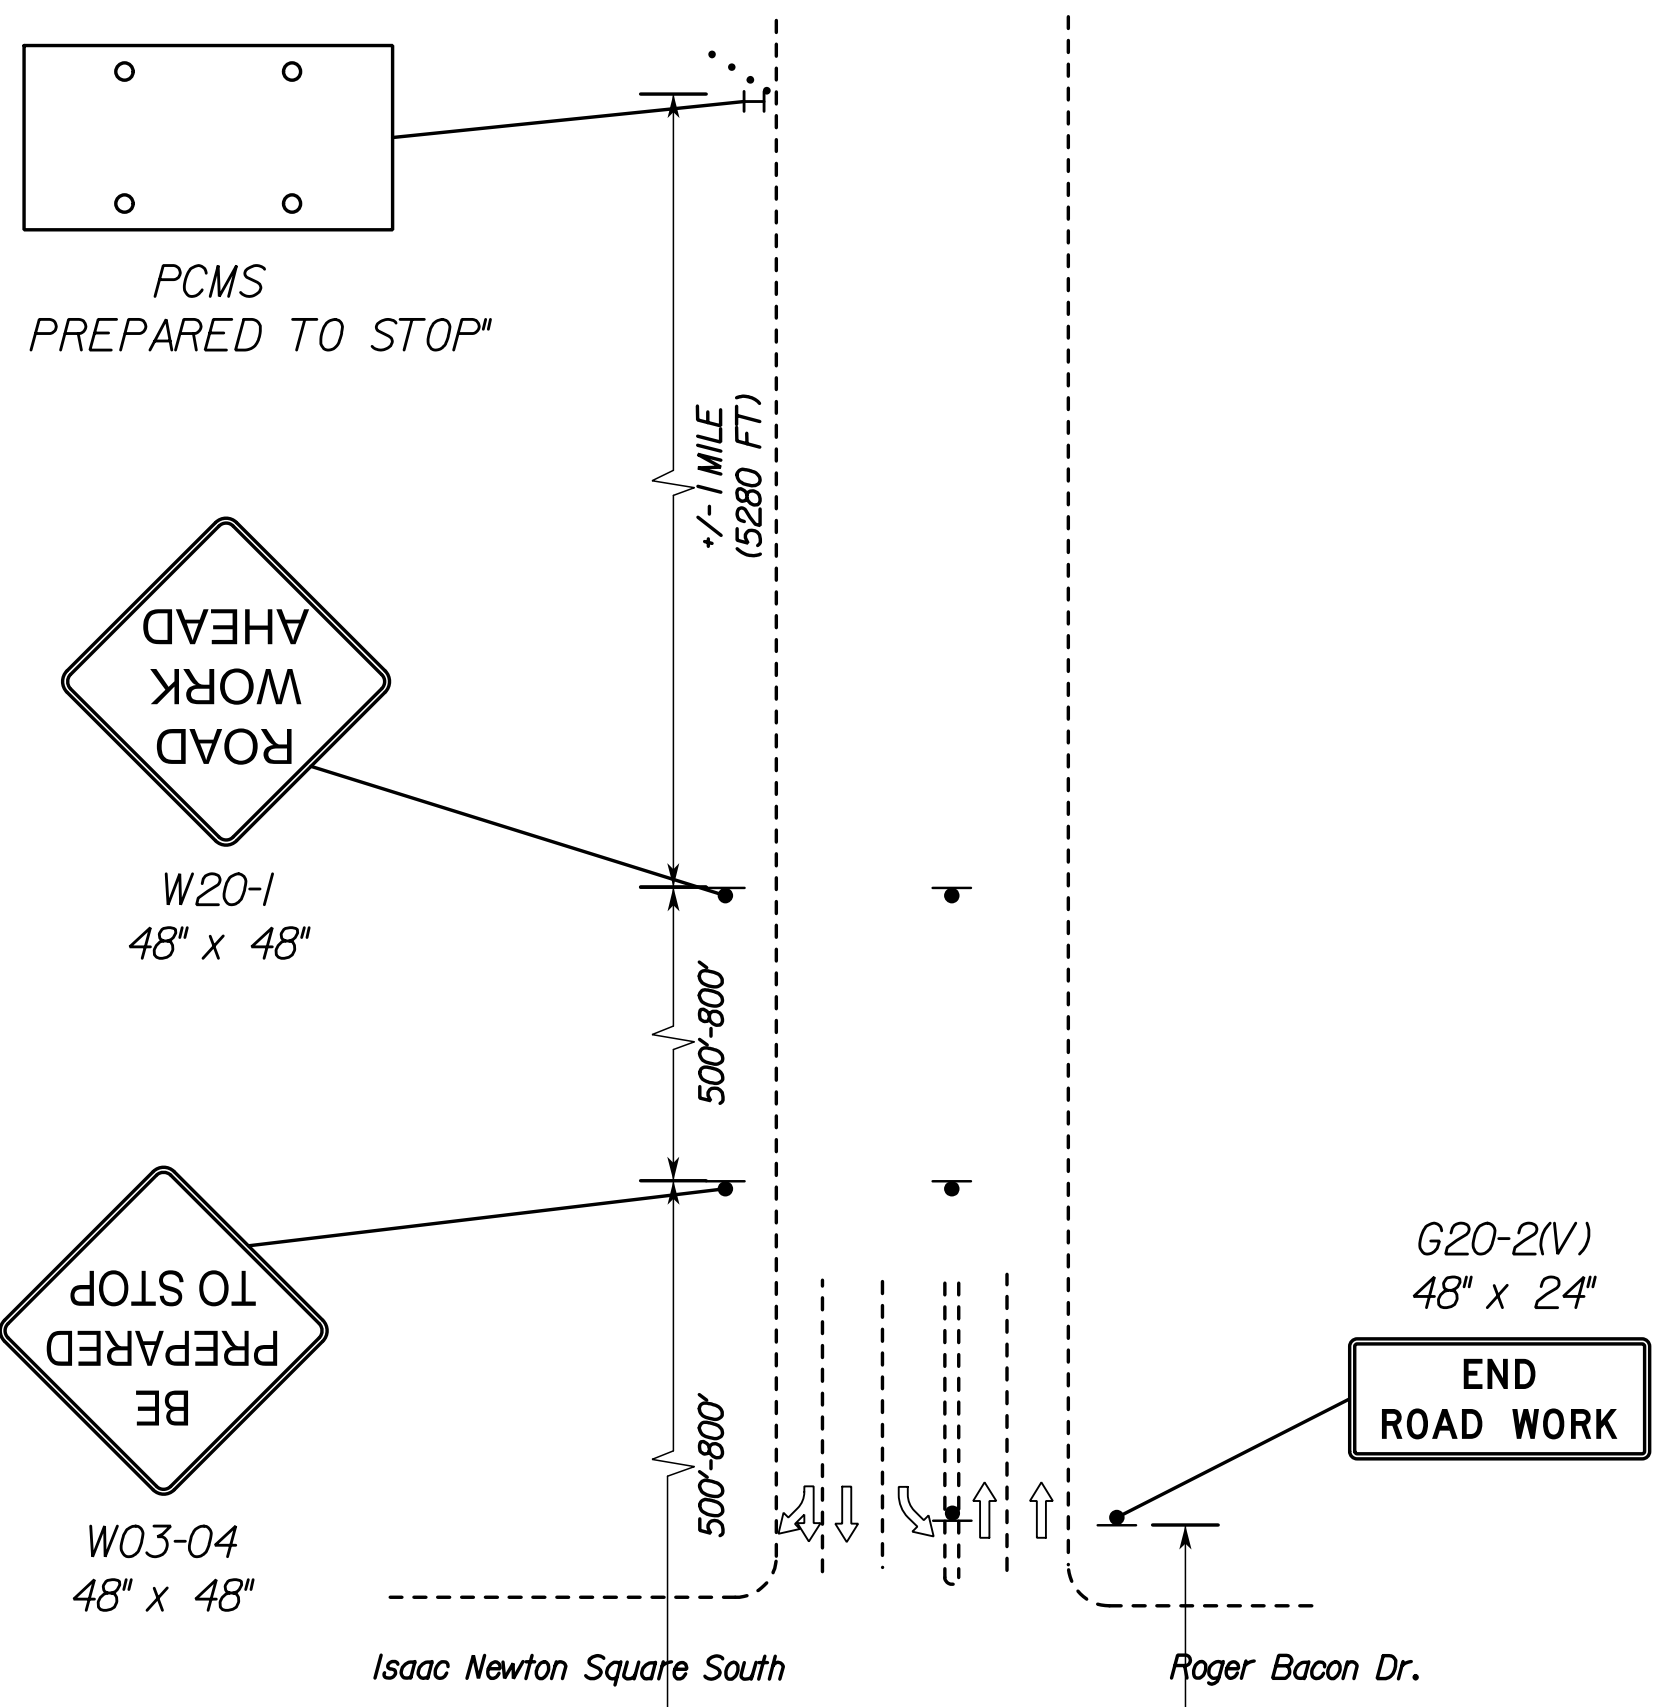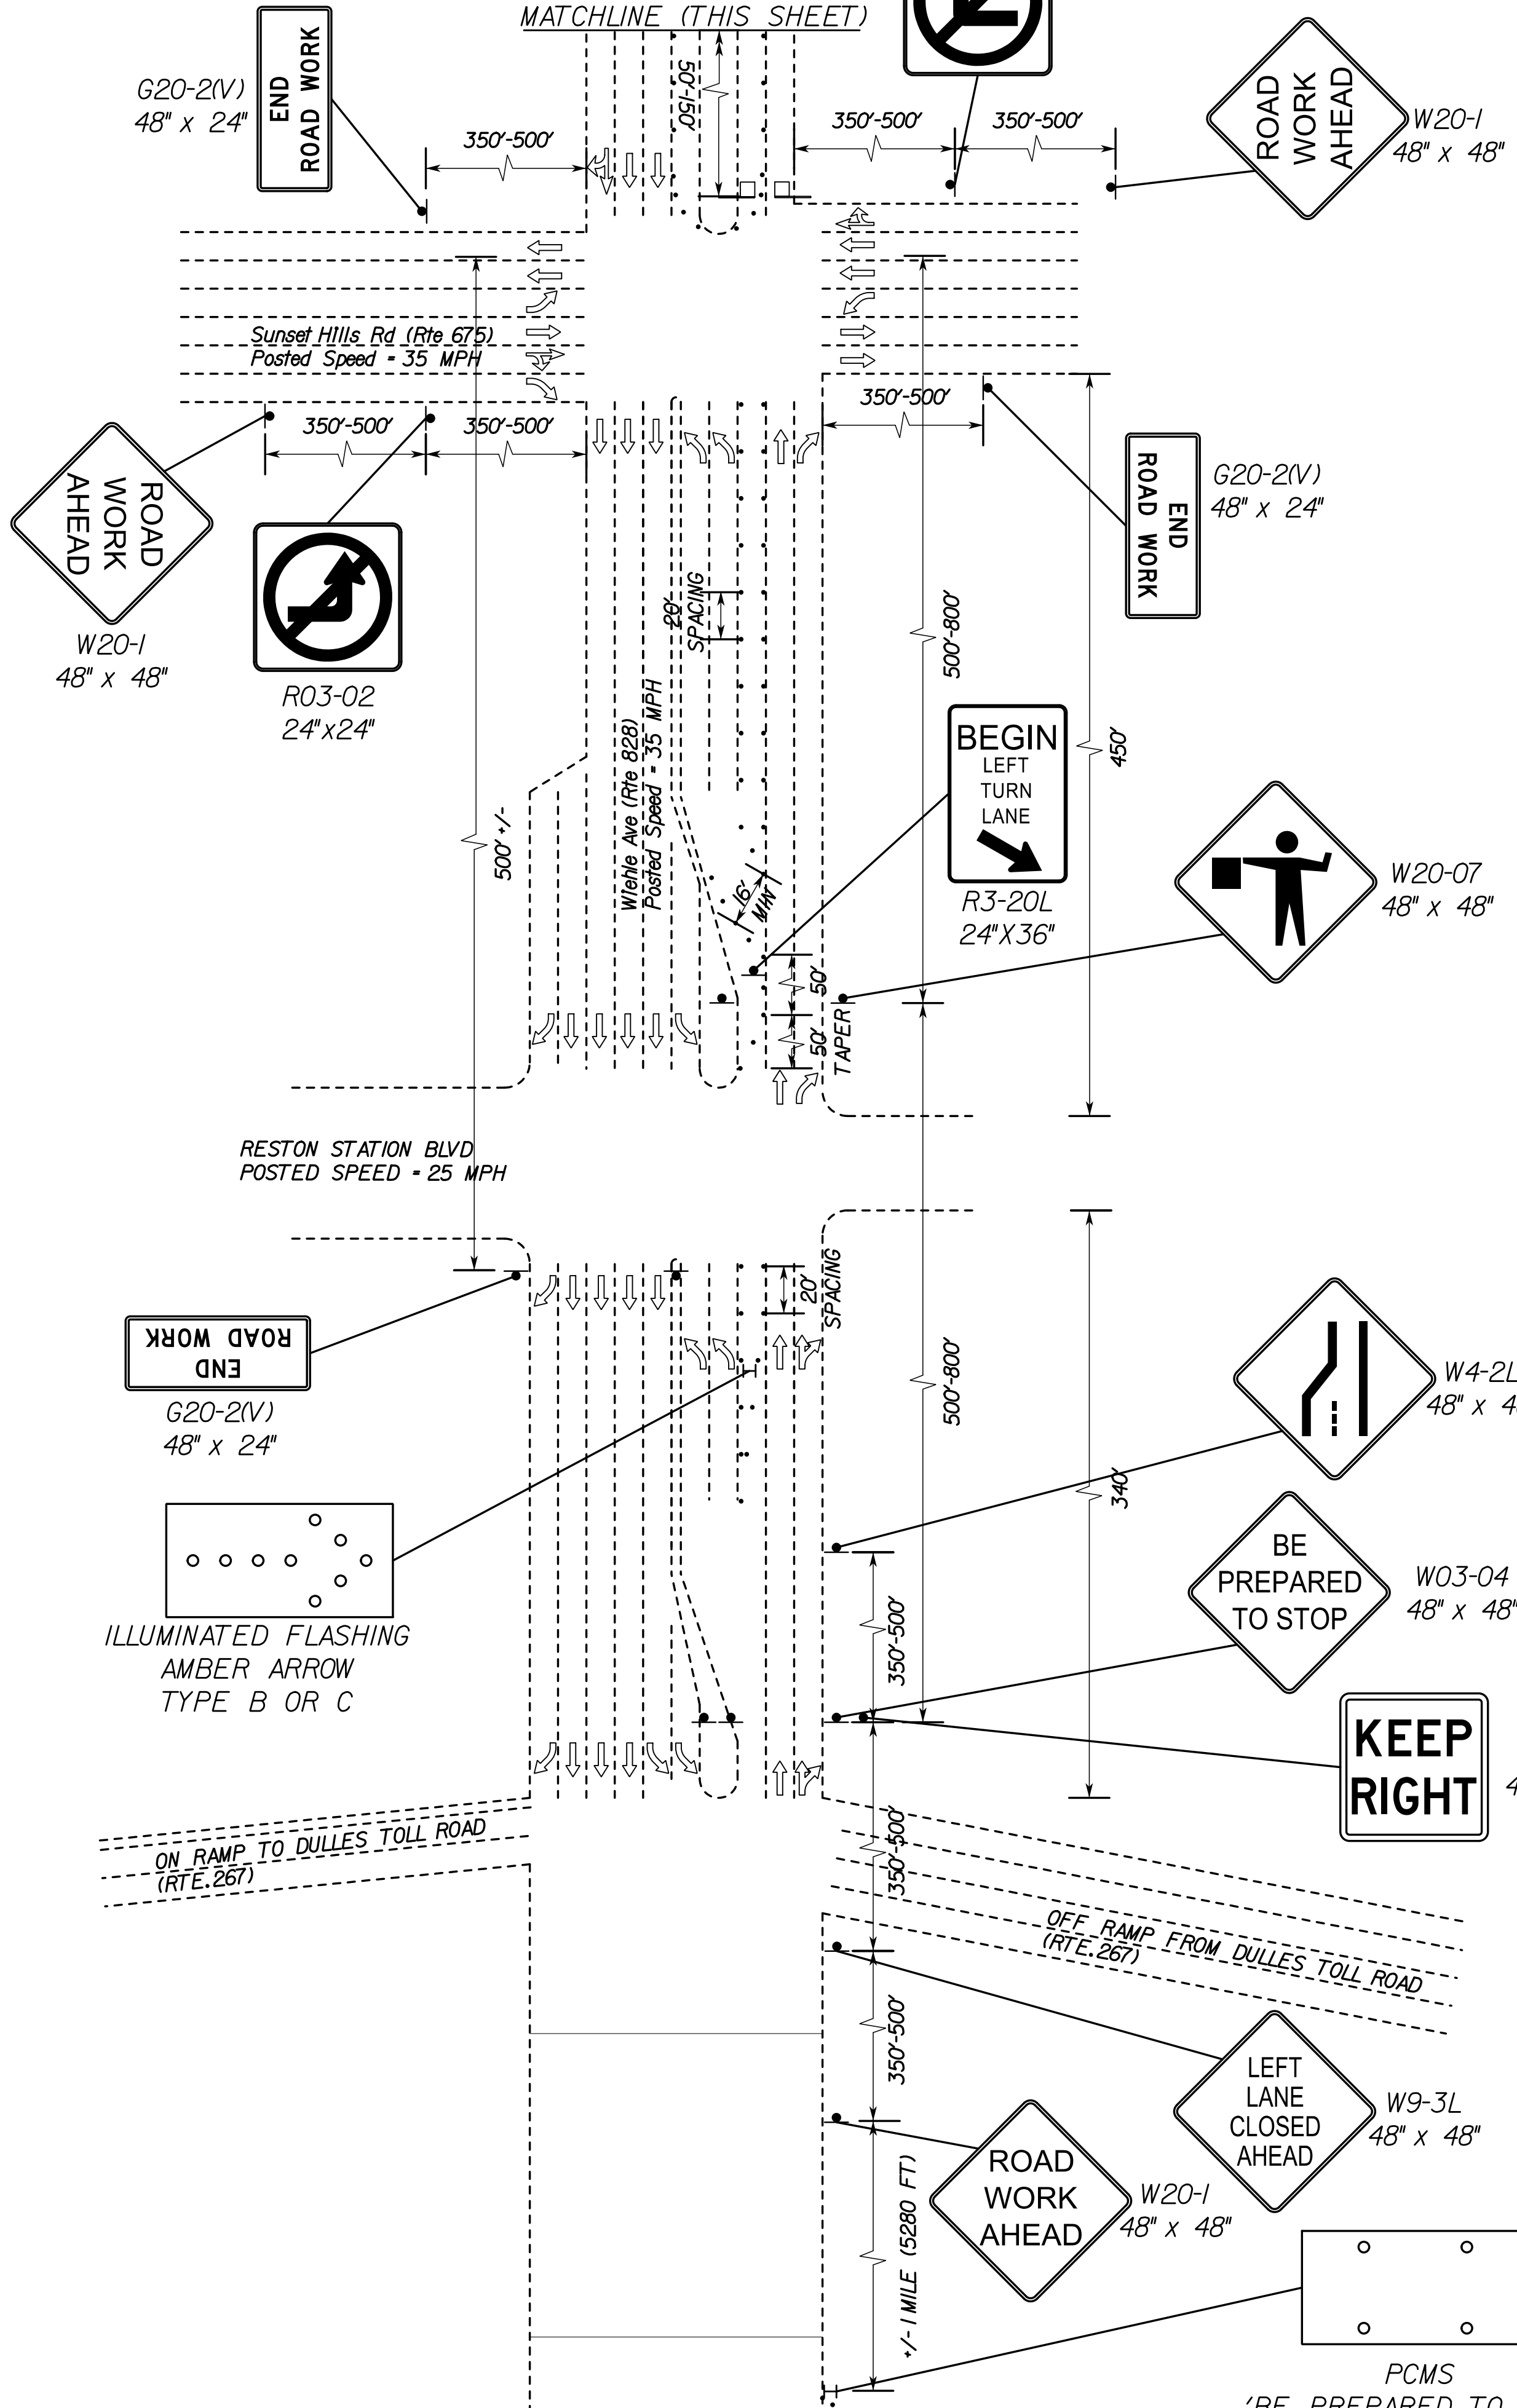APPROACH DETAIL 3 (FIGURE TTC-50.0)  
N.T.S.

PCMS  
"BE PREPARED TO STOP"



- LEGEND**
- WORK ZONE AREA
  - GROUP 2 CHANNELIZING DEVICE
  - FLAGGER SERVICE
  - TYPE 3 BARRICADE
  - ARROW BOARD ON TRAILER
  - SIGN
  - EXISTING DIRECTION OF TRAVEL
  - TEMPORARY DIRECTION OF TRAVEL
  - WORK VEHICLE



EMERGENCY POLICE - FIRE - RESCUE 911					
FAIRFAX COUNTY, VIRGINIA					
DEPARTMENT OF PUBLIC WORKS AND ENVIRONMENTAL SERVICES					
12000 GOVERNMENT CENTER PARKWAY, SUITE 449 FAIRFAX, VA., 22035-0052					
R E V I S I O N S					OFFICE OF CAPITAL FACILITIES 703-324-5800
				WIEHLE AVENUE (RTE 828) AT W&OD TRAIL	
TRANSPORTATION MANAGEMENT PLAN					
PROJECT NO: 1400102-2013					
	SCALE	DESIGNED: NDD		SHEET 1H(10)	
	NTS	DRAFTED: WRA			
		CHECKED: RBH			
	Δ#	DESCRIPTION	BY	APPROVED	DATE
APPROVED BY THE TRANSPORTATION DESIGN DIVISION					

FUND # 500-C5000



PROJECT MANAGER: SCOTT RUEFFNER, P.E., (703) 871-5736  
SURVEYED BY, DATE: FAIRFAX COUNTY, NOVEMBER 28, 2014  
DESIGN BY: WHITMAN, REQUARDT & ASSOCIATES, LLP, (703) 293-9717  
SUBSURFACE UTILITY BY, DATE: SO DEEP, INC., (703) 361-6005, DECEMBER 23, 2014

TYPICAL SECTIONS


THESE PLANS ARE UNFINISHED  
AND UNAPPROVED AND ARE NOT  
TO BE USED FOR ANY TYPE  
OF CONSTRUCTION.




UNDERDRAIN SUMMARY				
FROM STATION	TO STATION	ST'D.UD-4 (LF)	ST'D.UD-4 OUTLET PIPE (LF)	REMARKS
402+73 LT (WIEHLE AVE)	402+87 LT (WIEHLE AVE)	14	5	CONNECT TO STR.4-6
402+75 RT (WIEHLE AVE)	402+84 RT (WIEHLE AVE)	9	5	CONNECT TO STR.4-8
404+04 LT (WIEHLE AVE)	402+96 LT (WIEHLE AVE)	108	5	CONNECT TO STR.4-6
404+08 RT (WIEHLE AVE)	402+93 RT (WIEHLE AVE)	115	5	CONNECT TO STR.4-8

(NOT TO SCALE)

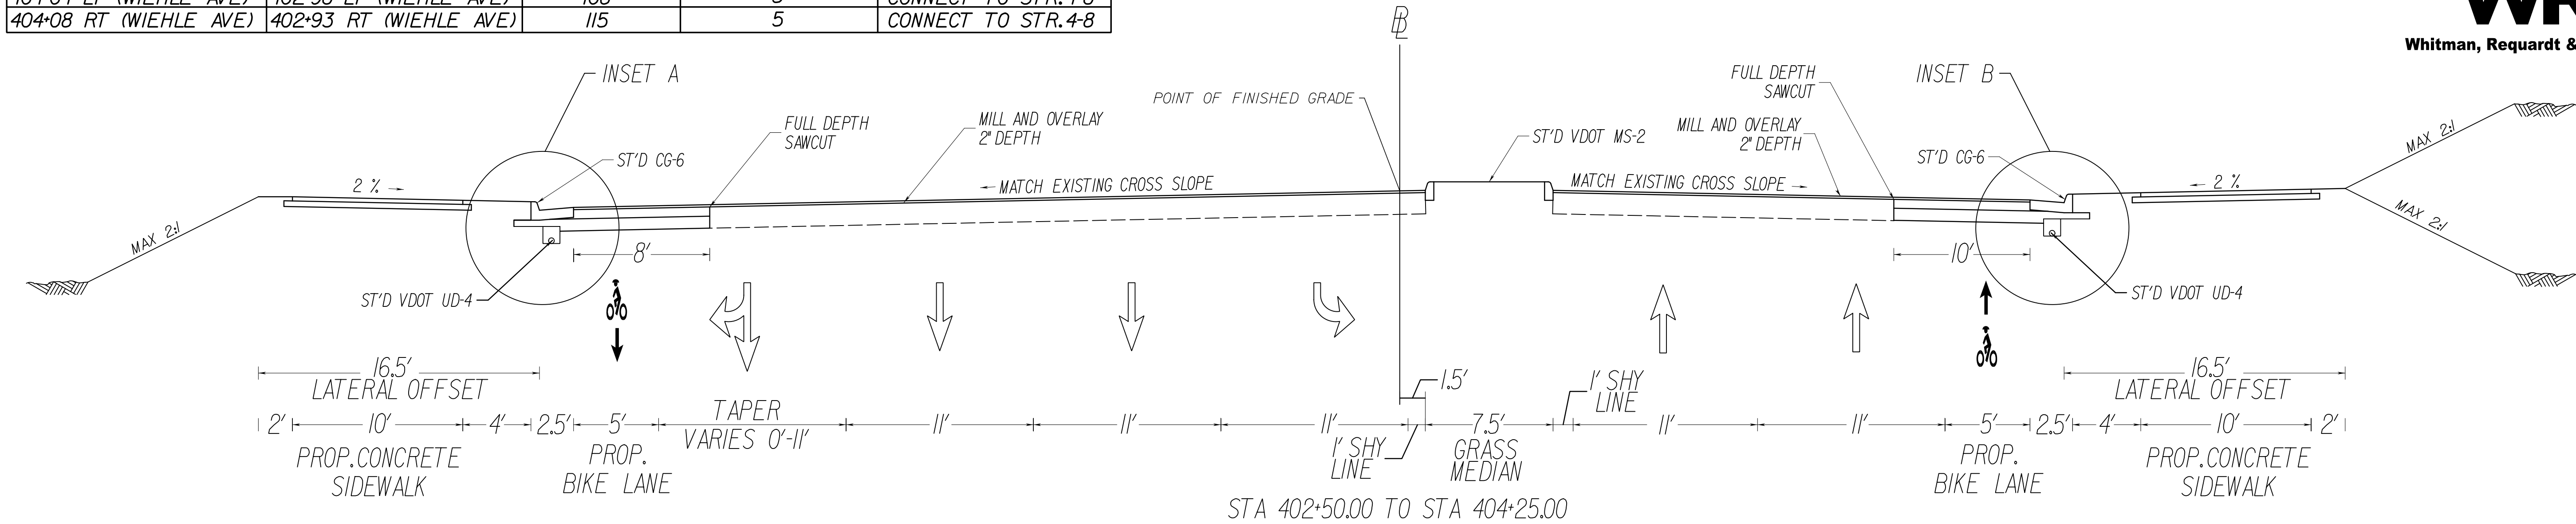Wiehle Ave (Rte 828)





Wiehle Ave (Rte 828)

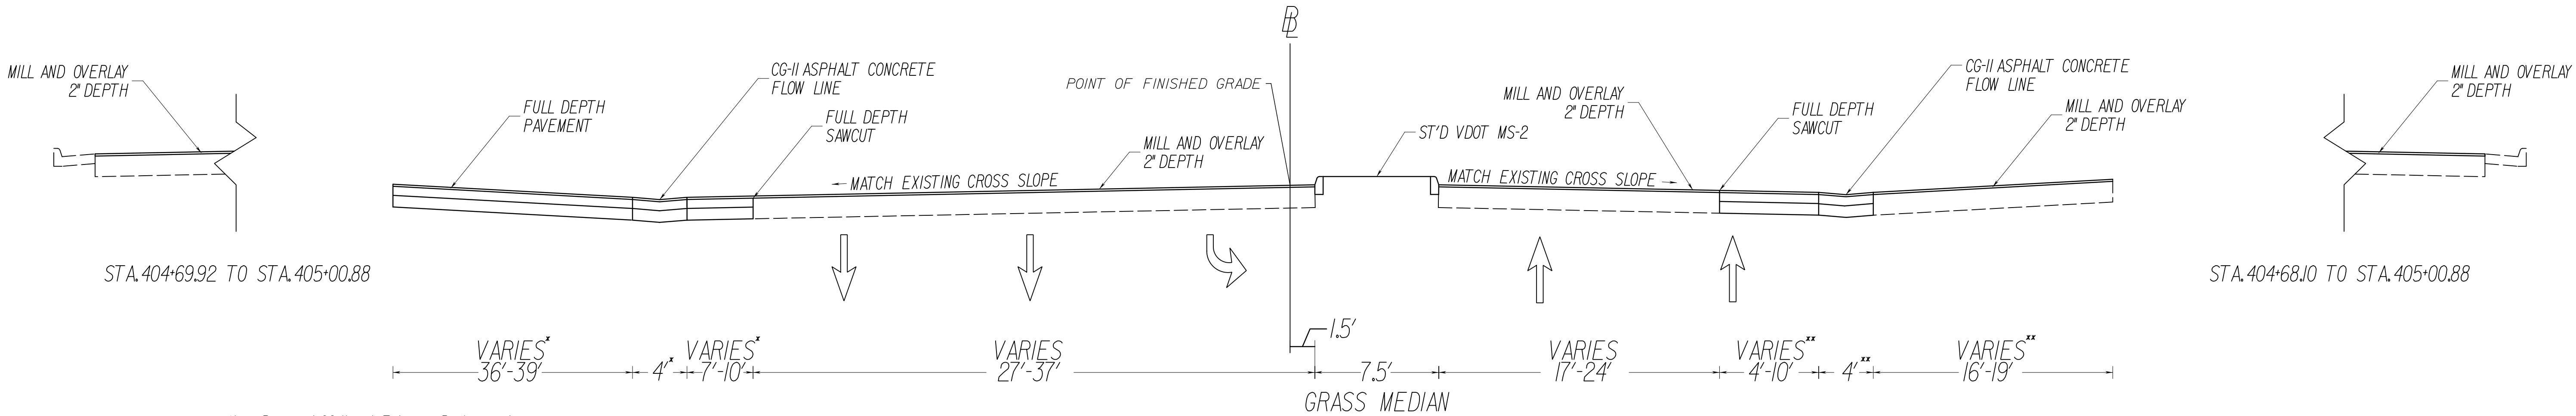


- \* New Pavement, CG-II, and Entrance Replacement on the left from Sta. 404+11.94 to Sta. 404+70.04
- \*\* New Pavement, CG-II, and Entrance Replacement on the right from Sta. 404+14.13 to Sta. 404+66.36

NOTES:

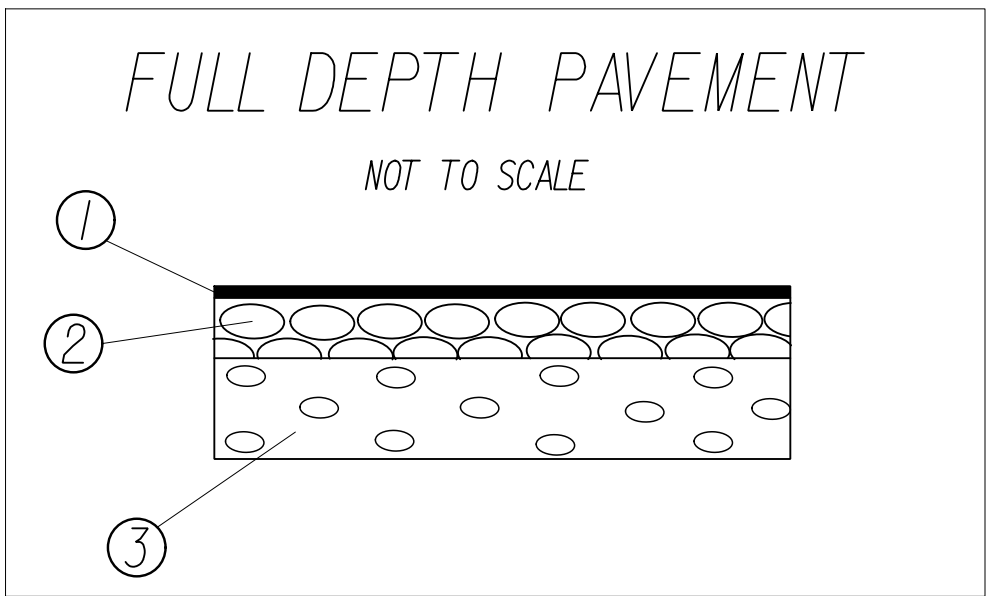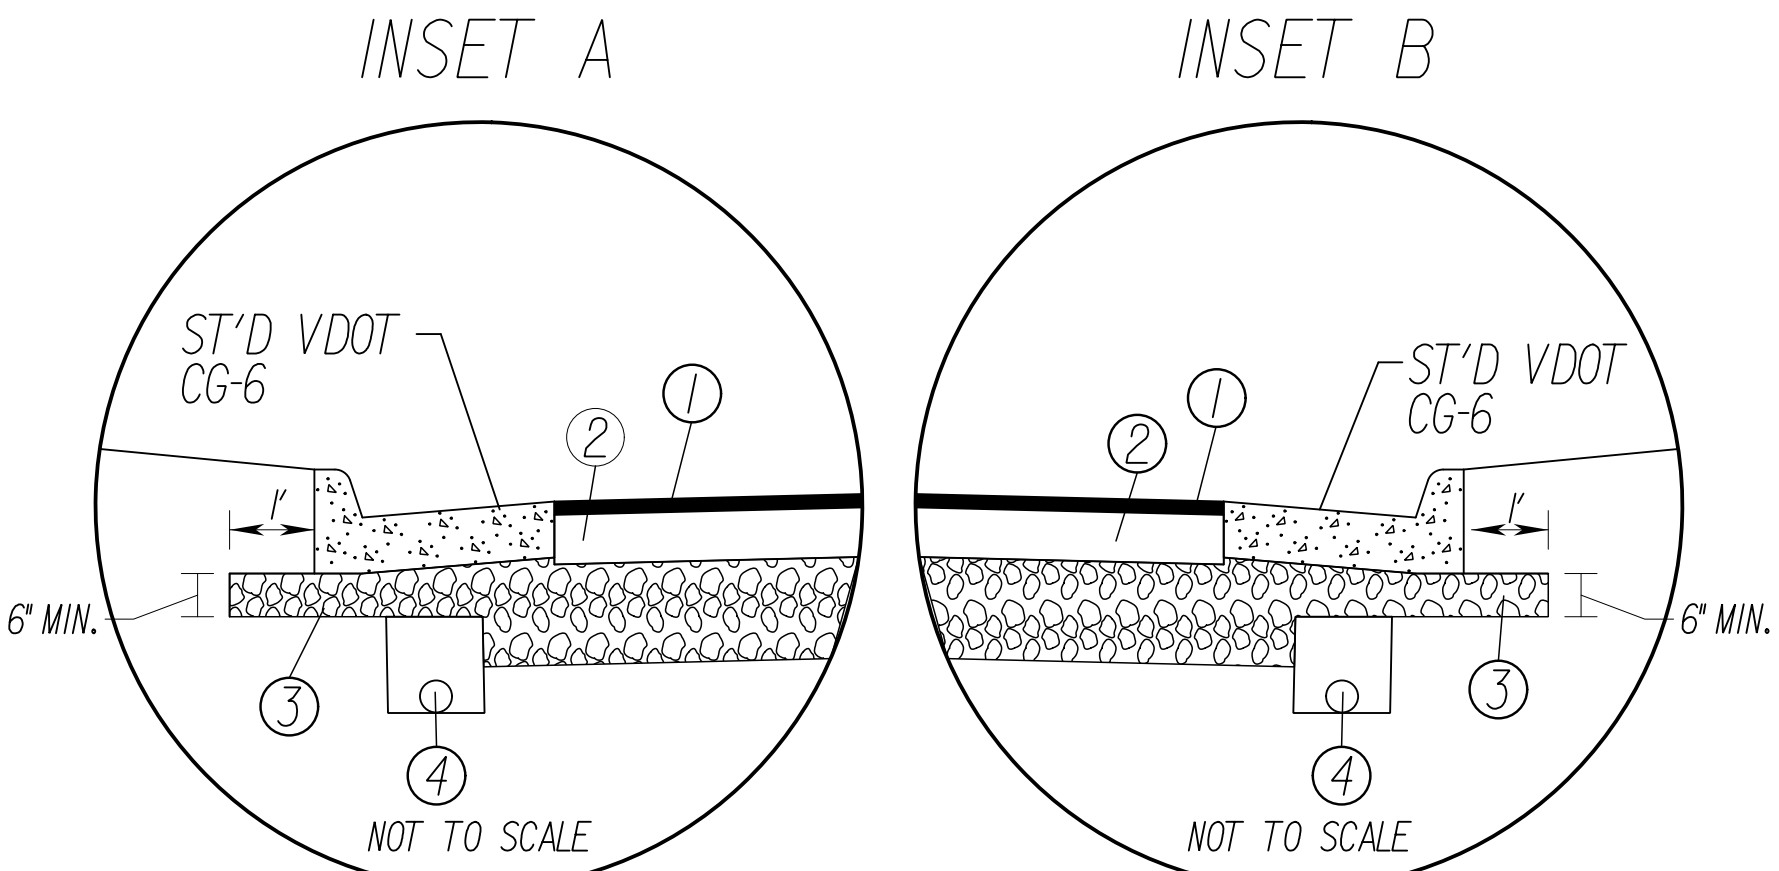- FOR APPROXIMATE LIMITS OF FULL DEPTH PAVEMENT AND MILL AND OVERLAY, REFER TO THE PLAN SHEETS.
- EXISTING PAVEMENT LAYERS WITHIN THE LIMITS OF SAWCUT AND THE EDGE OF PAVEMENT ARE TO BE REMOVED AND DISPOSED OF IN ACCORDANCE WITH 2016 ROAD AND BRIDGE SPECIFICATIONS.
- ALL PAVEMENT WIDENING SHALL BE PERFORMED IN ACCORDANCE WITH ST'D VDOT WP-2.
- SEE SHEET 2C FOR ASPHALT TRAIL DETAIL.



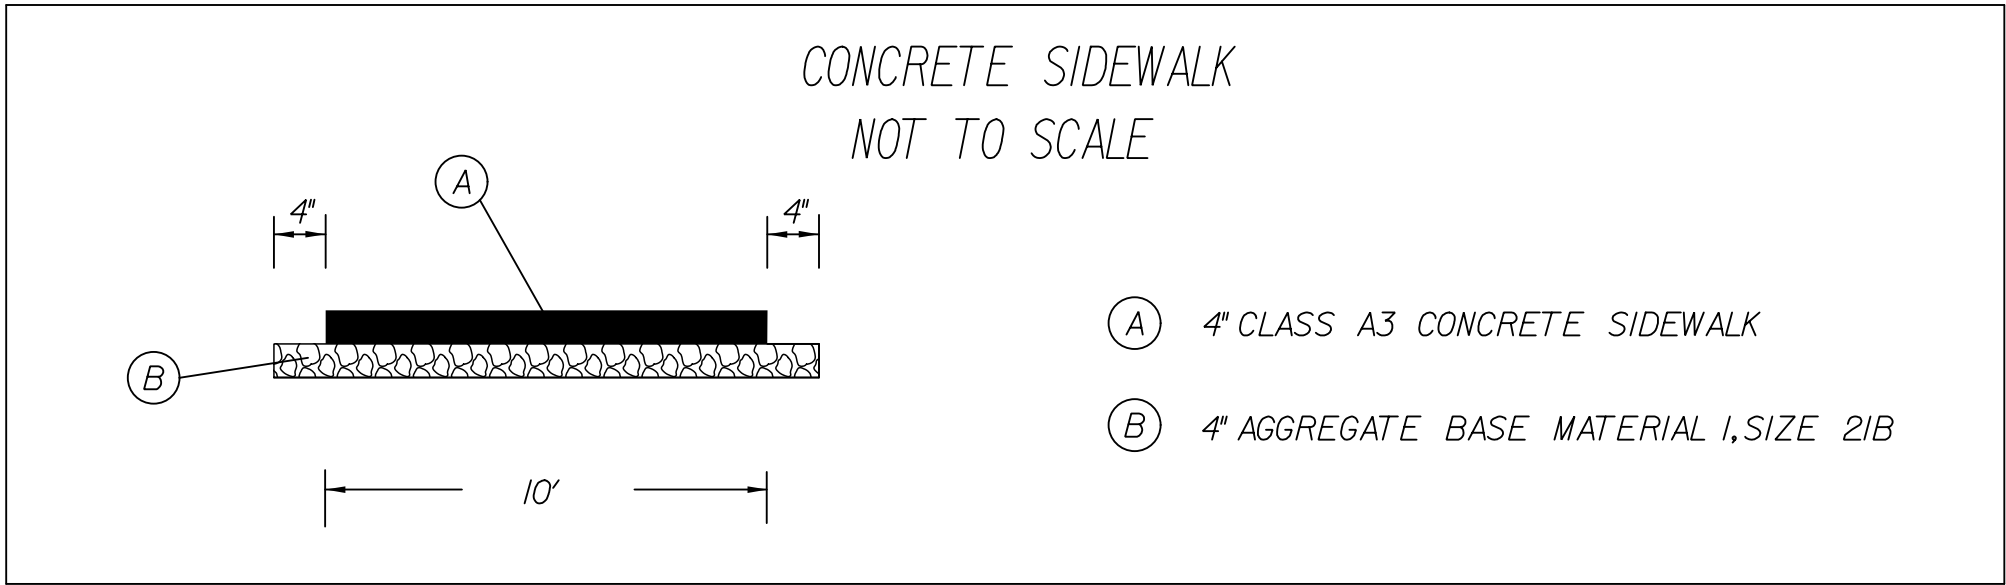- SURFACE - 2" ASPHALT CONCRETE TYPE SM-9.5D ESTIMATED AT 244 LBS/SY
- BASE - 6.5" ASPHALT CONCRETE TYPE BM-25.0A
- SUBBASE - 12" AGGREGATE BASE MATERIAL TYPE 1 SIZE 21B OR EXTEND TO THE BOTTOM OF THE EXISTING AGGREGATE BASE MATERIAL, WHICHEVER IS GREATER
- ST'D VDOT UD-4



EMERGENCY POLICE - FIRE - RESCUE 911			
FAIRFAX COUNTY, VIRGINIA			
DEPARTMENT OF PUBLIC WORKS AND ENVIRONMENTAL SERVICES			
12000 GOVERNMENT CENTER PARKWAY, SUITE 449 FAIRFAX, VA., 22035-0052			
OFFICE OF CAPITAL FACILITIES 703-324-5800			
WIEHLE AVENUE (RTE 828) AT W&OD TRAIL TYPICAL SECTIONS			
PROJECT NO: 1400102-2013			
SCALE NTS		DESIGNED: NDD DRAFTED: WRA CHECKED: RBH	SHEET 2B
FUND # 500-C5000			

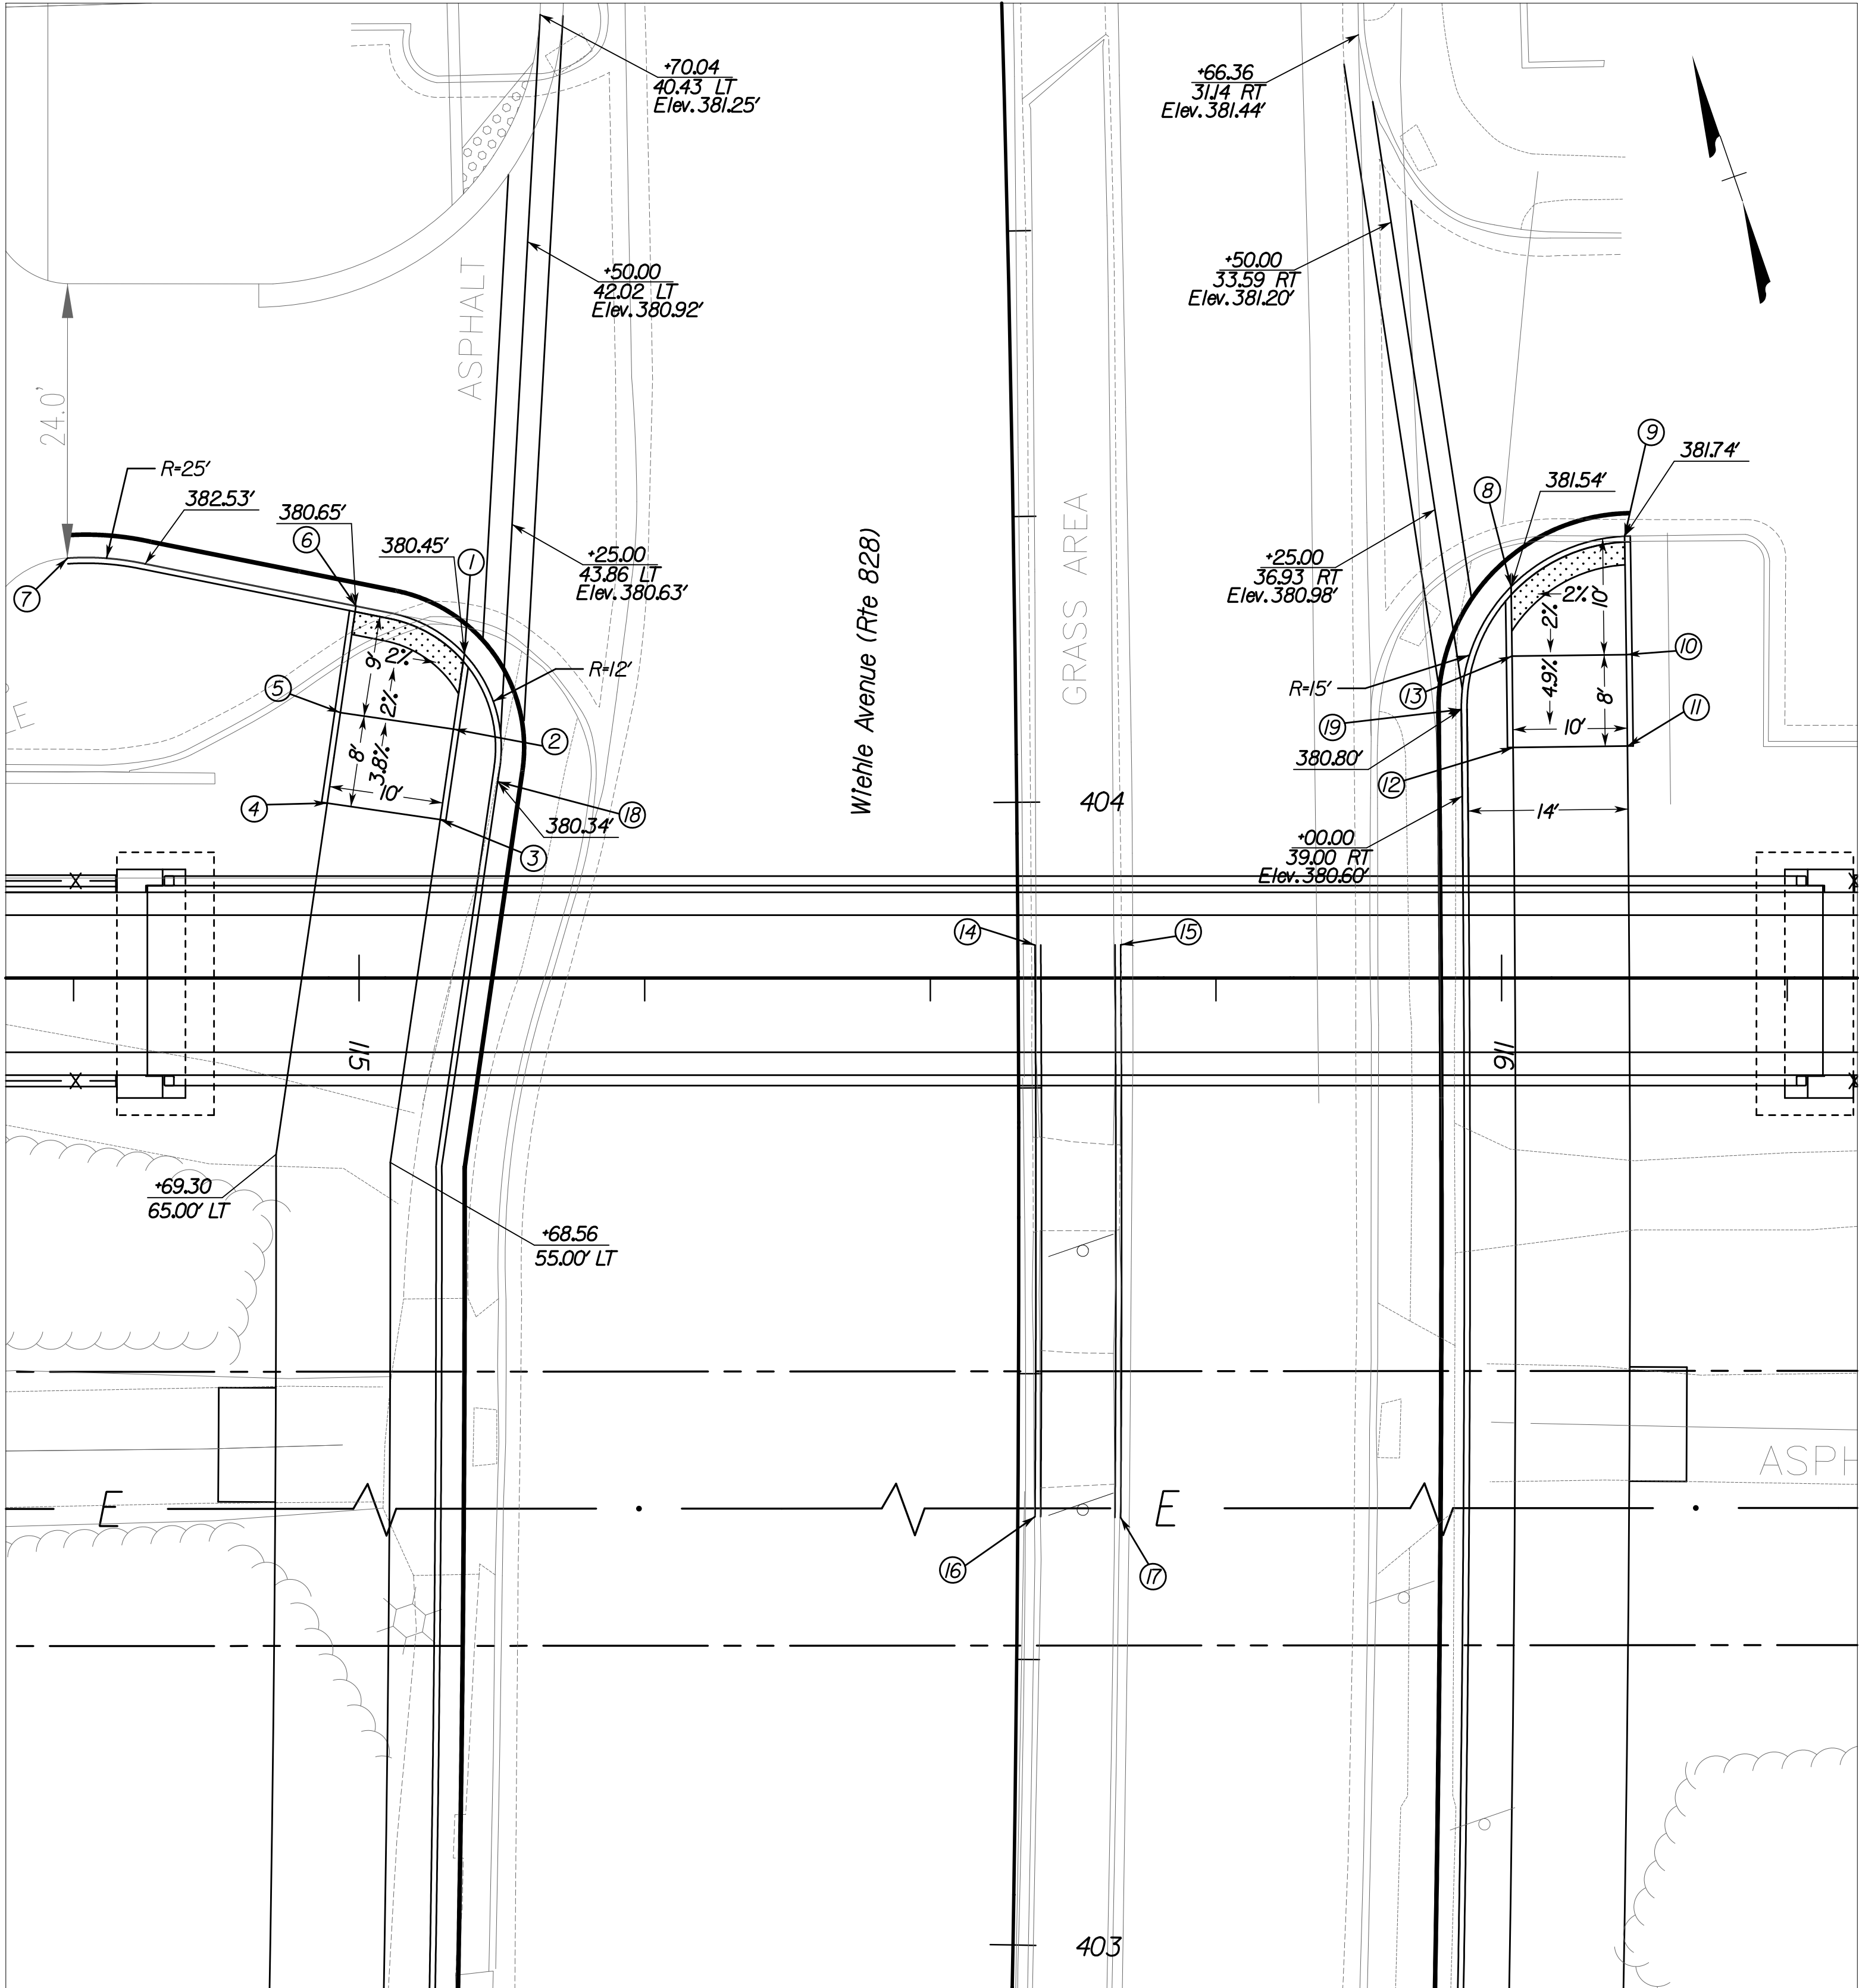







PROJECT MANAGER: SCOTT RUEFFNER, P.E. (703) 877-5736  
SURVEYED BY, DATE: FAIRFAX COUNTY, NOVEMBER 28, 2014  
DESIGN BY: WHITMAN, REQUARDT & ASSOCIATES, LLP (703) 293-9712  
SUBSURFACE UTILITY BY, DATE: SO DEEP, INC. (703) 361-6005 DECEMBER 23, 2014

CURB RAMP DETAIL SHEET



POINT	FACE OF CURB	TOP OF CURB	LANDING	BACK OF RAMP	STATION	OFFSET	COMMENTS
1	---	380.95	380.45	---	404+13.62	48.20' LT	NOSE DOWN
2	380.57	381.07	---	---	404+06.97	49.24' LT	---
3	---	---	---	380.87	403+98.96	50.47' LT	---
4	---	---	---	381.07	404+00.52	60.35' LT	---
5	380.77	381.37	---	---	404+08.54	59.11' LT	---
6	---	381.15	380.65	---	404+18.00	57.63' LT	NOSE DOWN
7	383.17	383.67	---	---	404+22.65	82.81' LT	MATCH EXIST.
8	---	382.04	381.54	---	404+18.26	43.50' RT	NOSE DOWN
9	---	382.24	381.74	---	404+22.46	53.50' RT	CURVE PT NOSE DOWN
10	381.86	382.36	---	---	404+12.24	53.50' RT	---
11	---	---	---	381.47	404+04.33	53.50' RT	---
12	---	---	---	381.27	404+04.33	43.50' RT	---
13	381.66	382.16	---	---	404+12.24	43.50' RT	---
14	381.72	382.22	---	---	403+87.49	1.50' RT	MATCH EXIST.
15	381.47	381.97	---	---	403+87.47	9.00' RT	MATCH EXIST.
16	381.22	381.72	---	---	403+37.49	1.50' RT	MATCH EXIST.
17	380.65	381.15	---	---	403+37.47	9.00' RT	MATCH EXIST.
18	380.34	380.84	---	---	404+02.27	45.41' LT	CURVE PC
19	381.08	381.58	---	---	404+07.68	39.00' RT	CURVE PC

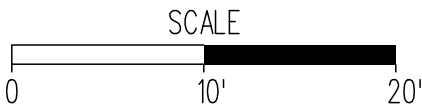


THESE PLANS ARE UNFINISHED AND UNAPPROVED AND ARE NOT TO BE USED FOR ANY TYPE OF CONSTRUCTION.

EMERGENCY POLICE - FIRE - RESCUE 911			
FAIRFAX COUNTY, VIRGINIA			
DEPARTMENT OF PUBLIC WORKS AND ENVIRONMENTAL SERVICES			
12000 GOVERNMENT CENTER PARKWAY, SUITE 449 FAIRFAX, VA., 22035-0052			
OFFICE OF CAPITAL FACILITIES 703-324-5800			
WIEHLE AVENUE (RTE 828) AT W&OD TRAIL CURB RAMP DETAIL SHEET			
PROJECT NO: 1400102-2013			
SCALE 1"=10'		DESIGNED: NDD DRAFTED: WRA CHECKED: RBH	SHEET 2D(1)
APPROVED BY THE TRANSPORTATION DESIGN DIVISION			

FUND # 500-C5000



# CURB RAMP DETAIL SHEET

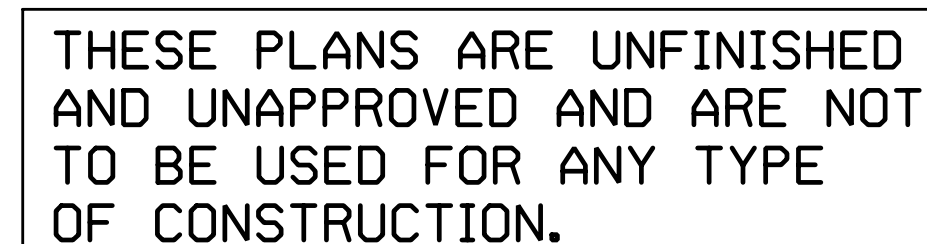[illegible]

EMERGENCY POLICE - FIRE - RESCUE 911							
FAIRFAX COUNTY, VIRGINIA							
DEPARTMENT OF PUBLIC WORKS AND ENVIRONMENTAL SERVICES							
12000 GOVERNMENT CENTER PARKWAY, SUITE 449 FAIRFAX, VA., 22035-0052							
R E V I S I O N S					OFFICE OF CAPITAL FACILITIES 703-324-5800		
					WIEHLE AVENUE (RTE 828) AT W&OD TRAIL CURB RAMP DETAIL SHEET		
					PROJECT NO: 1400102-2013		
					SCALE	DESIGNED: NDD	SHEET
					1"=10'	DRAFTED: WRA	2D(2)
						CHECKED: RBH	
	△#	DESCRIPTION	BY	APPROVED	DATE		
APPROVED BY THE TRANSPORTATION DESIGN DIVISION							
					FUND # 500-C5000		

FUND #	500-C5000
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INSERTABLE SHEETS

Anchor posts should be a minimum 2 in steel 'U' channel, 6 ft in length


Maximum distance between posts of 6 ft

Orange plastic fence, welded wire fence, chain link fence, silt fence or super silt fence

Fence height 4 ft

**Note: Tree protection fencing should be maintained throughout construction**

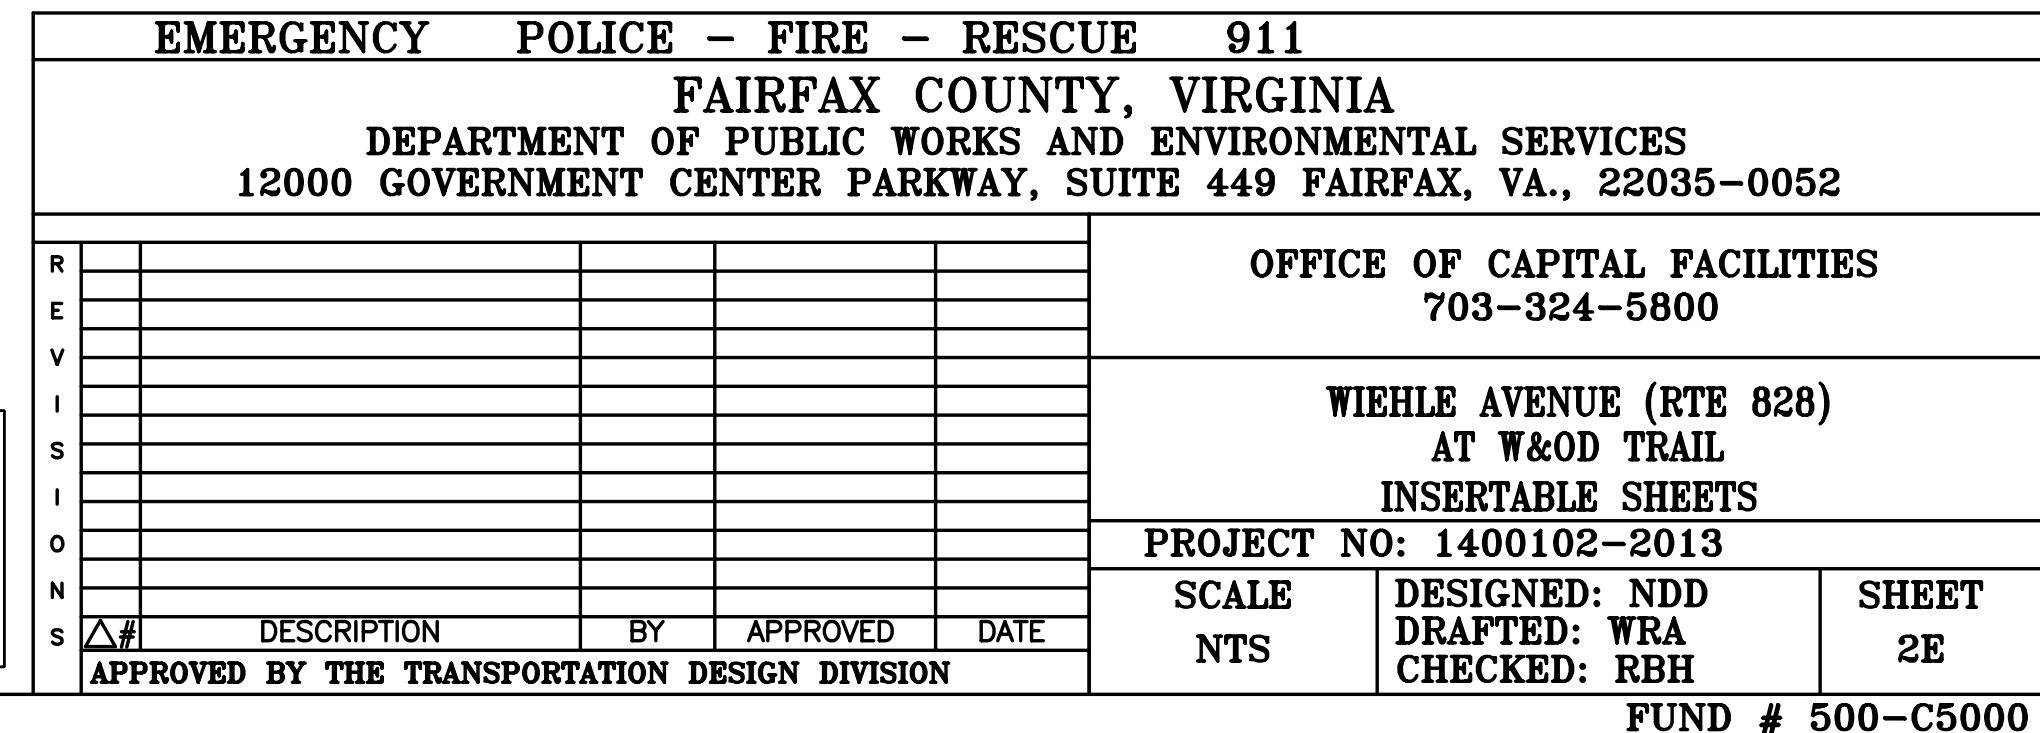Use 8 in wire U staples to secure fence bottom





PROJECT MANAGER \_ SCOTT RUFFNER, P.E., (703) 877-5736 -----  
SURVEYED BY, DATE \_ FAIRFAX COUNTY, NOVEMBER 28, 2014 -----  
DESIGN BY \_ WHITMAN, REQUARDT & ASSOCIATES, LLP, (703) 293-9717 -----  
SUBSURFACE UTILITY BY, DATE \_ SQ. DEEP, INC., (703) 361-6005, DECEMBER 23, 2014 -----

PROJECT INFORMATION						
PROJECT INFORMATION						
PROJECT NAME		W&OD TRAIL AT WIEHLE AVE				
COUNTY PROJECT NUMBER		1400102-2013				
VDOT UPC NUMBER (IF APPLICABLE)		PE - 140294		RW - 107439		CN - 107439
PROJECT LIMITS / LENGTH		1,800 L.F. PAVED TRAIL AND 147 L.F. PED. BRIDGES				
FUNDING SOURCE		FEDERAL REGIONAL SURFACE TRANSPORTATION PROGRAM & CONGESTION MITIGATION AIR QUALITY IMPROVEMENTS PROGRAM				
DATE OF FUNDING OBLIGATION		OCTOBER 24, 2014				
LATITUDE/ LONGITUDE		LAT 38.9505		LONG -77.3358		
6TH ORDER HUC		PL22				
TYPE OF DEVELOPMENT:						
<input type="checkbox"/> NEW DEVELOPMENT <input checked="" type="checkbox"/> REDEVELOPMENT						
STORMWATER MANAGEMENT TECHNICAL CRITERIA USED:						
<input checked="" type="checkbox"/> VSMP TECHNICAL CRITERIA IIB / FFX CO STORMWATER MANAGEMENT ORDINANCE ARTICLE 4						
<input type="checkbox"/> VSMP TECHNICAL CRITERIA IIC / FFX CO STORMWATER MANAGEMENT ORDINANCE ARTICLE 5						
SWM WAIVER/EXCEPTION(S) REQUIRED: YES <input checked="" type="checkbox"/> NO <input type="checkbox"/> APPROVAL DATE: _____						
TYPE(S): _____ LDS NUMBER: _____						
A) IS PROJECT LOCATED WITHIN THE WATER SUPPLY PROTECTION OVERLAY DISTRICT (WSPOD)? YES <input type="checkbox"/> NO <input checked="" type="checkbox"/>						
B) IS PROJECT A PUBLIC IMPROVEMENT (PI) PLAN SUBJECT TO FULL LDS REVIEW/APPROVAL? YES <input type="checkbox"/> NO <input checked="" type="checkbox"/>						
C) IS PROJECT A LINEAR PROJECT SUBJECT TO VDOT REVIEW/APPROVAL AND VDOT LUP PROCESS? YES <input checked="" type="checkbox"/> NO <input type="checkbox"/>						
IF ANSWER TO BOTH A & B IS YES, SEE NOTE (3). IF ANSWER TO BOTH A & C IS YES, SEE NOTE (3.1).						
CONSTRUCTION SITE AREAS						
TOTAL SITE AREA		3.08		(AC)	134,200	(SF)
TOTAL DISTURBED AREA		3.08		(AC)	134,200	(SF)
TOTAL SITE IMPERVIOUS AREA		PRE	1.14	(AC)	POST	1.55 (AC)
VPDES PERMIT REQUIREMENTS (CHECK ONE):						
<input type="checkbox"/> DISTURBED AREA < 1 (AC) ; VPDES PERMIT NOT REQUIRED.						
<input checked="" type="checkbox"/> DISTURBED AREA ≥ 1 (AC) ; VPDES PERMIT IS REQUIRED.						
RECEIVING WATERS						
WATERSHED NAME: POTOMAC RIVER-DIFFICULT RUN-COLVIN RUN		RECEIVING STREAM: COLVIN RUN				
IS THERE A LOCAL TMDL RESTRICTION WITHIN THE PROJECT WATERSHED AREA YES <input type="checkbox"/> NO <input checked="" type="checkbox"/>						
IF YES PROVIDE DESCRIPTION OF IMPAIRED WATERS + TMDL TYPE						

NOTE:

(1) FOR ADDITIONAL DETAILS SEE THE LATEST REVISION OF THE DRAINAGE/SWM REPORT AND EROSION AND SEDIMENT CONTROL PLAN SHEET 3B-6B.

(2) THIS IS A COUNTY ADMINISTERED PROJECT AND THE STORM WATER POLLUTION PREVENTION PLAN (SWPPP) IS PREPARED BY FAIRFAX COUNTY. WHEN APPLICABLE, IT WILL BE INCLUDED WITH THE CONSTRUCTION PACKAGE.

(3) PURCHASE OF NUTRIENT CREDITS MAY NOT BE USED TO SATISFY DEQ'S WATER QUALITY REQUIREMENTS ON THIS PROJECT.

(3.1) PURCHASE OF NUTRIENT CREDITS MAY BE USED TO SATISFY DEQ'S WATER QUALITY REQUIREMENTS ON THIS PROJECT.

STORMWATER INFORMATION TABLE

STORMWATER INFORMATION												
HIGH DENSITY POLYETHYLENE (HDPE) USED ON THIS PROJECT YES <input checked="" type="checkbox"/> NO <input type="checkbox"/>												
THE PLAN MEETS: TIME LIMITS ON APPLICABILITY OF APPROVED DESIGN CRITERIA <input checked="" type="checkbox"/>												
THE PLAN MEETS THE GRANDFATHERING CRITERIA <input type="checkbox"/>												
SWM FACILITIES (PROPOSED ONLY)												
FACILITY ID NO.	FACILITY TYPE	PURPOSE	AREA TREATED (ACRES)	LATITUDE (DECIMAL DEGREE)	LONGITUDE (DECIMAL DEGREE)	WATERSHED	RECEIVING WATERS	MAINTENANCE AGREEMENT Y/N	VAHUS CODE	LENGTH/ AREA OF FACILITY	UNIT (FT/ SQ)	NO. OF BLDG. SERVED (FOR ROOFTOP DISCONNECT)
	Purchased Credits	Water Quality	N/A	38.9505	-77.3358	Potomac-Difficult Run	Colvin Run	N	PL22	N/A		N/A
VPDES REQUIRED YES <input checked="" type="checkbox"/> NO <input type="checkbox"/>												
VPDES PERMIT NO. (IF TIME LIMITS): _____												
COUNTY STORMWATER PERMIT REQUIRED YES <input checked="" type="checkbox"/> NO <input type="checkbox"/>												
SWM FACILITIES DESIGNED USING: TECHNICAL CRITERIA 4 (NEW) <input checked="" type="checkbox"/>												
TECHNICAL CRITERIA 5 (OLD) <input type="checkbox"/>												
DISTURBED AREA (DA) WITHIN WATERSHED(S):												
WATERSHED 1_Potomac-Difficult Run- Colvin R. DA= 3.08 (ACRES)												
WATERSHED 2_____ DA=_____ (ACRES)												
TOTAL DISTURBED AREA= 3.08 (ACRES)												

# PROJECT DATA SHEET

(FEDERAL/STATE FUNDED PROJECT)

TABLE 1.  
WATER QUALITY ANALYSIS PER VSMP TECHNICAL CRITERIA IIB / FFX CO STORMWATER MANAGEMENT ORDINANCE ARTICLE 4

RECEIVING WATERS	OUTFALL		TOTAL DISTURBED AREA		PRE DEVELOPMENT LAND USE				POST DEVELOPMENT LAND USE				PHOSPHORUS REMOVAL REQUIRED	ON-SITE PHOSPHORUS REMOVAL PROVIDED	IS PROJECT LOCATED WITHIN WSPOD	
	ID	LOCATION	(AC)	(SF)	FORESTED (AC)	TURF (AC)	IMPERVIOUS AREA (AC)	OTHER (AC)	FORESTED (AC)	TURF (AC)	IMPERVIOUS AREA (AC)	OTHER (AC)	(LB/YR)	(LB/YR)	YES (3)(3.1)	NO (4)
COLVIN RUN	COLVIN RUN		3.08	134200		1.94	1.14			1.53	1.55		1.39	0.0		X

NOTE:

(4.) PHOSPHORUS REMOVAL TO BE PROVIDED BY THE PURCHASE OF OFFSITE NUTRIENT CREDITS. PLEASE SEE TABLE 2 BELOW FOR MORE INFORMATION.

TABLE 2.  
OFFSITE COMPLIANCE FOR WATER QUALITY (NUTRIENT CREDITS)

NUTRIENT CREDIT BANK NAME	4TH ORDER HUC	NUTRIENT CREDIT TO BE ACQUIRED (LB/YR)	PURCHASE LETTER (MM/DD/YY) (5)
NAME TO BE PROVIDED UPON PURCHASE	02070008	1.39	MM/DD/YY

NOTE:

(5.) THE "AFFIDAVIT OF PHOSPHOROUS CREDIT SALE" WILL BE PROVIDED ON SHEET 2G UPON COMPLETION OF PURCHASE BY VDOT.

(6.) UPON APPROVAL OF SWM MEASURES BY FAIRFAX COUNTY LDS AND VDOT DRAINAGE AND SUBSEQUENT TO RECEIVING CLEARANCE FROM VDOT NOVA HYDRAULIC ENGINEER, A REQUEST FOR PURCHASE OF NUTRIENT CREDITS INCLUDING THE LATEST REVISION OF VDOT LD-453 FORM AND OTHER REQUIRED DRAINAGE DOCUMENTS WILL BE SUBMITTED BY FAIRFAX COUNTY DOT TO VDOT NOVA HYDRAULIC ENGINEER. UPON REVIEW/APPROVAL, THE REQUEST WILL BE FORWARDED TO VDOT CENTRAL OFFICE BY NOVA HYDRAULIC ENGINEER.



SITE DEVELOPMENT AND INSPECTIONS DIVISION APPROVAL STAMP

OWNER/REPRESENTATIVE CONTACT INFORMATION	
NAME:	WAYNE KOTTER, CHIEF, STORMWATER & TRANSPORTATION CONSTRUCTION BRANCH
PHONE NUMBER:	703-324-5111
EMAIL ADDRESS:	WAYNE.KOTTER@FAIRFAXCOUNTY.GOV
ADDRESS:	UTILITIES DESIGN AND CONSTRUCTION DIVISION 12000 GOVERNMENT CENTER PKWY SUITE 463 FAIRFAX, VA 22035

CONSULTANT CERTIFIED E&S PLAN REVIEWER OR PE	CONSULTANT STORMWATER MANAGEMENT PLAN REVIEWER
5-29-2018	5-29-2018

EMERGENCY POLICE - FIRE - RESCUE 911				REVISED: APRIL 2018			
FAIRFAX COUNTY, VIRGINIA DEPARTMENT OF PUBLIC WORKS AND ENVIRONMENTAL SERVICES 12000 GOVERNMENT CENTER PARKWAY, SUITE 449 FAIRFAX, VA., 22035-0052							
OFFICE OF CAPITAL FACILITIES 703-324-5800				WIEHLE AVENUE (RTE 828) AT W&OD TRAIL PROJECT DATA SHEET			
PROJECT NO: 1400102-2013				SCALE NTS			
DESIGNED: NDD DRAFTED: WRA CHECKED: RBH				SHEET 2F			
APPROVED BY THE TRANSPORTATION DESIGN DIVISION							

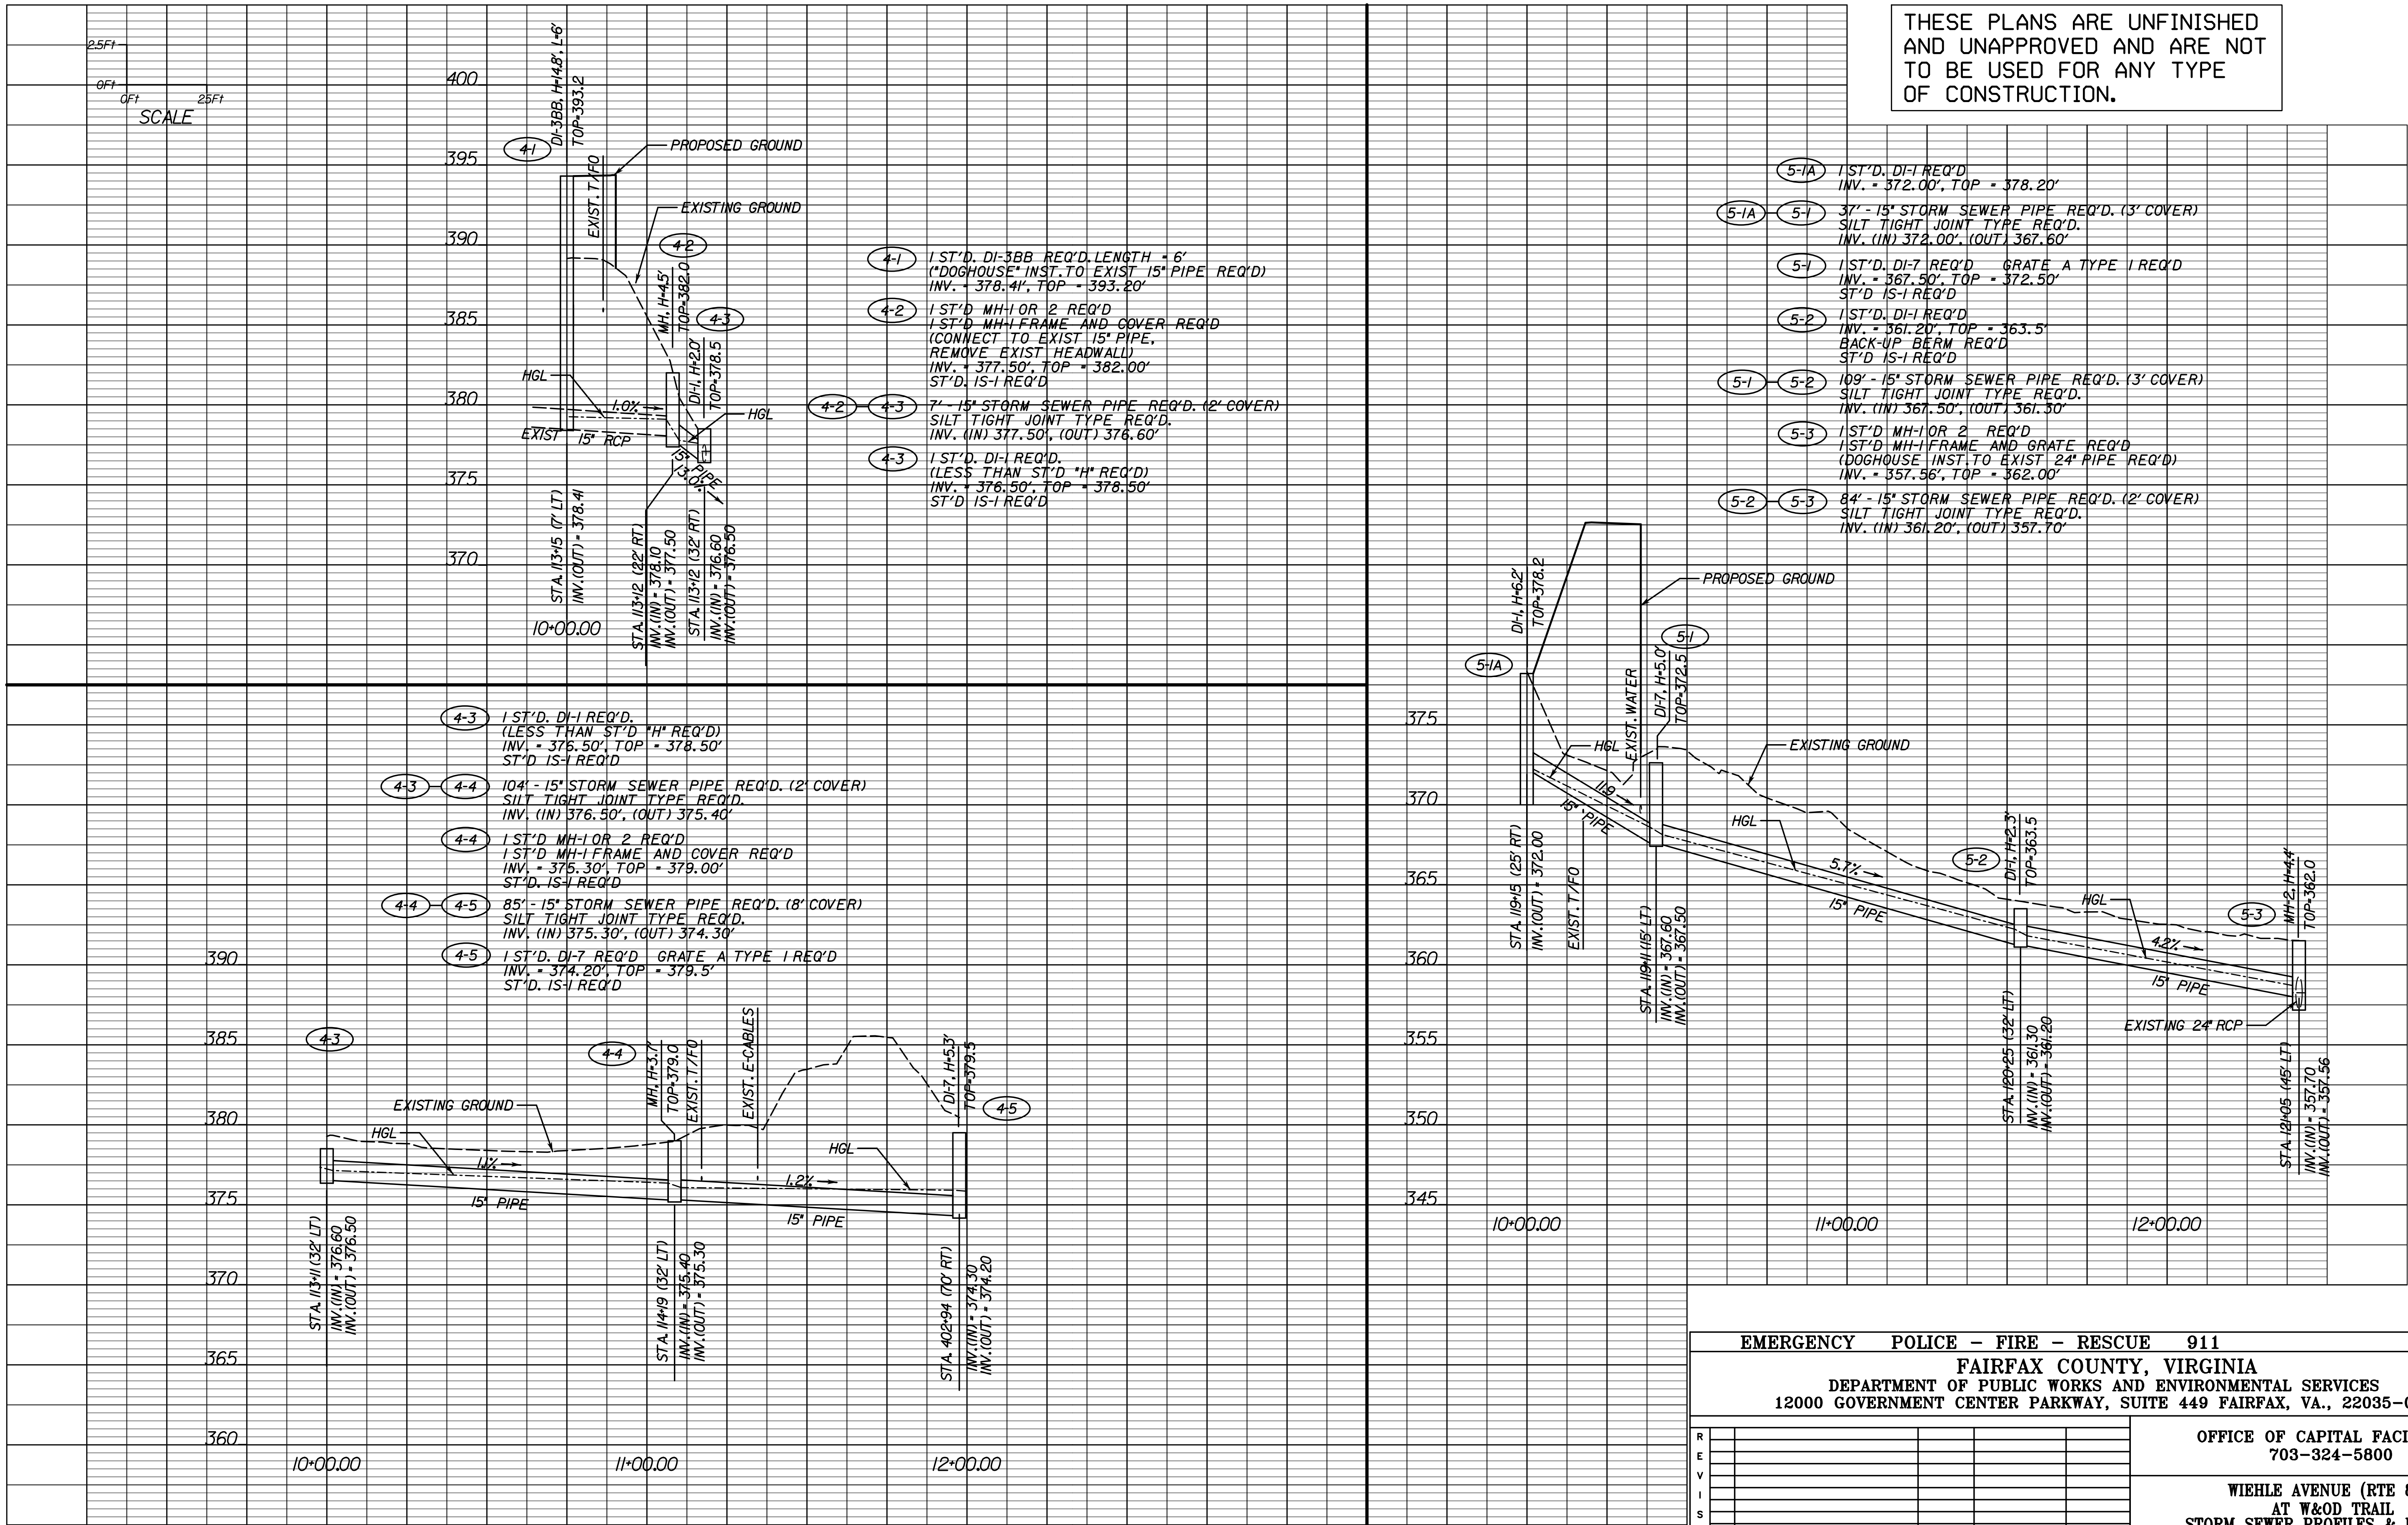




Whitman, Requardt & Associates, LLP

# STORM SEWER PROFILES

THESE PLANS ARE UNFINISHED  
AND UNAPPROVED AND ARE NOT  
TO BE USED FOR ANY TYPE  
OF CONSTRUCTION.



NOTE:  
1. POST-CONSTRUCTION PIPE INSTALLATION INSPECTION SHALL BE PROVIDED  
AS REQUIRED PER SECTION 302.03(D) OF THE VDOT 2016 SUPPLEMENTAL  
ROAD & BRIDGE SPECIFICATIONS.


EMERGENCY POLICE - FIRE - RESCUE 911			
FAIRFAX COUNTY, VIRGINIA			
DEPARTMENT OF PUBLIC WORKS AND ENVIRONMENTAL SERVICES			
12000 GOVERNMENT CENTER PARKWAY, SUITE 449 FAIRFAX, VA., 22035-0052			
OFFICE OF CAPITAL FACILITIES 703-324-5800			
WIEHLE AVENUE (RTE 828)			
AT W&D TRAIL			
STORM SEWER PROFILES & DRAINAGE			
DESCRIPTIONS			
PROJECT NO: 1400102-2013			
SCALE	DESIGNED: NDD	SHEET	
AS SHOWN	DRAFTED: WRA	2H(1)	
CHECKED: RBH			
APPROVED BY THE TRANSPORTATION DESIGN DIVISION			
FUND # 500-C5000			





Whitman, Requardt & Associates, LLP

# STORM SEWER PROFILES

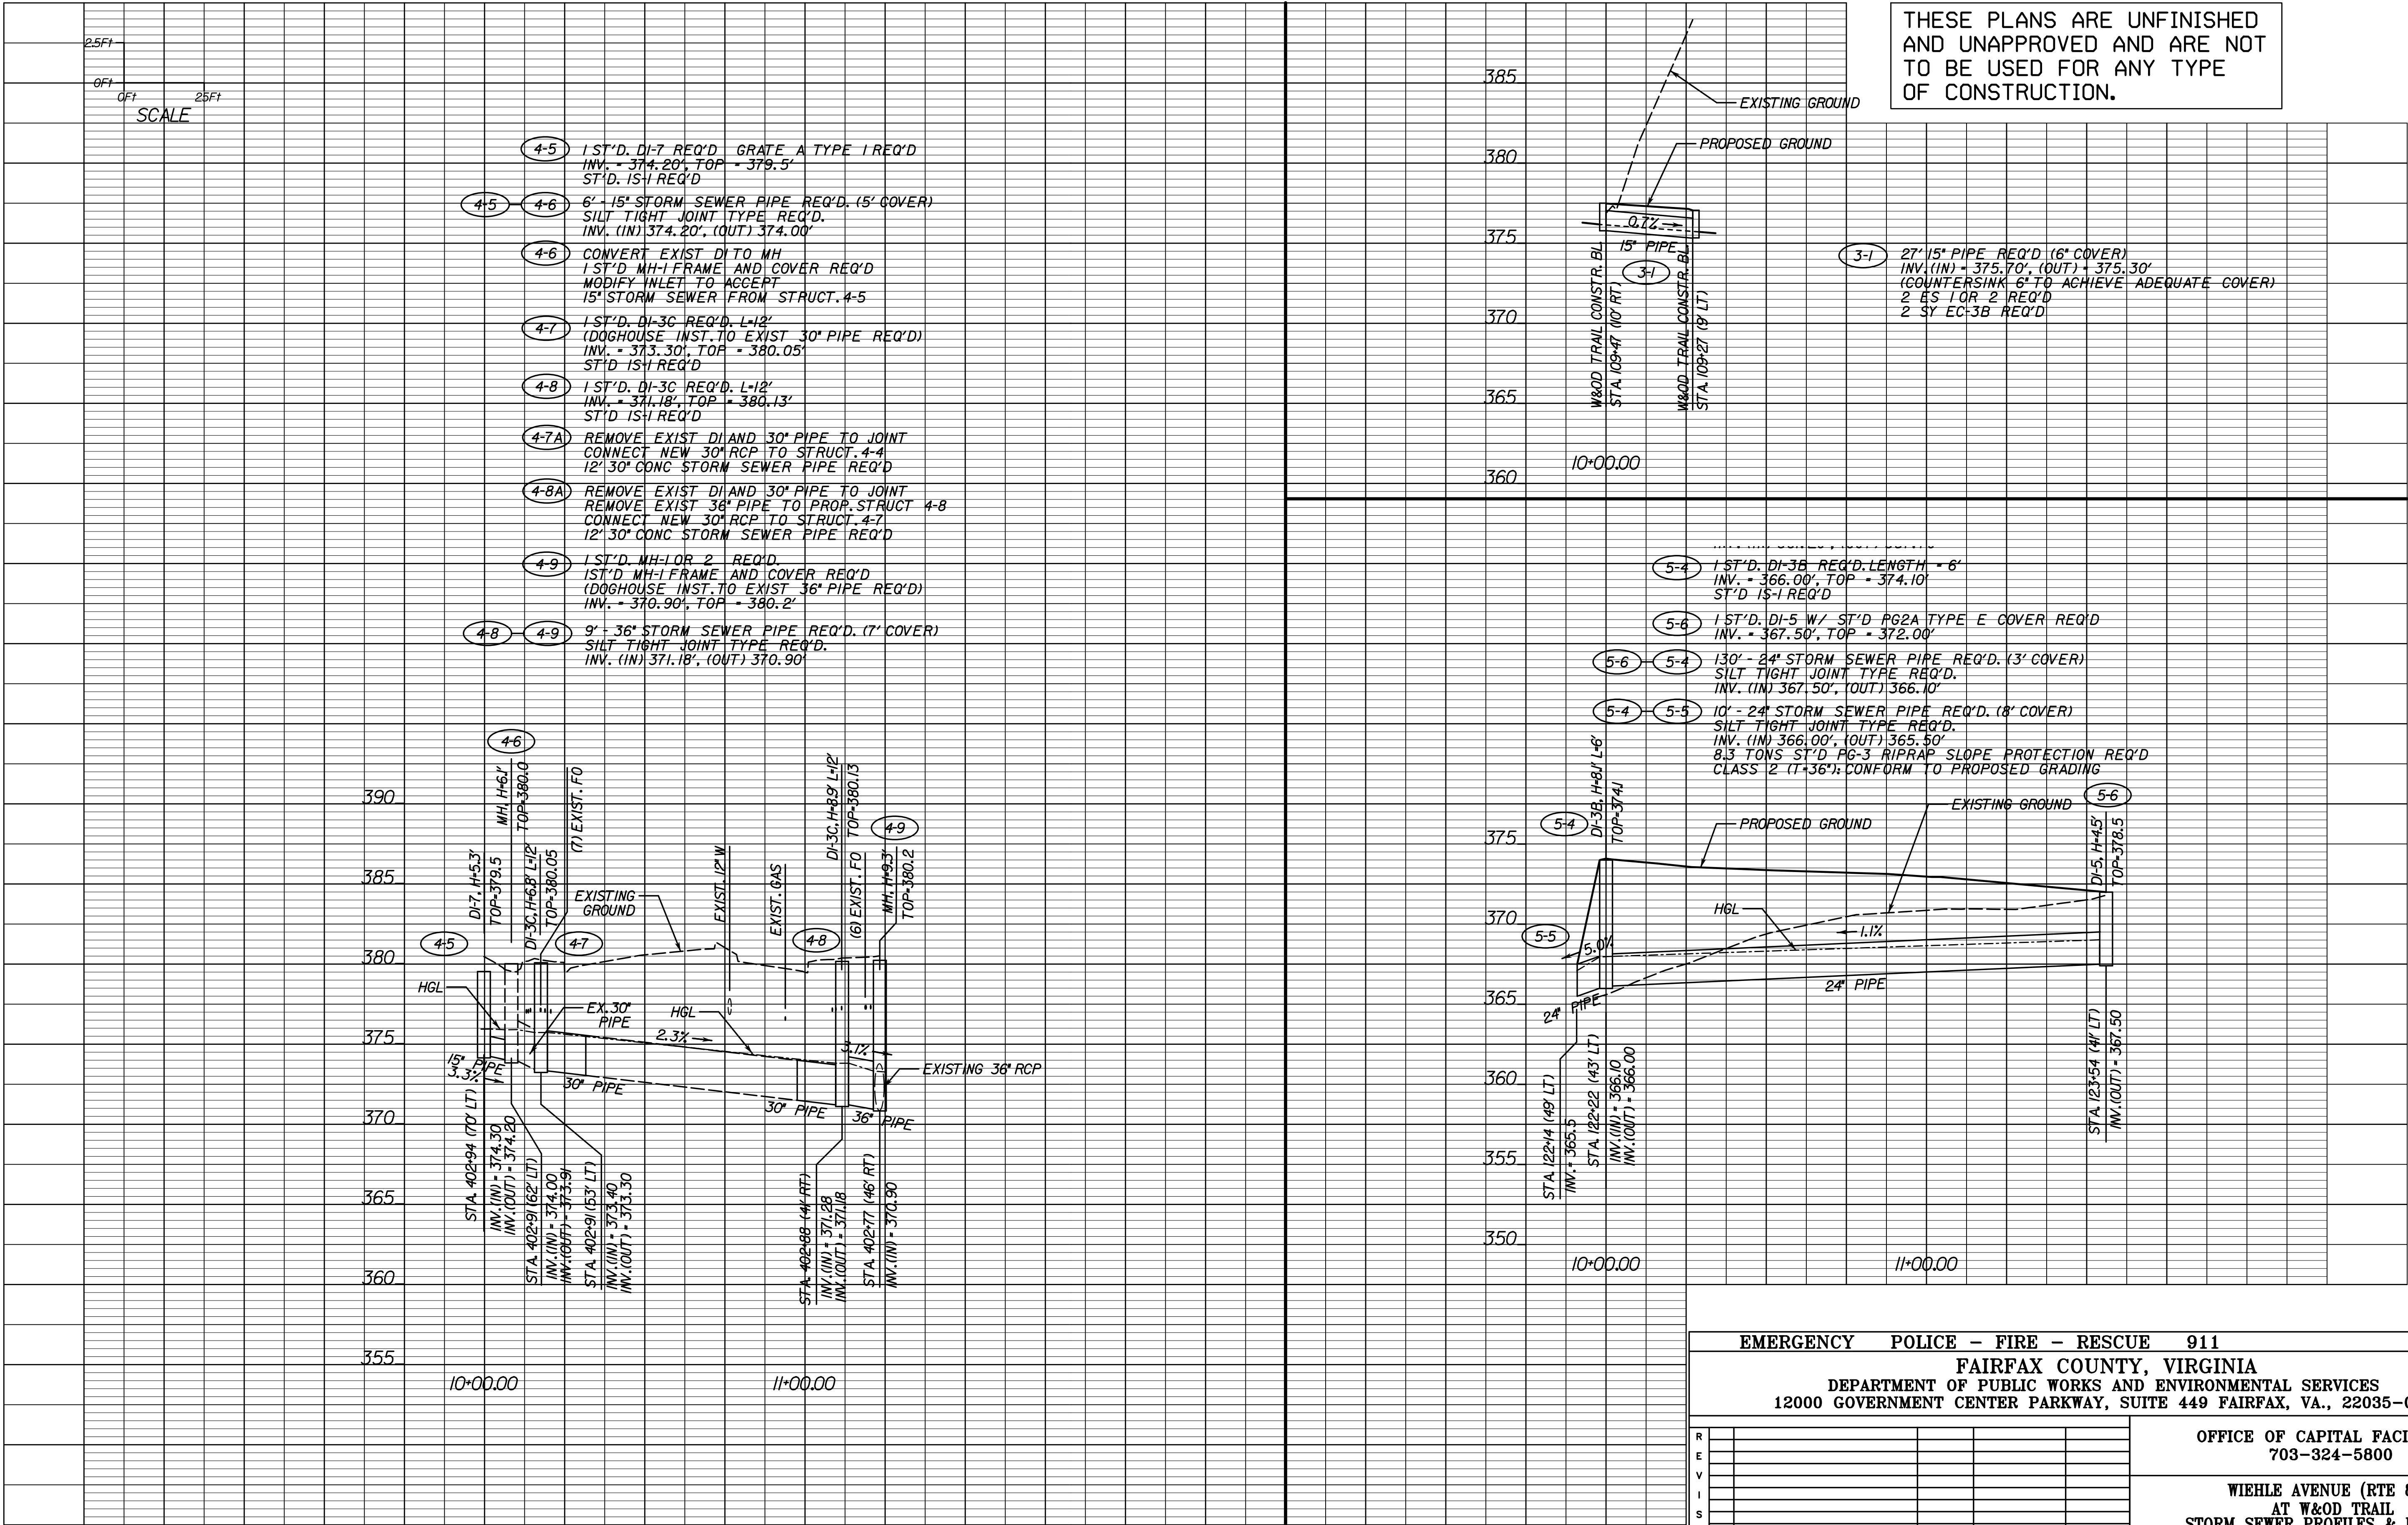


THESE PLANS ARE UNFINISHED AND UNAPPROVED AND ARE NOT TO BE USED FOR ANY TYPE OF CONSTRUCTION.

NOTE:  
1. POST-CONSTRUCTION PIPE INSTALLATION INSPECTION SHALL BE PROVIDED AS REQUIRED PER SECTION 302.03(D) OF THE VDOT 2016 SUPPLEMENTAL ROAD & BRIDGE SPECIFICATIONS.

EMERGENCY POLICE - FIRE - RESCUE 911			
FAIRFAX COUNTY, VIRGINIA			
DEPARTMENT OF PUBLIC WORKS AND ENVIRONMENTAL SERVICES			
12000 GOVERNMENT CENTER PARKWAY, SUITE 449 FAIRFAX, VA., 22035-0052			
OFFICE OF CAPITAL FACILITIES 703-324-5800			
WIEHLE AVENUE (RTE 828)			
AT W&OD TRAIL			
STORM SEWER PROFILES & DRAINAGE			
DESCRIPTIONS			
PROJECT NO: 1400102-2013			
SCALE	DESIGNED: NDD	SHEET	
AS SHOWN	DRAFTED: WRA	2H(2)	
CHECKED: RBH			
APPROVED BY THE TRANSPORTATION DESIGN DIVISION			
FUND # 500-C5000			



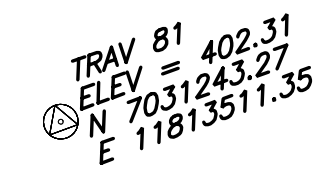3  
APA PROPERTIES NO 6 LP  
PART OF BLOCK 2-A  
SECTION 905  
RESTON  
D.B. 5232, PG. 374  
TAX MAP 17-4 ((5)) 6S4



FUND #	500-C5000
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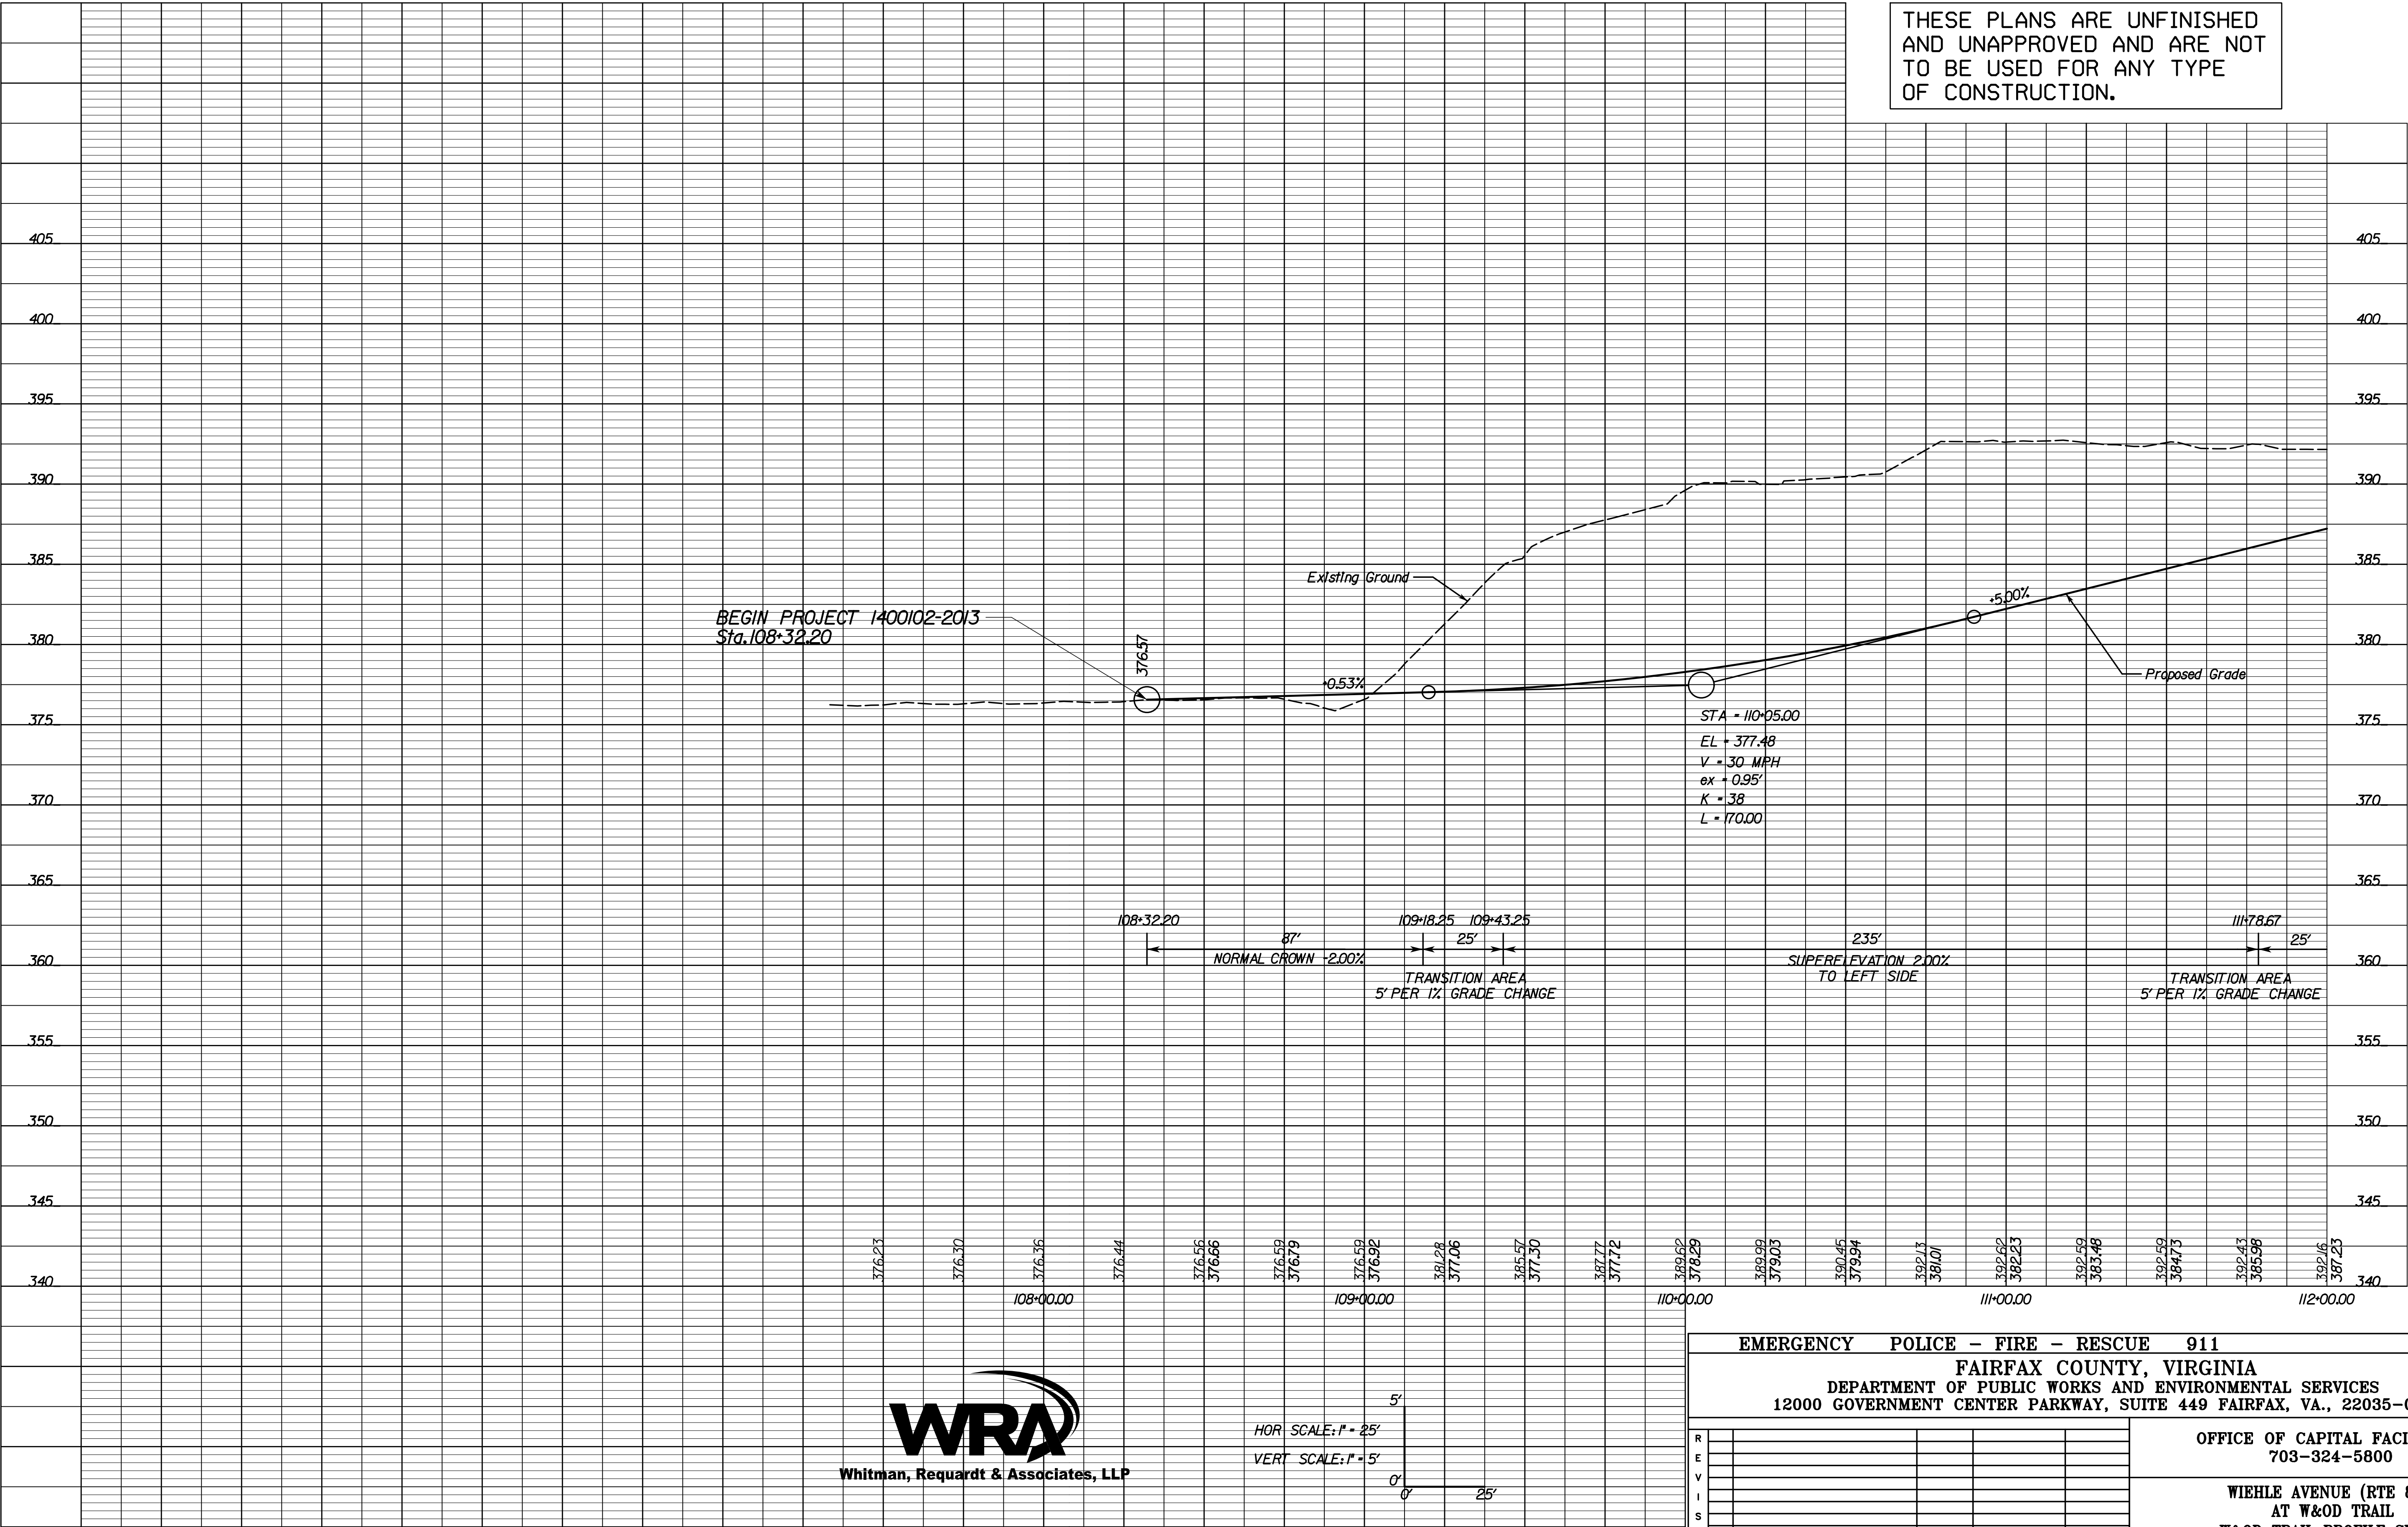


PROJECT MANAGER: SCOTT RUFFNER, P.E. (703) 877-5736  
SURVEYED BY, DATE: FAIRFAX COUNTY, NOVEMBER 28, 2014  
DESIGN BY: WHITMAN, REQUARDT & ASSOCIATES, LLP (703) 293-9072  
SUBSURFACE UTILITY BY, DATE: SQ DEEP, INC. (703) 361-6002, DECEMBER 23, 2014

# W&OD TRAIL

## CONSTRUCTION BASELINE

THESE PLANS ARE UNFINISHED  
AND UNAPPROVED AND ARE NOT  
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EMERGENCY POLICE - FIRE - RESCUE 911			
FAIRFAX COUNTY, VIRGINIA			
DEPARTMENT OF PUBLIC WORKS AND ENVIRONMENTAL SERVICES			
12000 GOVERNMENT CENTER PARKWAY, SUITE 449 FAIRFAX, VA., 22035-0052			
OFFICE OF CAPITAL FACILITIES 703-324-5800			
WIEHLE AVENUE (RTE 828) AT W&OD TRAIL W&OD TRAIL PROFILE SHEET			
PROJECT NO: 1400102-2013			
SCALE AS SHOWN		DESIGNED: NDD DRAFTED: WRA CHECKED: RBH	SHEET 3A(1)
APPROVED BY THE TRANSPORTATION DESIGN DIVISION			

FUND # 500-C5000

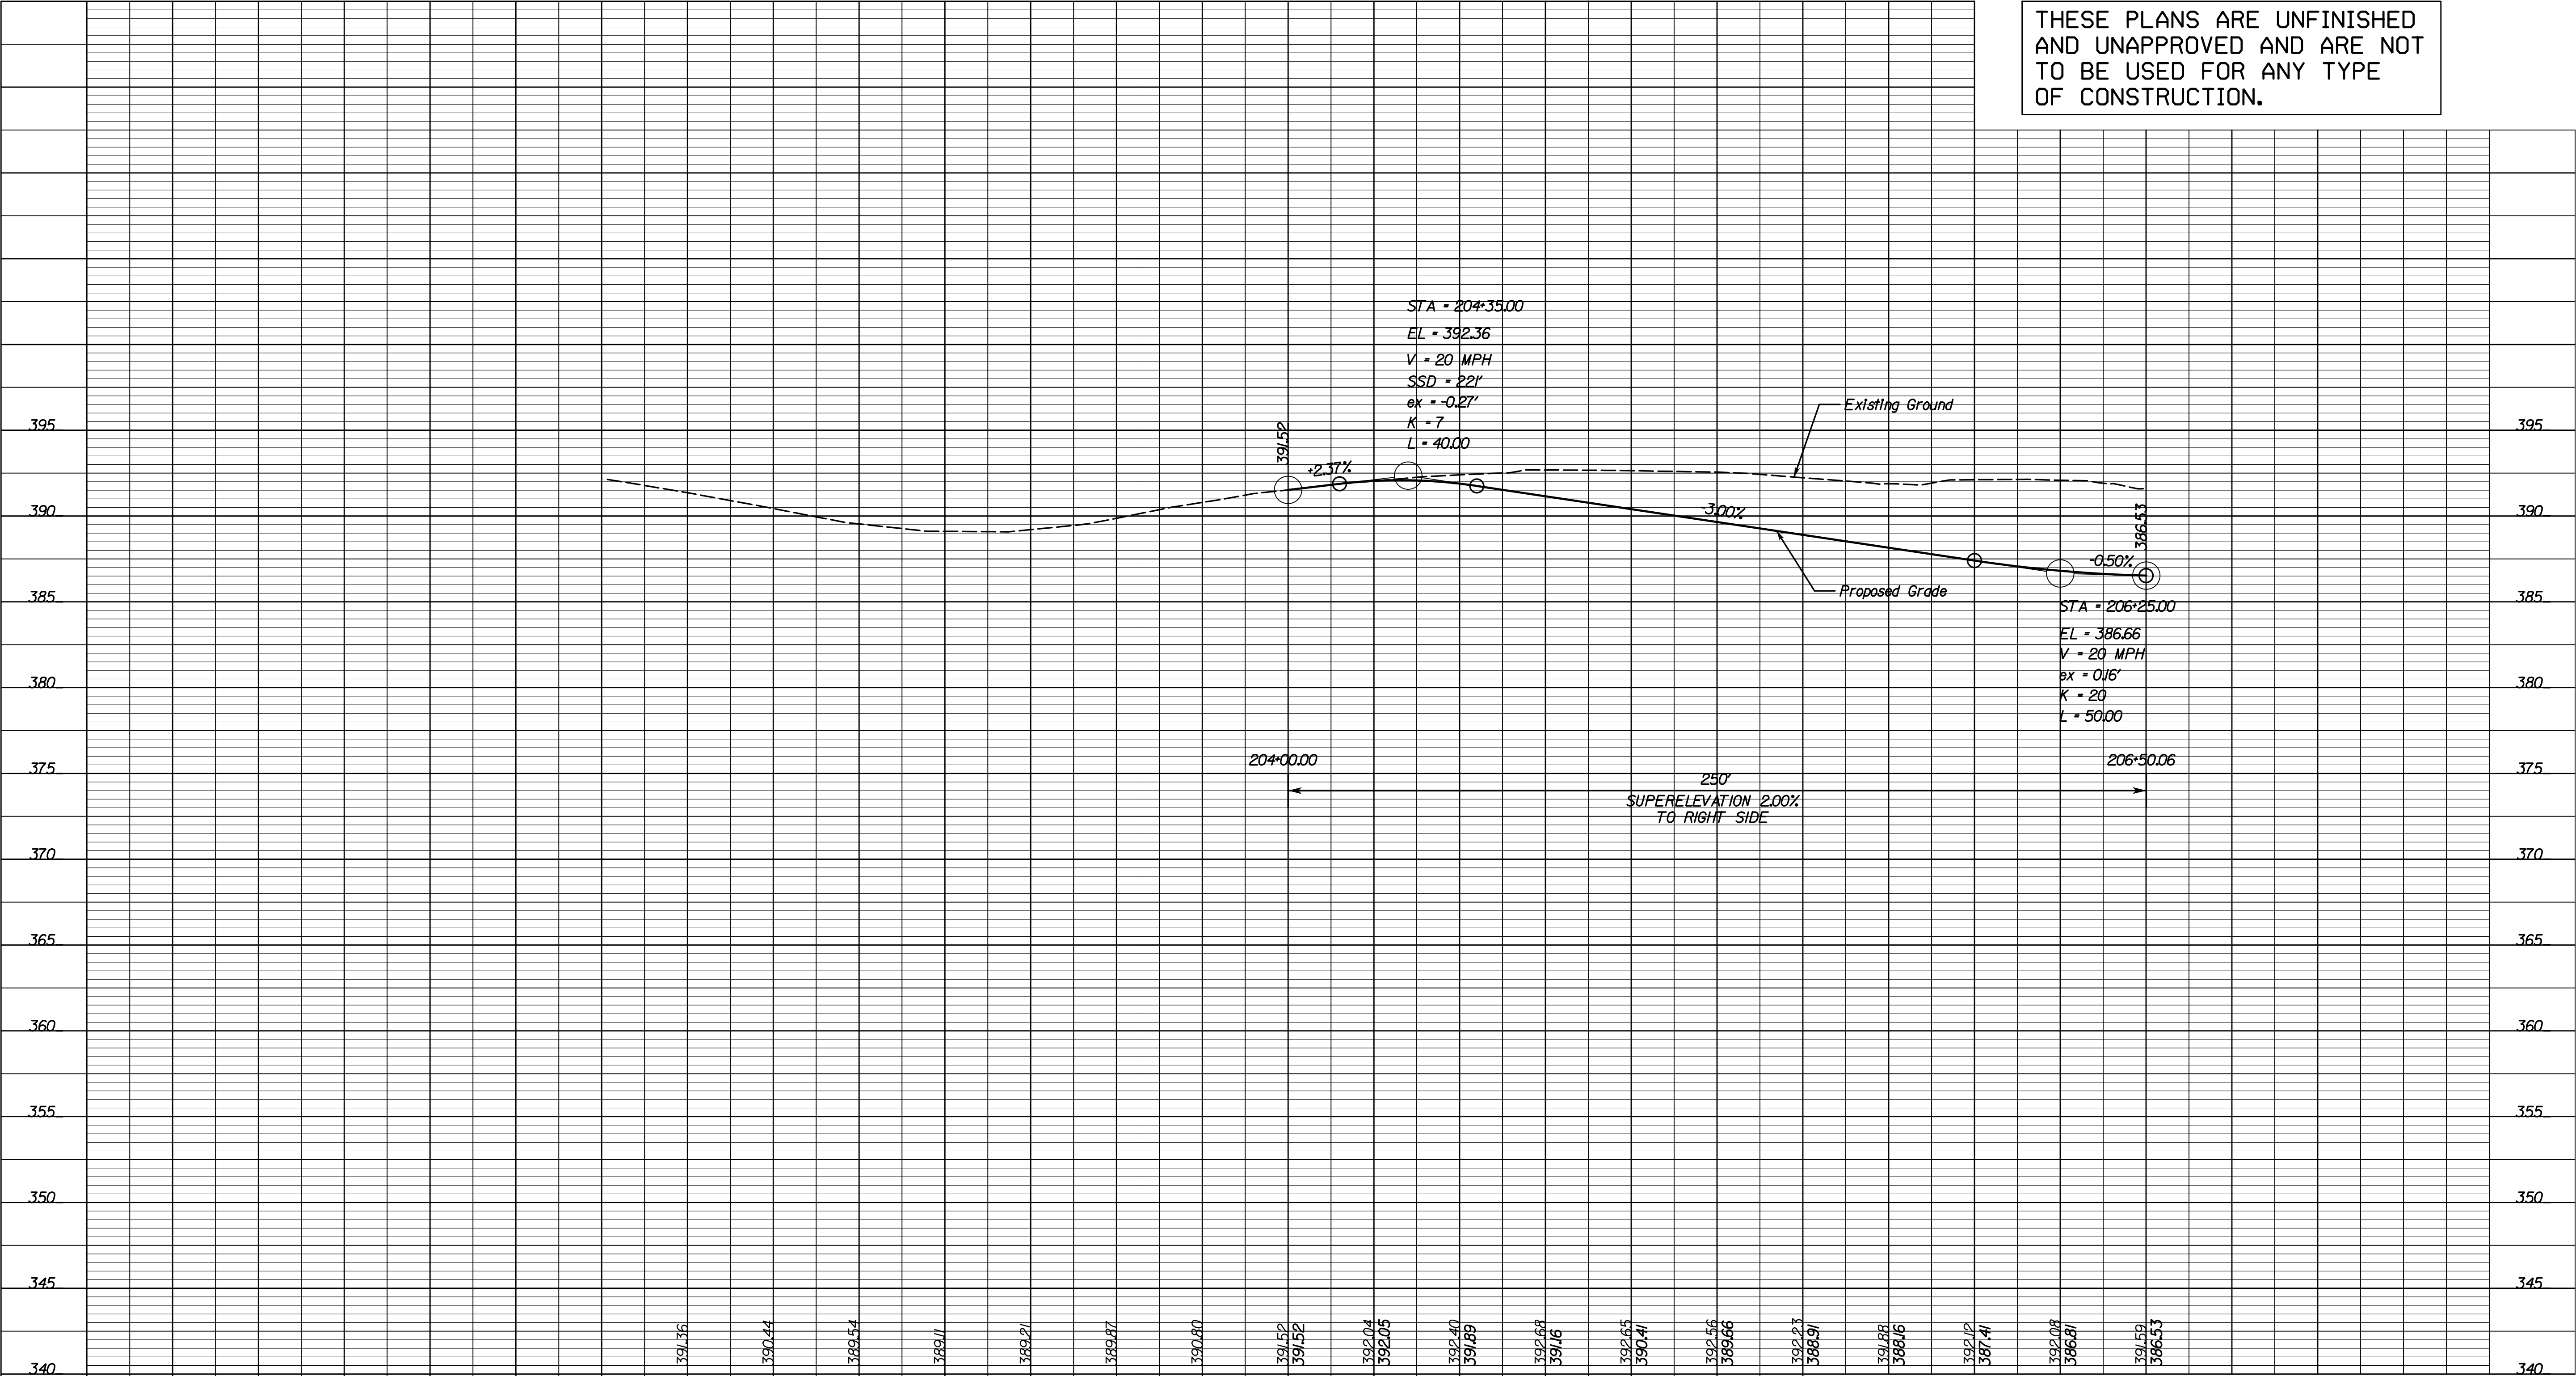


PROJECT MANAGER: SCOTT RUFFNER, P.E. (703) 877-5736  
SURVEYED BY, DATE: FAIRFAX COUNTY, NOVEMBER 28, 2014  
DESIGN BY: WHITMAN, REQUARDT & ASSOCIATES, LLP (703) 293-9072  
SUBSURFACE UTILITY BY, DATE: SQ DEEP, INC. (703) 361-6002, DECEMBER 23, 2014

# GRAVEL TRAIL A

## CONSTRUCTION BASELINE

THESE PLANS ARE UNFINISHED  
AND UNAPPROVED AND ARE NOT  
TO BE USED FOR ANY TYPE  
OF CONSTRUCTION.



Whitman, Requardt & Associates, LLP

HOR SCALE: 1" = 25'  
VERT SCALE: 1" = 5'


EMERGENCY POLICE - FIRE - RESCUE 911			
FAIRFAX COUNTY, VIRGINIA			
DEPARTMENT OF PUBLIC WORKS AND ENVIRONMENTAL SERVICES			
12000 GOVERNMENT CENTER PARKWAY, SUITE 449 FAIRFAX, VA., 22035-0052			
OFFICE OF CAPITAL FACILITIES			
703-324-5800			
WIEHLE AVENUE (RTE 828)			
AT W&OD TRAIL			
GRAVEL TRAIL A PROFILE SHEET			
PROJECT NO: 1400102-2013			
SCALE		DESIGNED: NDD	SHEET
AS SHOWN		DRAFTED: WRA	3A(2)
APPROVED BY THE TRANSPORTATION DESIGN DIVISION		CHECKED: RBH	

FUND # 500-C5000



PROJECT MANAGER: SCOTT RUFFNER, P.E. (703) 871-5736  
SURVEYED BY, DATE: FAIRFAX COUNTY, NOVEMBER 28, 2014  
DESIGN BY: WHITMAN, REQUARDT & ASSOCIATES, LLP (703) 293-9717  
SUBSURFACE UTILITY BY, DATE: SO DEEP, INC. (703) 361-6005 DECEMBER 23, 2014

# EROSION & SEDIMENT CONTROL PLAN

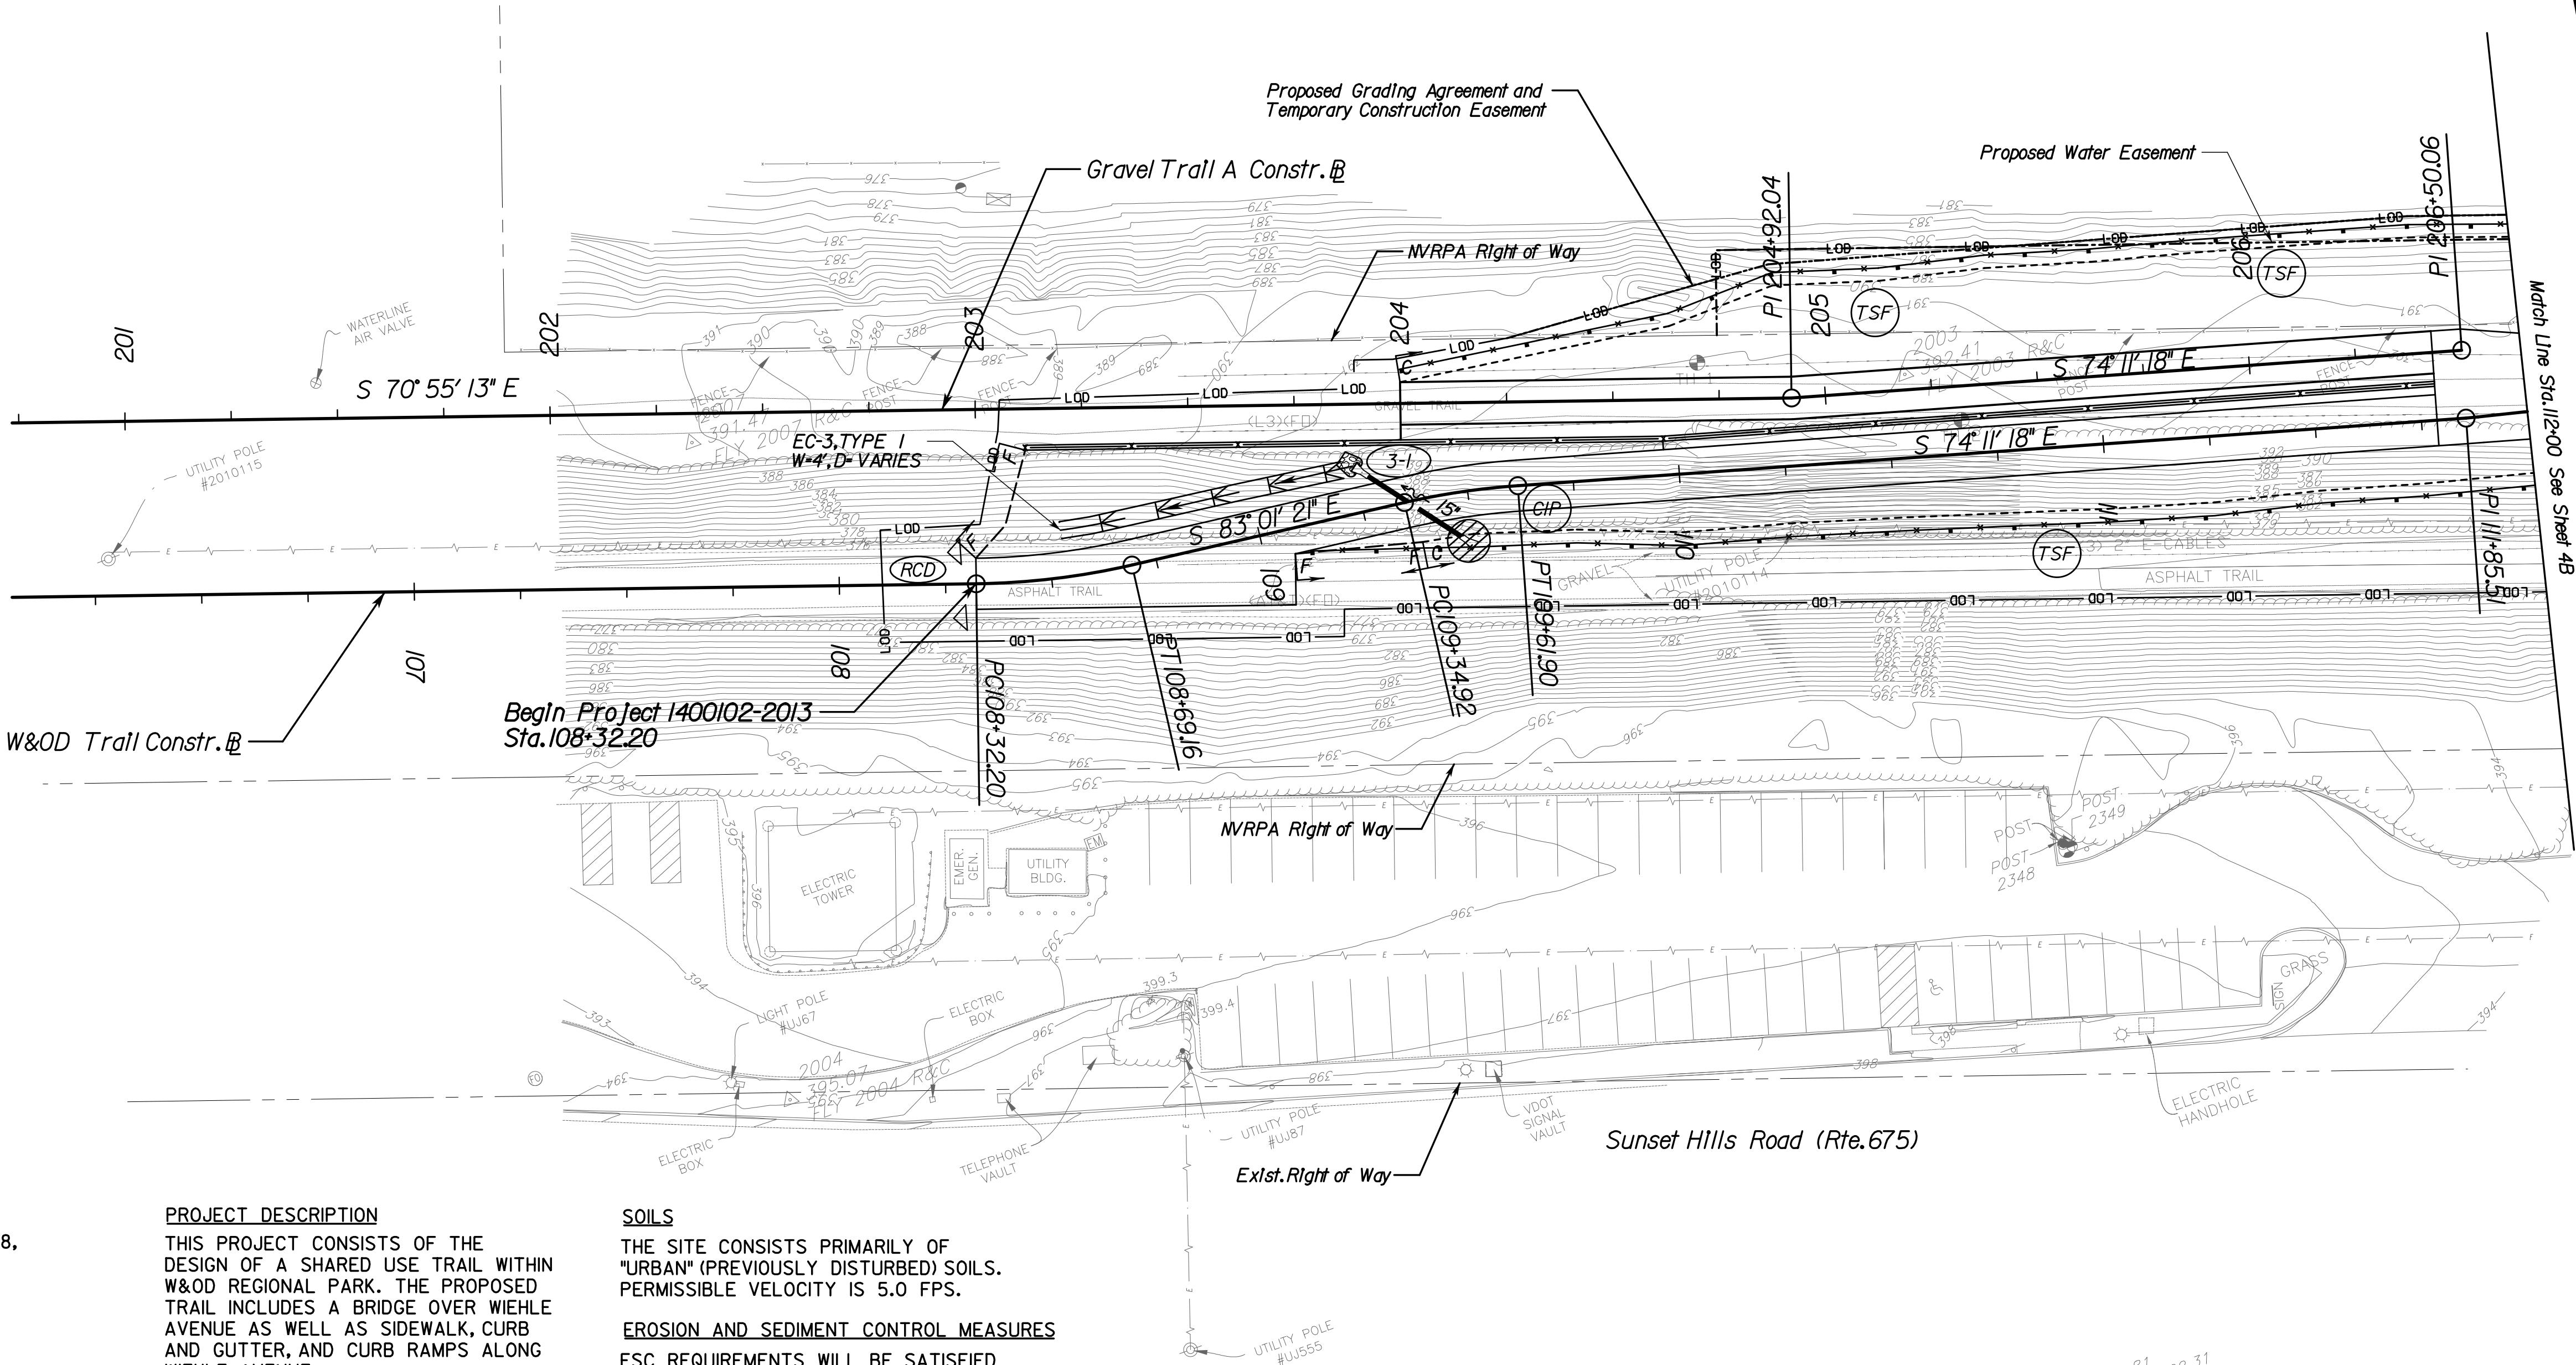

**NOTES:**  
1.) THIS SHEET IS TO BE USED FOR EROSION AND SEDIMENT CONTROL MEASURES ONLY!

## LEGEND

- C --- DENOTES CONSTRUCTION LIMITS IN CUT  
--- F --- DENOTES CONSTRUCTION LIMITS IN FILL  
--- EC-3 --- DENOTES EC-3  
--- LOD --- DENOTES LIMITS OF DISTURBANCE  
--- IP-A --- IP-B --- DENOTES INLET PROTECTION, VESCH 3.07 AND 3.08, GUTTER BUDDY ONLY (SEE DETAIL ON SHEET 2E)  
--- RCD --- DENOTES ROCK CHECK DAMS, ST'D EC-4 TYPE II  
--- TSF --- DENOTES TEMPORARY SILT FENCE, ST'D EC-5  
--- CIP --- DENOTES CULVERT INLET PROTECTION, ST'D EC-6 TYPE C

## THE SEQUENCE OF E&S MEASURES IS GENERALLY AS FOLLOWS:

- 1.) INSTALL PERIMETER ESC MEASURES, INCLUDING SILT FENCE AND ROCK CHECK DAMS.
- 2.) PLACE INLET PROTECTION ON EXISTING STORM DRAIN SYSTEMS.
- 3.) INSTALL TEMPORARY AND PERMANENT PIPES AND CHANNELS USED TO CONVEY OFFSITE RUNOFF THROUGH THE CONSTRUCTION SITE.
- 4.) PLACE INLET PROTECTION ON PROPOSED DRAINAGE INLETS AS SOON AS THEY ARE CONSTRUCTED.
- 5.) STABILIZE ALL FINISH GRADED AREAS.
- 6.) REMOVE ALL TEMPORARY ESC MEASURES.

## PROJECT DESCRIPTION

THIS PROJECT CONSISTS OF THE DESIGN OF A SHARED USE TRAIL WITHIN W&OD REGIONAL PARK. THE PROPOSED TRAIL INCLUDES A BRIDGE OVER WIEHLE AVENUE AS WELL AS SIDEWALK, CURB AND GUTTER, AND CURB RAMPS ALONG WIEHLE AVENUE.

## EXISTING SITE CONDITION

RUNOFF IS CONVEYED THROUGH EXISTING OPEN AND CLOSED SYSTEMS.

## ADJACENT AREAS

THE SITE IS ADJACENT TO COMMERCIAL AREAS AND ROADWAY.

## CRITICAL AREAS

THE PROJECT CONTAINS STEEP SLOPES ADJACENT TO THE TRAILS THAT CAN LEAD TO EROSION PROBLEMS AS EXISTING VEGETATION IS CLEARED. ALL SLOPES 2:1 OR GREATER SHALL BE SODDED AND STAKED OR OTHERWISE STABILIZED IN A MANNER APPROVED BY THE ENGINEER.

## SOILS

THE SITE CONSISTS PRIMARILY OF "URBAN" (PREVIOUSLY DISTURBED) SOILS. PERMISSIBLE VELOCITY IS 5.0 FPS.

## EROSION AND SEDIMENT CONTROL MEASURES

ESC REQUIREMENTS WILL BE SATISFIED BY COMBINATIONS OF INLET PROTECTION, ROCK CHECK DAMS, AND SILT FENCE.

## PERMANENT STABILIZATION

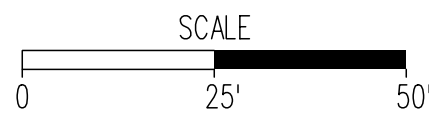
THE SITE SHALL BE STABILIZED IN ACCORDANCE TO THE MINIMUM STANDARD 3 (MS-19). SEEDING AND MULCHING SPECIFICATIONS SHALL COMPLY WITH THE VIRGINIA EROSION AND SEDIMENT CONTROL HANDBOOK, THIRD EDITION 1992.

## STORMWATER RUNOFF CONSIDERATION

THE PROJECT RUNOFF OUTFALLS INTO 2 LOCATIONS AND STORMWATER MANAGEMENT COMPUTATIONS ARE SHOWN IN THE SWM REPORT.



THESE PLANS ARE UNFINISHED AND UNAPPROVED AND ARE NOT TO BE USED FOR ANY TYPE OF CONSTRUCTION.



EMERGENCY POLICE - FIRE - RESCUE 911			
FAIRFAX COUNTY, VIRGINIA			
DEPARTMENT OF PUBLIC WORKS AND ENVIRONMENTAL SERVICES			
12000 GOVERNMENT CENTER PARKWAY, SUITE 449 FAIRFAX, VA., 22035-0052			
OFFICE OF CAPITAL FACILITIES		703-324-5800	
WIEHLE AVENUE (RTE 828)		AT W&OD TRAIL	
EROSION & SEDIMENT CONTROL PLAN		PROJECT NO: 1400102-2013	
SCALE	DESIGNED: NDD	SHEET	
1"=25'	DRAFTED: WRA	3B	
CHECKED: RBH			
APPROVED BY THE TRANSPORTATION DESIGN DIVISION			

FUND # 500-C5000



PROJECT MANAGER: SCOTT RUEFFNER, P.E. (703) 871-5736  
SURVEYED BY: DATE: FAIRFAX COUNTY, NOVEMBER 28, 2014  
DESIGN BY: WHITMAN, REQUARDT & ASSOCIATES, LLP (703) 293-9717  
SUBSURFACE UTILITY BY: DATE: SO DEEP, INC. (703) 361-6005 DECEMBER 23, 2014

TRAVERSE POINT LOCATION TABLE			
POINT #	NORTHING	EASTING	ELEVATION
82	7031210.984	11813922.254	381.66
83	7031259.058	11814128.026	382.32
84	7031125.040	11814157.369	377.57

Sta. 115+57.68 W&OD TRAIL @  
Sta. 403+84.62 WIEHLE AVE. @  
= 89° 40' 36"

Proposed Grading Agreement and  
Temporary Construction Easement

Match Line Sta. 112+00 See Sheet 3

Match Line Sta. 118+75 See Sheet 5

Curve WIEHLE-1  
PI = 403+89.81  
DELTA = 8° 35' 10.7" (LT)  
D = 1" 29' 0.3"  
T = 289.81'  
L = 578.53'  
R = 3,860.50'  
PC = 401+00.00  
PT = 406+78.53

#### LEGEND

- Proposed Pavement Overlay
- Proposed Full Depth Pavement
- Proposed Demolition of Pavement
- Denotes Construction Limits In Cuts
- Denotes Construction Limits In Fills
- Denotes Proposed Graded "A" Ditch

- ST'D CG-6 REQUIRED
- ST'D RADIAL CG-6 REQUIRED
- 10' WIDE CONCRETE SIDEWALK
- 10' WIDE ASPHALT TRAIL
- 12' WIDE ASPHALT TRAIL
- ST'D CG-12 TYPE B MODIFIED REQUIRED
- ST'D CG-12 TYPE C REQUIRED
- TIE INTO EXISTING CURB & GUTTER
- FULL DEPTH SAWCUT
- ST'D MS-2 REQUIRED
- RELOCATE EXISTING UTILITY BY OTHERS
- ST'D VDOT UD-4
- ST'D VDOT CG-2
- REMOVE EXISTING CURB, CURB RAMP OR SIDEWALK
- 8' PEDESTRIAN FENCE
- RELOCATE EXISTING UTILITY
- REMOVE DRAINAGE STRUCTURE

#### NOTES:

- GRADE AROUND TRAIL TO ENSURE POSITIVE DRAINAGE (2" MAX, 3" IF PREFERRED).
- IT IS THE CONTRACTOR'S RESPONSIBILITY TO PROTECT FROM HARM OR REPLACE UNDER LICENSED LAND SURVEYOR ALL PROPERTY MONUMENTATION DISTURBED BY CONSTRUCTION.
- THE CONTRACTOR SHALL MAINTAIN 8 PARKING SPACES, AT ALL TIMES, ALONG THE SOUTH SIDE OF PARCEL #0174-15-05-003A (PIZZA HUT). THE CONTRACTOR MAY SHIFT THE AVAILABLE PARKING SPACES TO MEET THE NEEDS OF DAILY WORK OPERATIONS. THE PARKING SPACES AVAILABLE FOR PUBLIC USE SHALL CONSIST OF A COMPACTED ASPHALT SURFACE AND LINE MARKINGS SEPARATING THE PARKING SPACES. ACCESS TO THE PIZZA HUT ENTRANCE SHALL BE MAINTAINED AT ALL TIMES DURING BUSINESS HOURS. PLEASE REFERENCE THE TRANSPORTATION MANAGEMENT PLAN FOR EXCEPTIONS TO THE PARKING REQUIREMENT DURING BRIDGE ASSEMBLY.

REFERENCES  
(PROFILES, DETAIL & DRAINAGE DESCRIPTION SHEETS, ETC.)  
Curb Ramp Details 2D(1)-2D(2)  
Drainage Desc. 2H(1)-2H(2)  
W&OD Trail Profile 4A(1)  
Wiehle Ave Profile 4A(2)  
Erosion & Sediment Control Plan 4B  
Utility Plan 9(2)

EMERGENCY POLICE - FIRE - RESCUE 911

FAIRFAX COUNTY, VIRGINIA  
DEPARTMENT OF PUBLIC WORKS AND ENVIRONMENTAL SERVICES  
12000 GOVERNMENT CENTER PARKWAY, SUITE 449 FAIRFAX, VA., 22035-0052

OFFICE OF CAPITAL FACILITIES  
703-324-5800

WIEHLE AVENUE (RTE 828)  
AT W&OD TRAIL  
PLAN SHEET

PROJECT NO: 1400102-2013

SCALE 1"=25'  
DESIGNED: NDD  
DRAFTED: WRA  
CHECKED: RBH

SHEET  
4

FUND # 500-C5000



Whitman, Requardt & Associates, LLP

THESE PLANS ARE UNFINISHED  
AND UNAPPROVED AND ARE NOT  
TO BE USED FOR ANY TYPE  
OF CONSTRUCTION.

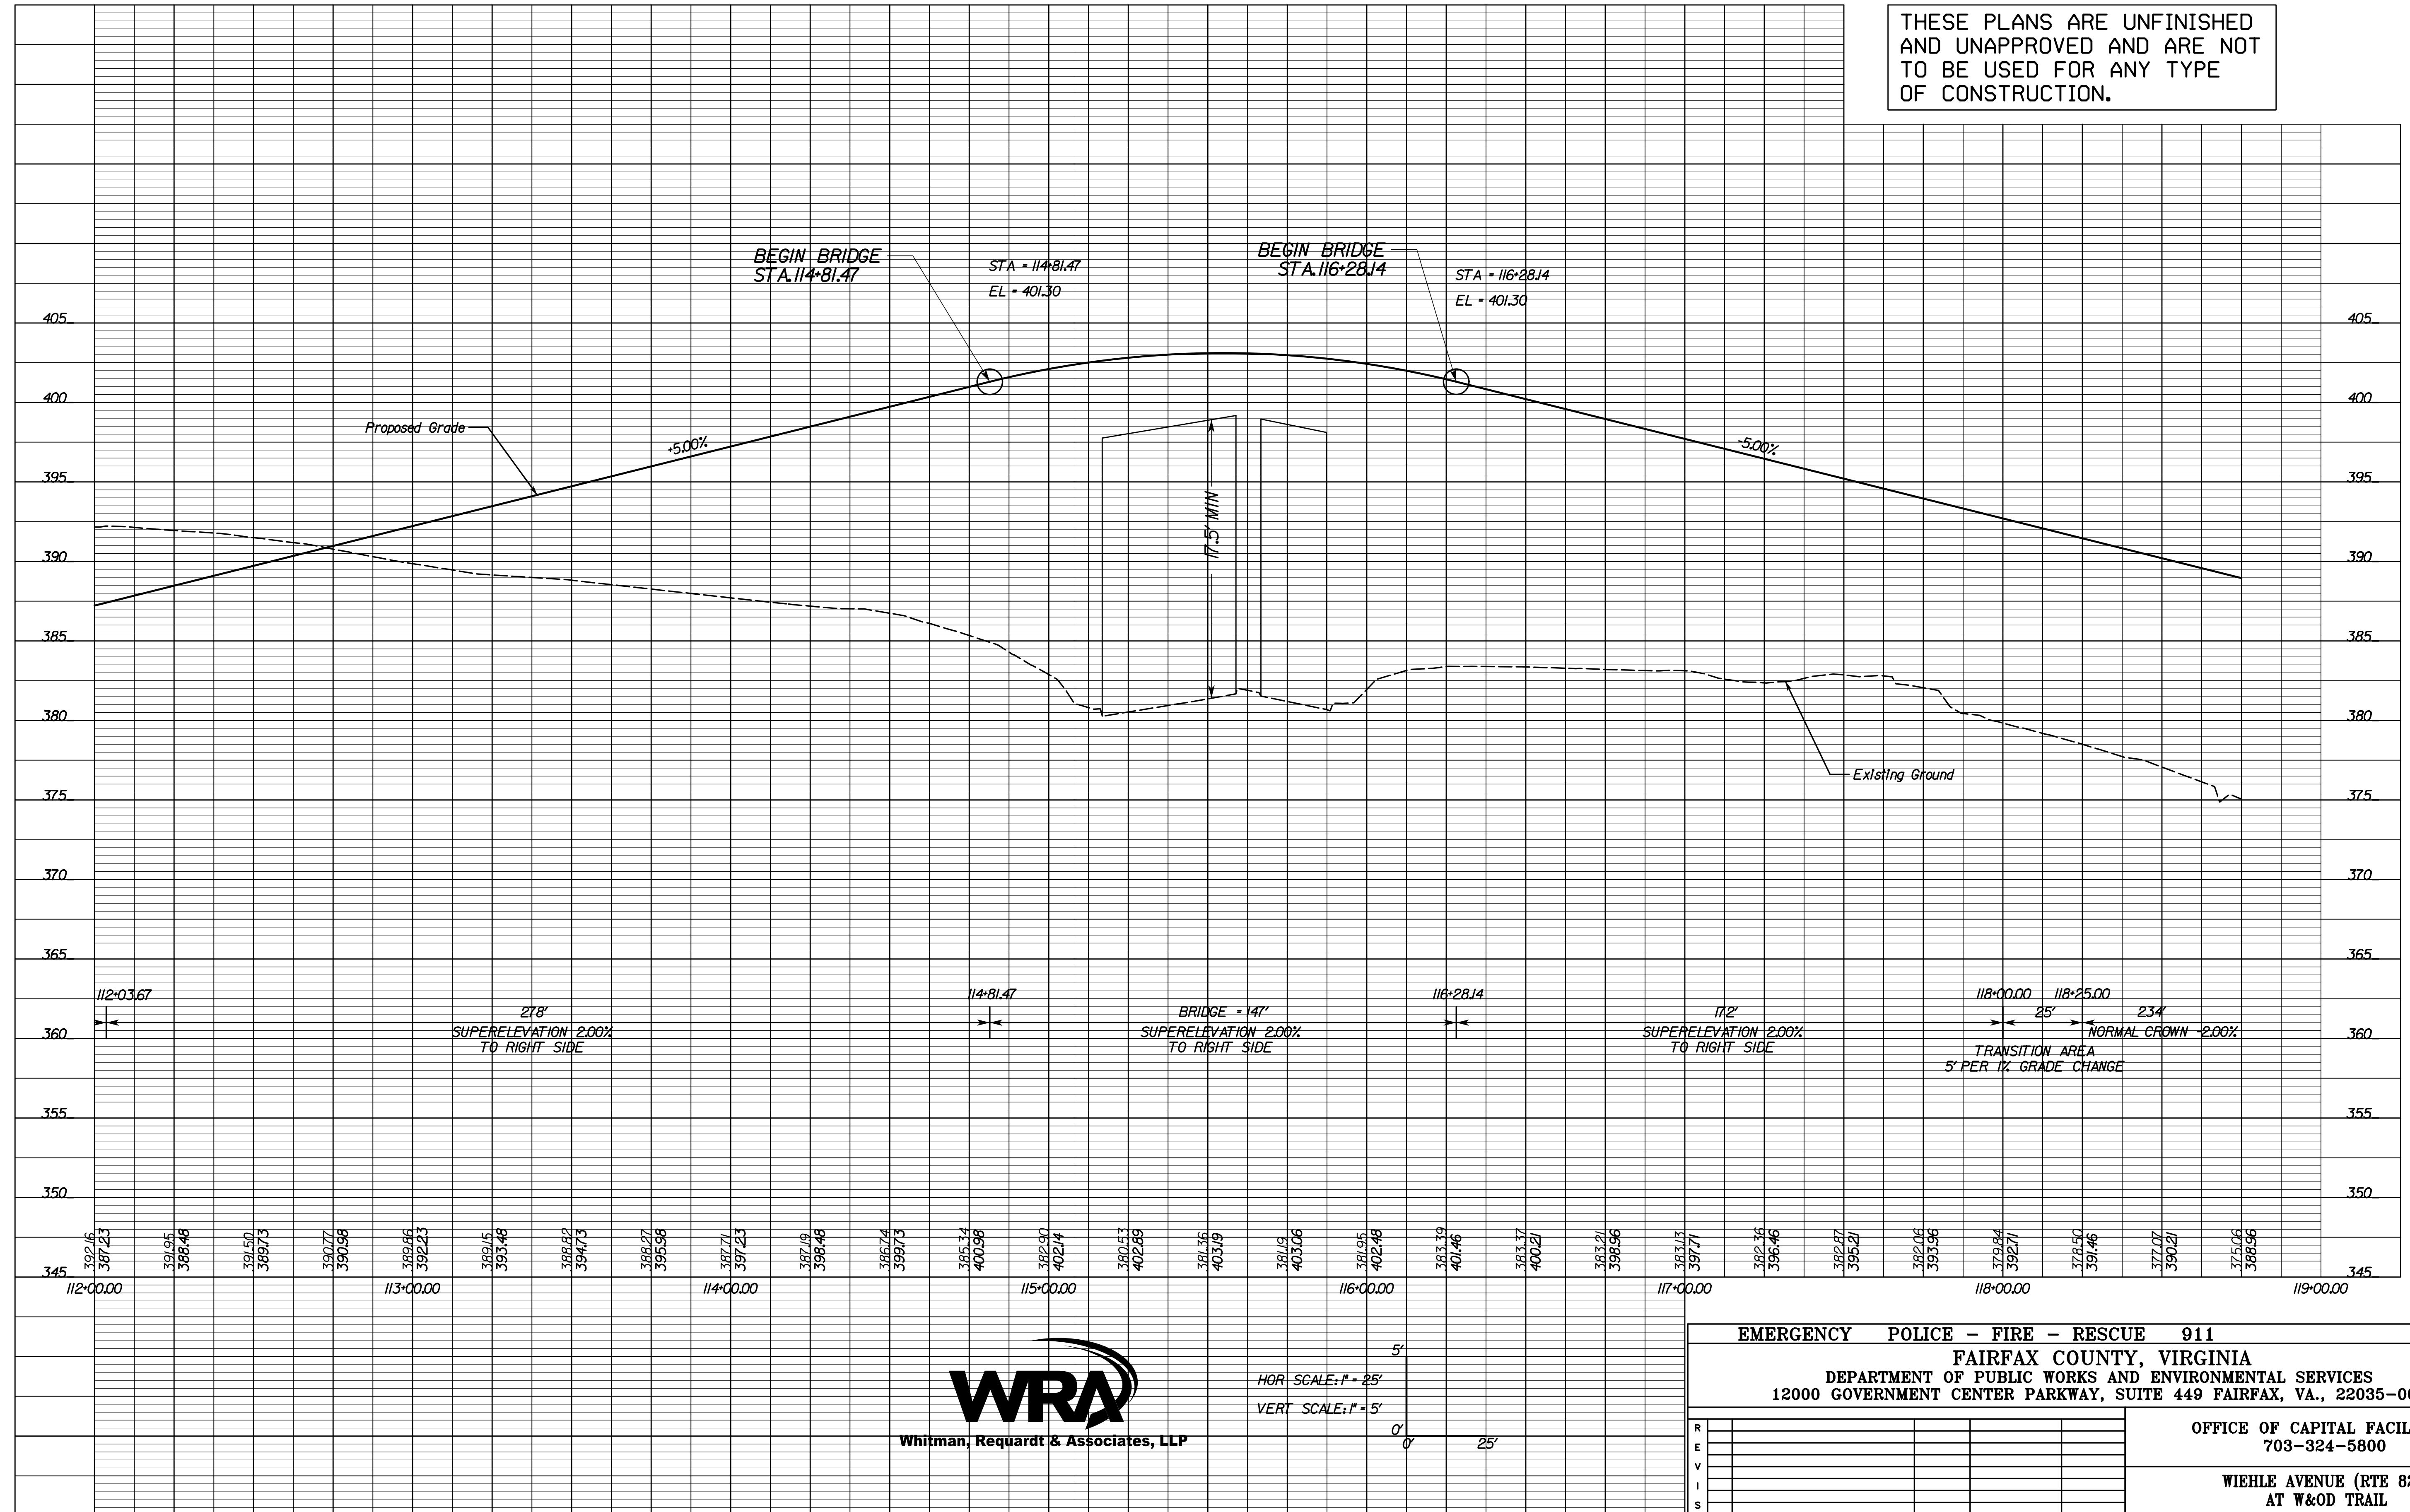
SCALE  
0 25' 50'



PROJECT MANAGER: SCOTT RUFFNER, P.E. (703) 877-5736  
SURVEYED BY, DATE: FAIRFAX COUNTY, NOVEMBER 28, 2014  
DESIGN BY: WHITMAN, REQUARDT & ASSOCIATES, LLP (703) 293-9072  
SUBSURFACE UTILITY BY, DATE: SQ DEEP, INC. (703) 361-6002, DECEMBER 23, 2014

# W&OD TRAIL CONSTRUCTION BASELINE

THESE PLANS ARE UNFINISHED  
AND UNAPPROVED AND ARE NOT  
TO BE USED FOR ANY TYPE  
OF CONSTRUCTION.






PROJECT MANAGER: SCOTT RUFFNER, P.E. (703) 877-5736  
SURVEYED BY, DATE: FAIRFAX COUNTY, NOVEMBER 28, 2014  
DESIGN BY: WHITMAN, REQUARDT & ASSOCIATES, LLP (703) 293-9072  
SUBSURFACE UTILITY BY, DATE: SQ DEEP, INC. (703) 361-6002, DECEMBER 23, 2014

WIEHLE AVE (RTE 828)  
CONSTRUCTION BASELINE

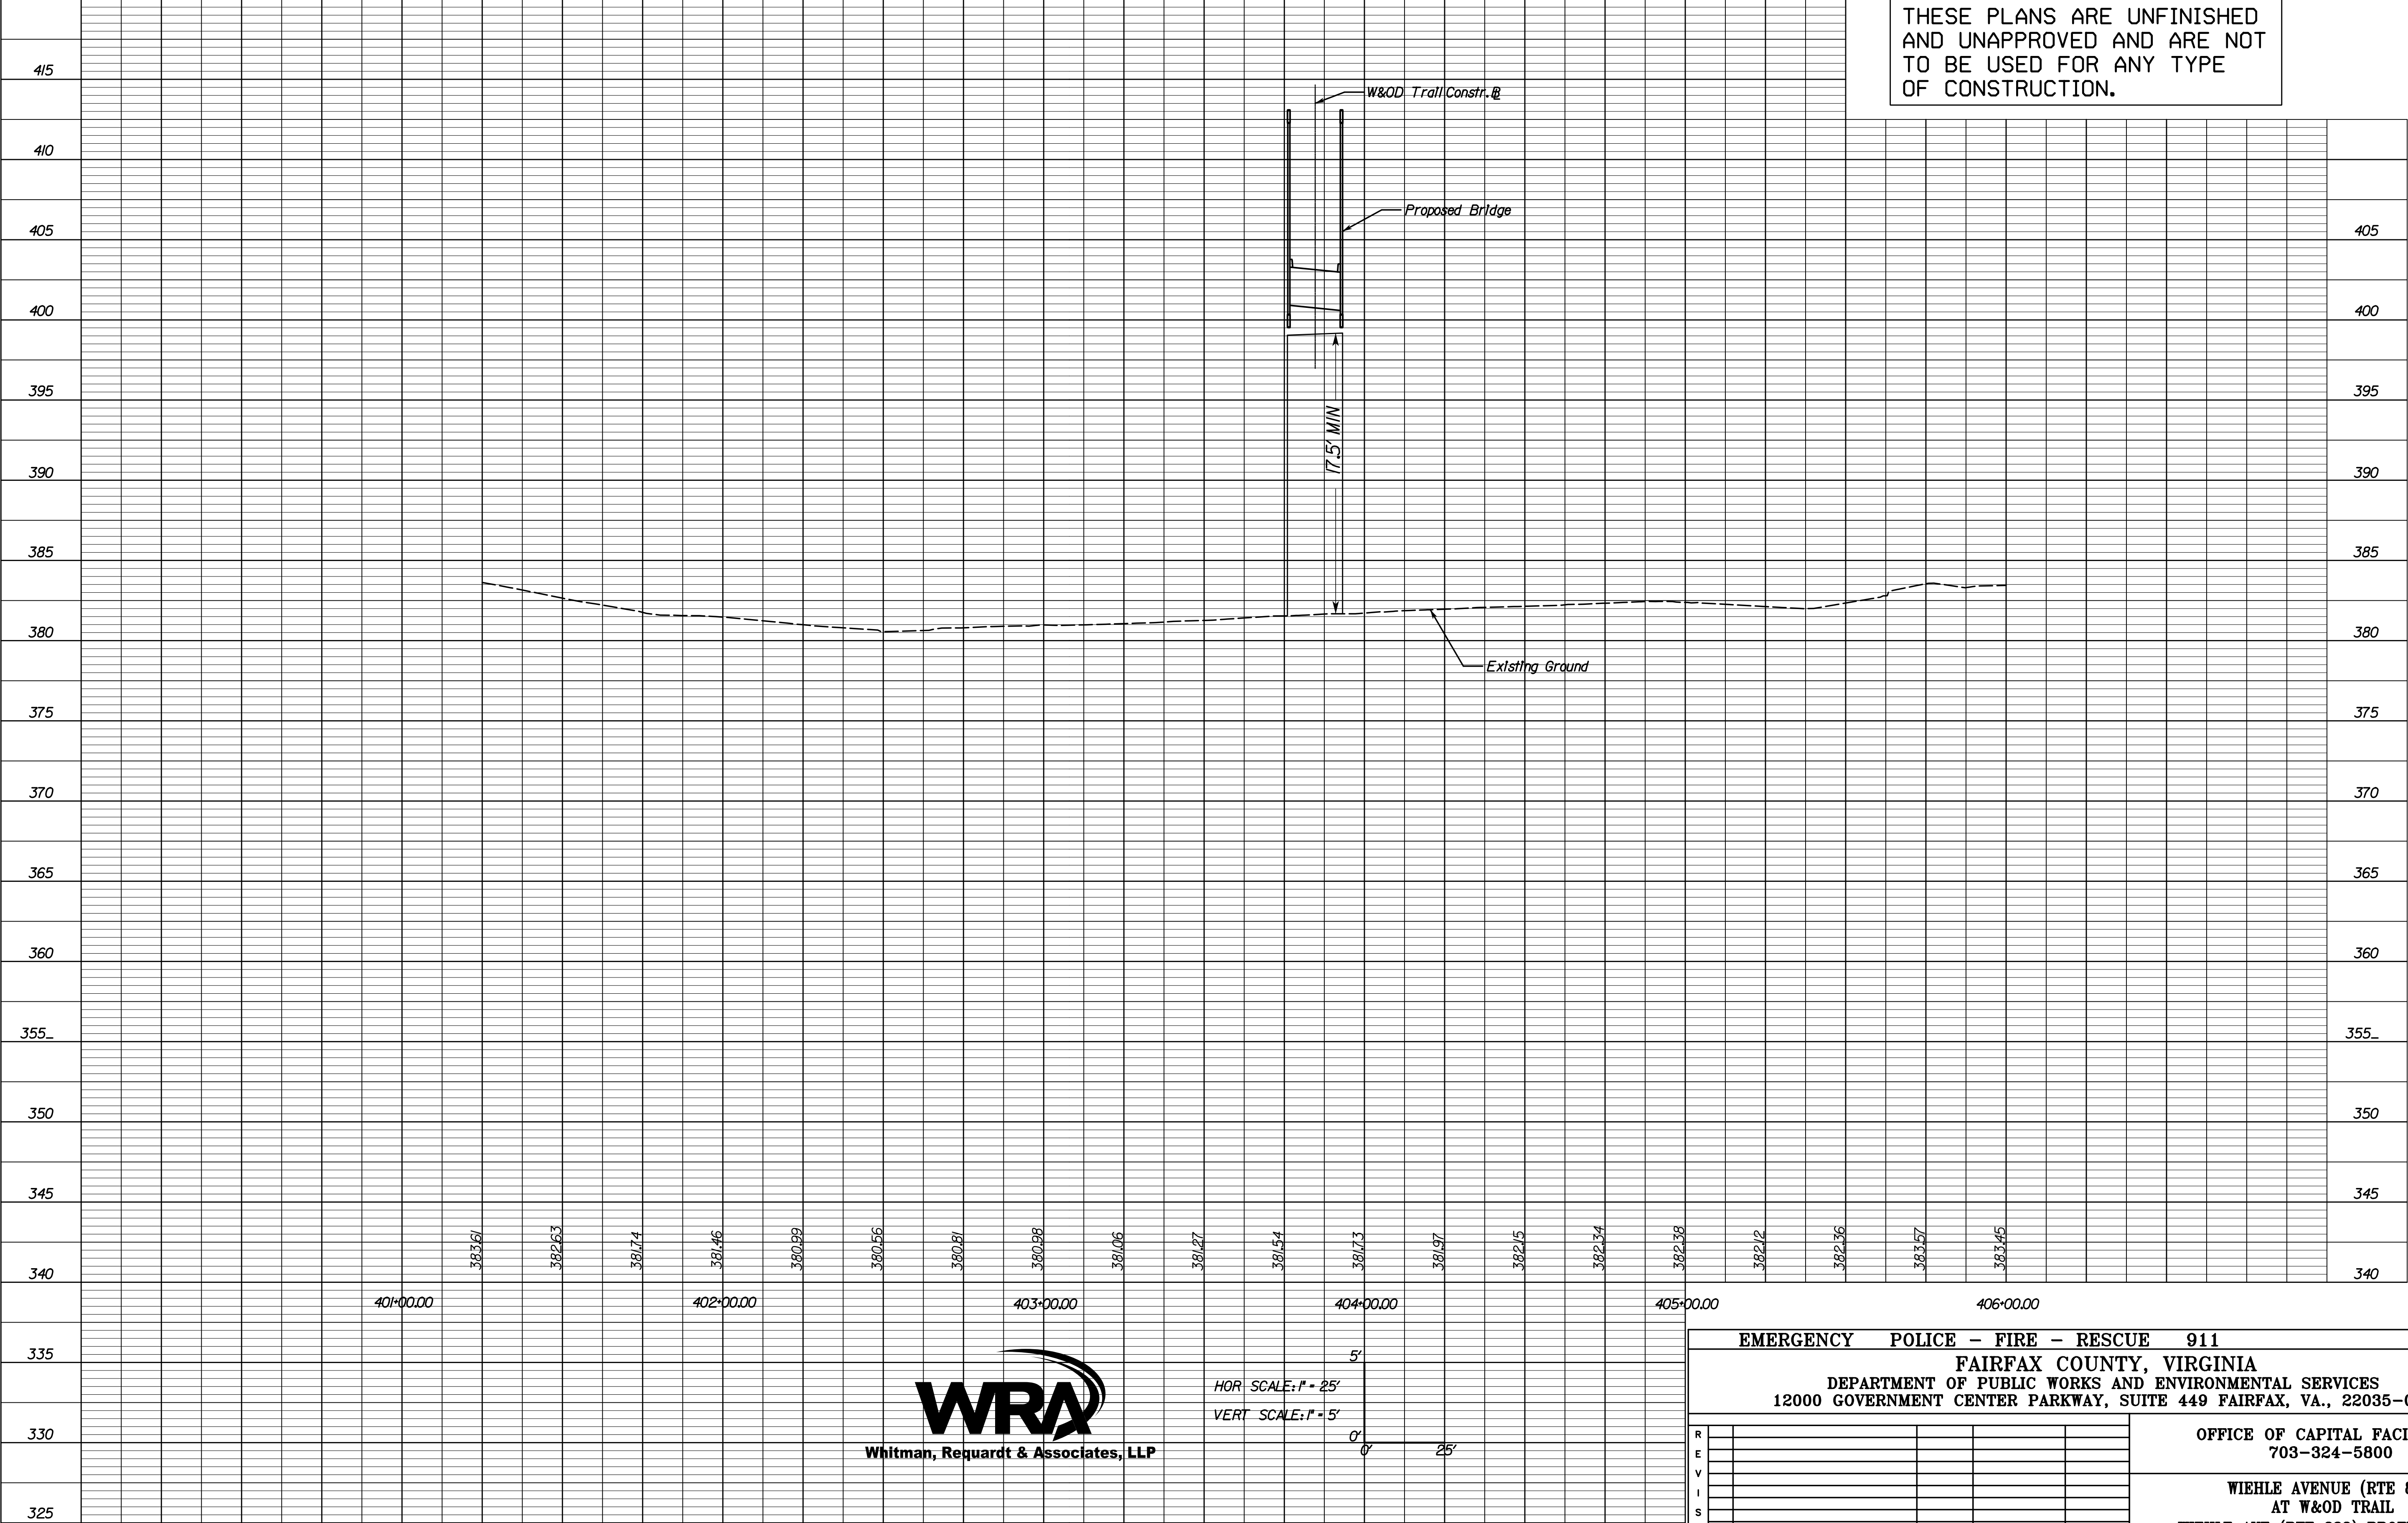THESE PLANS ARE UNFINISHED  
AND UNAPPROVED AND ARE NOT  
TO BE USED FOR ANY TYPE  
OF CONSTRUCTION.



HOR SCALE: 1" = 25'  
VERT SCALE: 1" = 5'

EMERGENCY POLICE - FIRE - RESCUE 911			
FAIRFAX COUNTY, VIRGINIA			
DEPARTMENT OF PUBLIC WORKS AND ENVIRONMENTAL SERVICES			
12000 GOVERNMENT CENTER PARKWAY, SUITE 449 FAIRFAX, VA., 22035-0052			
OFFICE OF CAPITAL FACILITIES 703-324-5800			
WIEHLE AVENUE (RTE 828) AT W&OD TRAIL WIEHLE AVE (RTE 828) PROFILE SHEET PROJECT NO: 1400102-2013			
SCALE AS SHOWN	DESIGNED: NDD DRAFTED: WRA CHECKED: RBH	SHEET 4A(2)	
FUND # 500-C5000			




PROJECT MANAGER: SCOTT RUEFFNER, P.E., (703) 871-5736  
SURVEYED BY, DATE: FAIRFAX COUNTY, NOVEMBER 28, 2014  
DESIGN BY: WHITMAN, REQUARDT & ASSOCIATES, LLP, (703) 293-9717  
SUBSURFACE UTILITY BY, DATE: SO DEEP, INC., (703) 361-6005, DECEMBER 23, 2014

# EROSION & SEDIMENT CONTROL PLAN

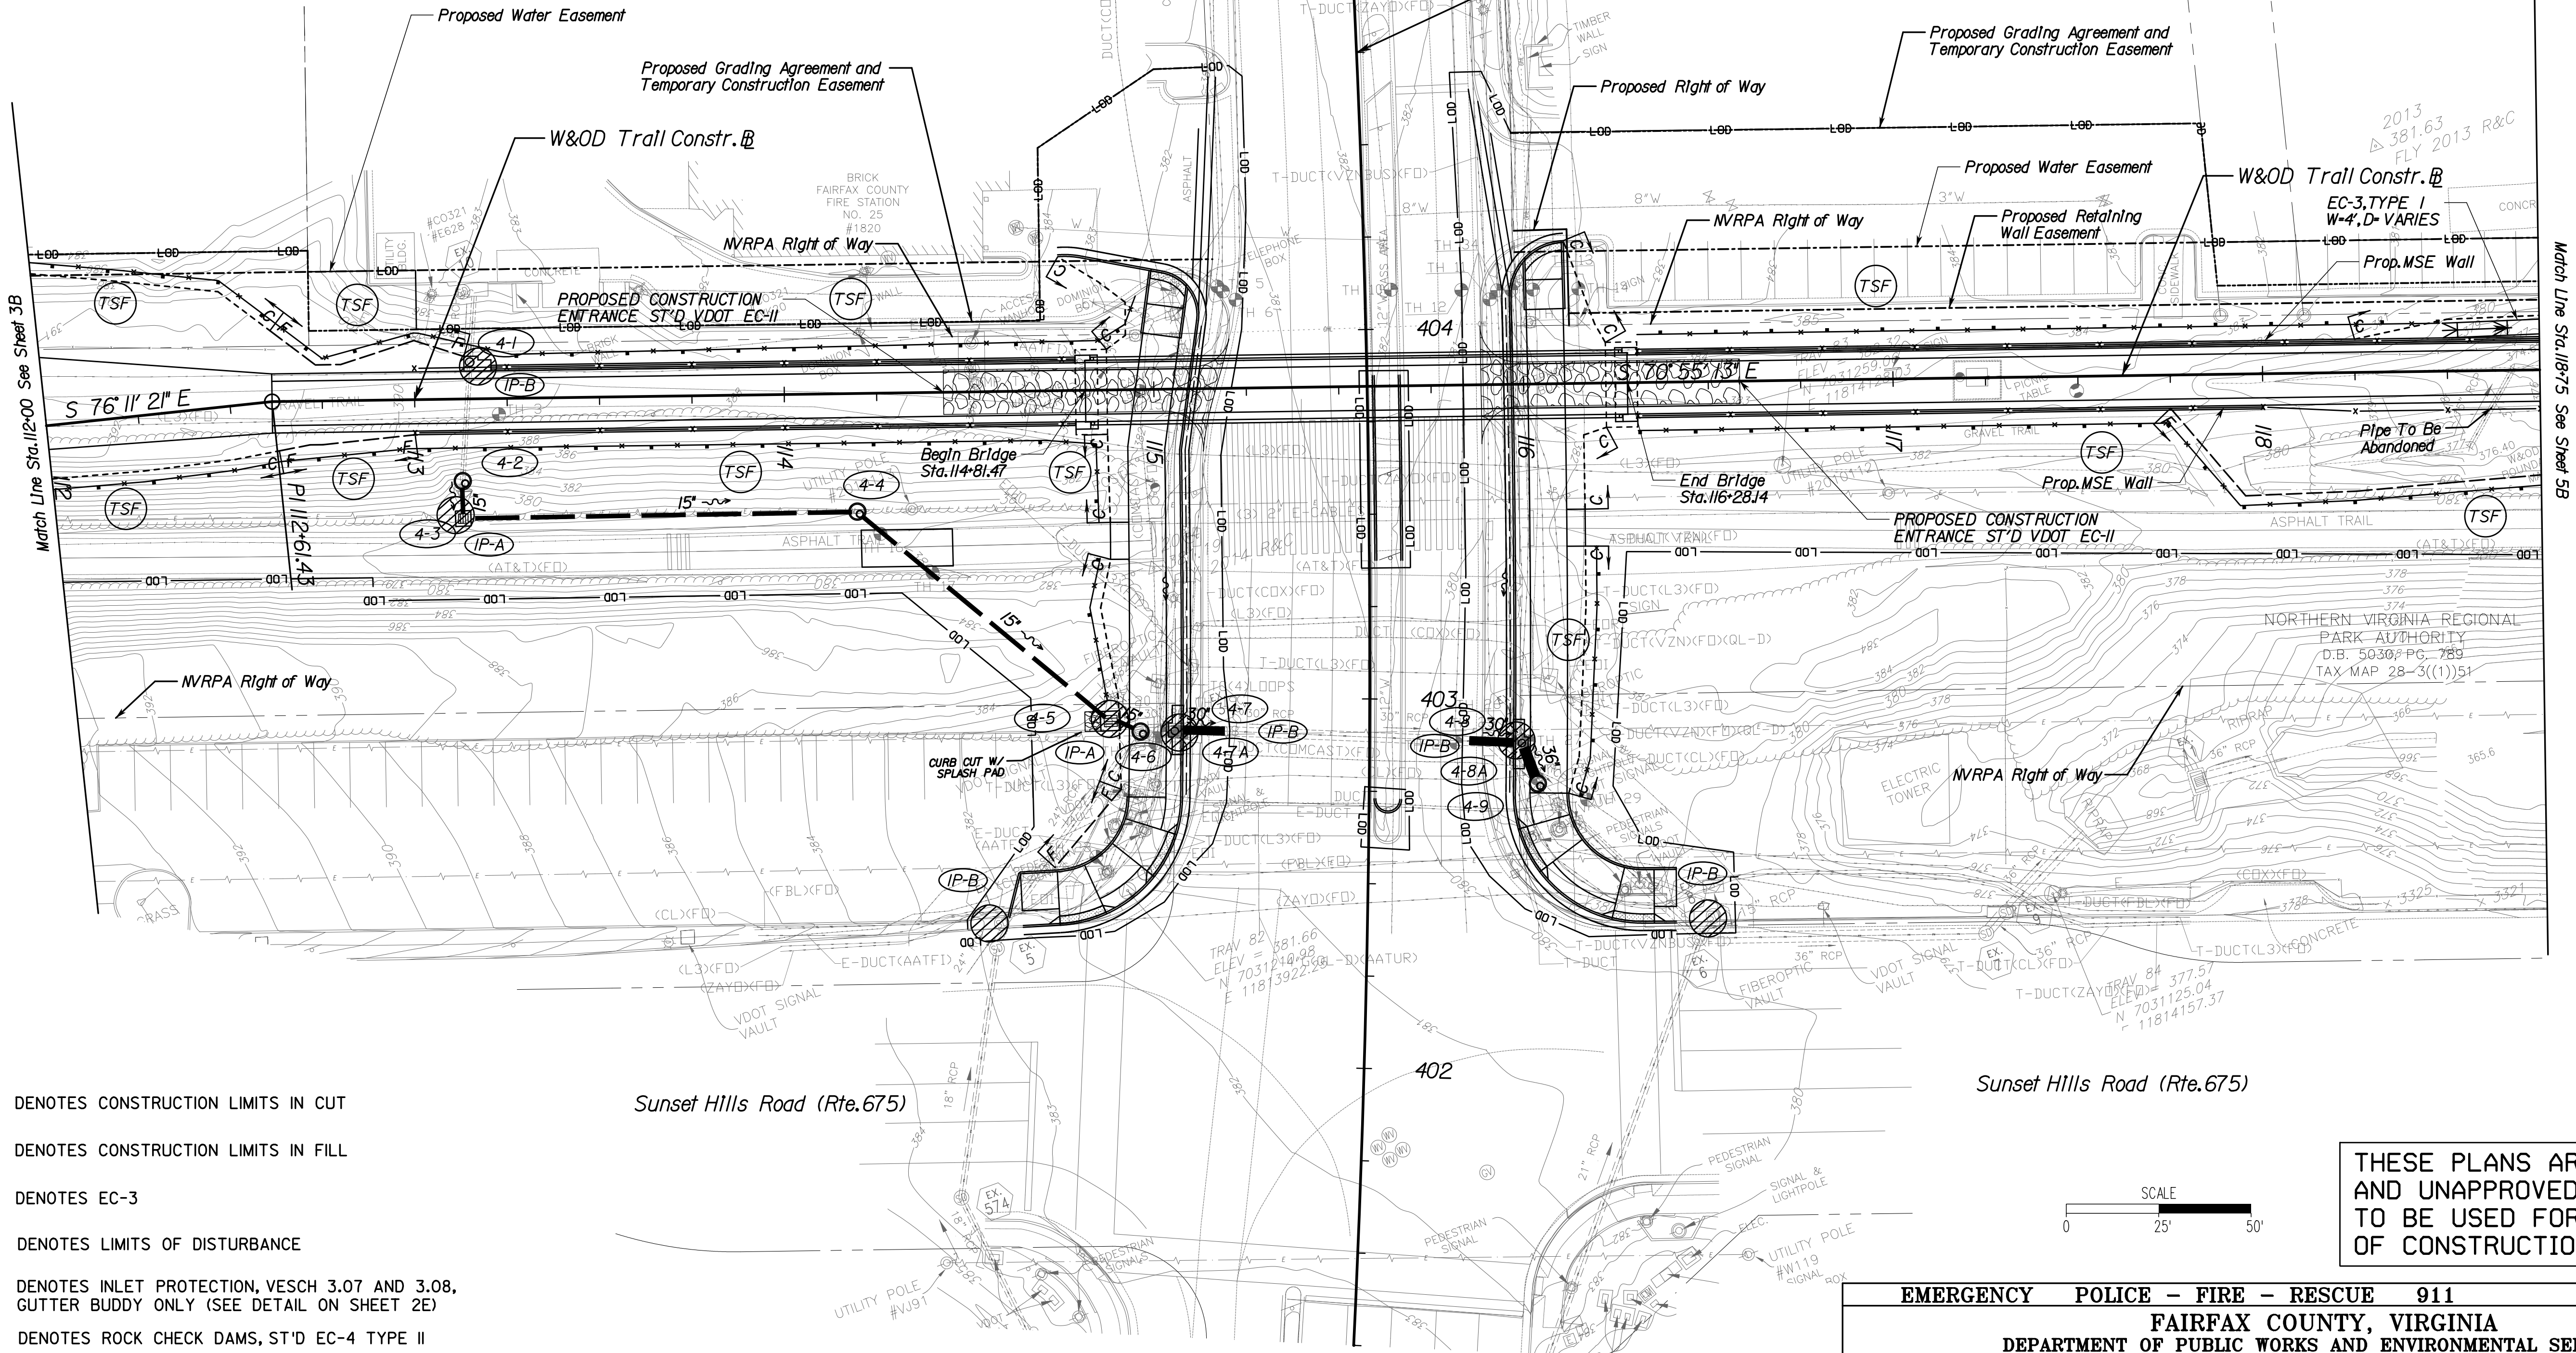THE SEQUENCE OF E&S MEASURES IS GENERALLY AS FOLLOWS:

- 1.) INSTALL PERIMETER ESC MEASURES, INCLUDING SILT FENCE AND ROCK CHECK DAMS.
- 2.) PLACE INLET PROTECTION ON EXISTING STORM DRAIN SYSTEMS.
- 3.) INSTALL TEMPORARY AND PERMANENT PIPES AND CHANNELS USED TO CONVEY OFFSITE RUNOFF THROUGH THE CONSTRUCTION SITE.
- 4.) PLACE INLET PROTECTION ON PROPOSED DRAINAGE INLETS AS SOON AS THEY ARE CONSTRUCTED.
- 5.) STABILIZE ALL FINISH GRADED AREAS.
- 6.) REMOVE ALL TEMPORARY ESC MEASURES.



## LEGEND

- DENOTES CONSTRUCTION LIMITS IN CUT
- DENOTES CONSTRUCTION LIMITS IN FILL
- DENOTES EC-3
- DENOTES LIMITS OF DISTURBANCE
- DENOTES INLET PROTECTION, VESCH 3.07 AND 3.08, GUTTER BUDDY ONLY (SEE DETAIL ON SHEET 2E)
- DENOTES ROCK CHECK DAMS, ST'D EC-4 TYPE II
- DENOTES TEMPORARY SILT FENCE, ST'D EC-5
- DENOTES CULVERT INLET PROTECTION, ST'D EC-6 TYPE C
- DENOTES PROPOSED STAGING AREA OR CONSTRUCTION ENTRANCE ST'D VDOT EC-11

NOTES:  
1.) THIS SHEET IS TO BE USED FOR EROSION AND SEDIMENT CONTROL MEASURES ONLY.

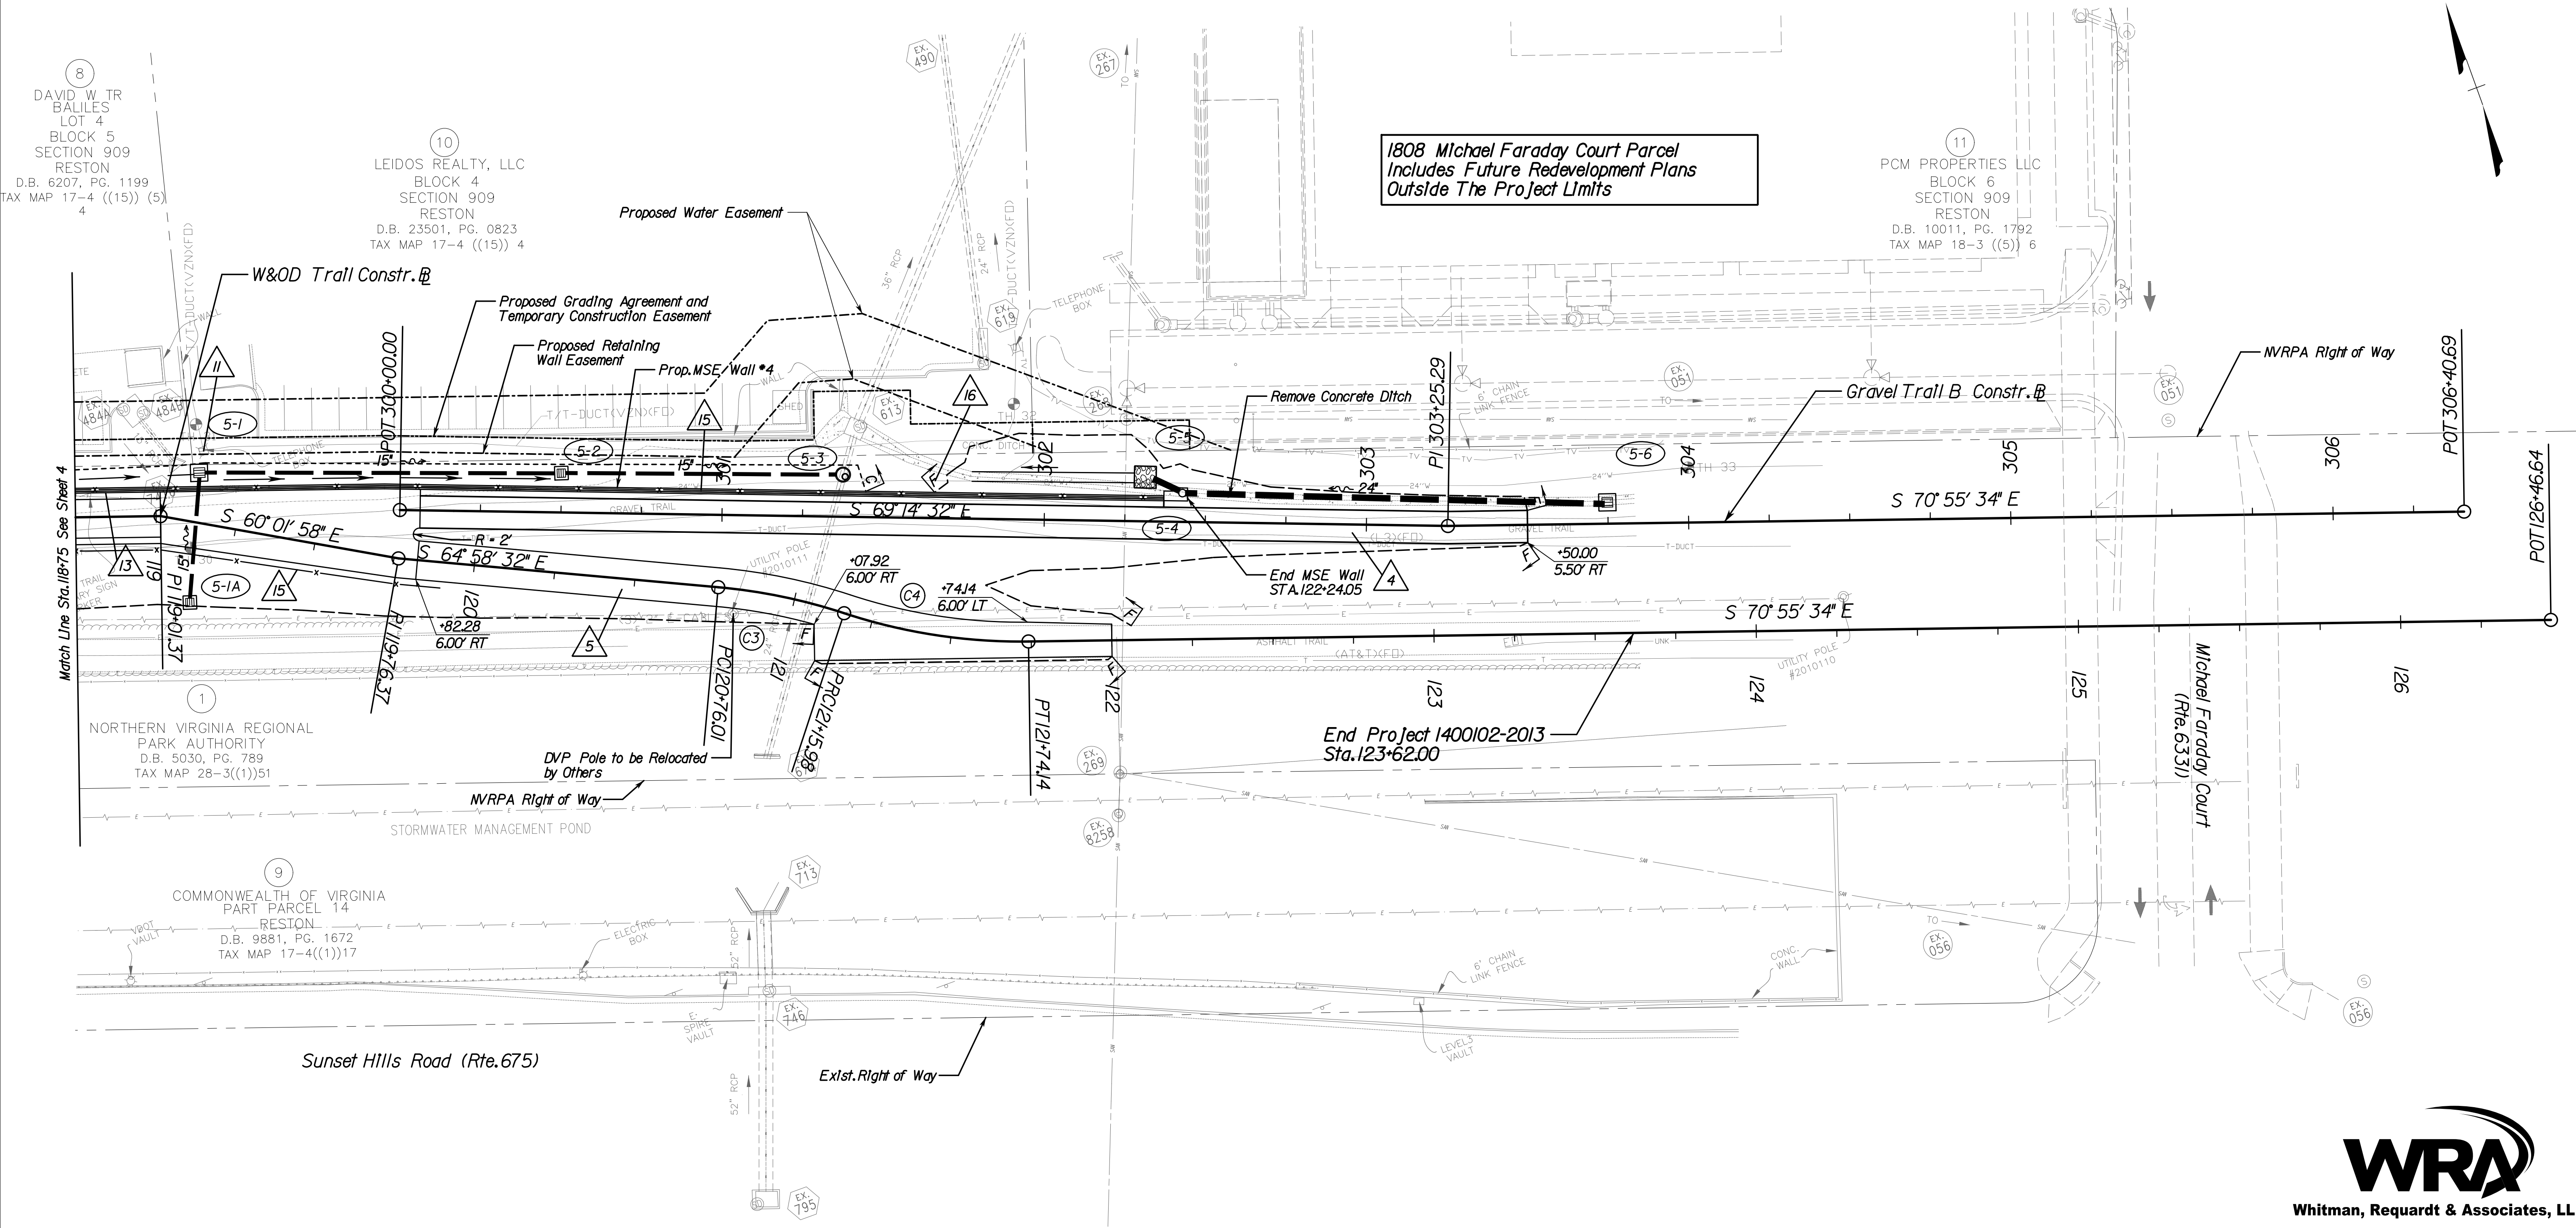


Whitman, Requardt & Associates, LLP

EMERGENCY POLICE - FIRE - RESCUE 911			
FAIRFAX COUNTY, VIRGINIA			
DEPARTMENT OF PUBLIC WORKS AND ENVIRONMENTAL SERVICES			
12000 GOVERNMENT CENTER PARKWAY, SUITE 449 FAIRFAX, VA., 22035-0052			
OFFICE OF CAPITAL FACILITIES		WIEHLE AVENUE (RTE 828)	
703-324-5800		AT W&OD TRAIL	
EROSION & SEDIMENT CONTROL PLAN		PROJECT NO: 1400102-2013	
SCALE 1"=25'		DESIGNED: NDD	SHEET 4B
APPROVED BY THE TRANSPORTATION DESIGN DIVISION		DRAFTED: WRA	CHECKED: RBH
FUND # 500-C5000			




PROJECT MANAGER: SCOTT RUEFFNER, P.E. (703) 871-5736  
SURVEYED BY: DATE: FAIRFAX COUNTY, NOVEMBER 28, 2014  
DESIGN BY: WHITMAN, REQUARDT & ASSOCIATES, LLP (703) 293-9717  
SUBSURFACE UTILITY BY: DATE: SO DEEP, INC. (703) 361-6005 DECEMBER 23, 2014



Whitman, Requardt & Associates, LLP

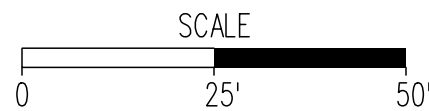THESE PLANS ARE UNFINISHED  
AND UNAPPROVED AND ARE NOT  
TO BE USED FOR ANY TYPE  
OF CONSTRUCTION.



- LEGEND**
- Proposed Pavement Overlay
  - Proposed Full Depth Pavement
  - Proposed Demolition of Pavement
  - Denotes Construction Limits In Cuts
  - Denotes Construction Limits In Fills
  - Denotes Proposed Graded "V" Ditch
  - 1 ST'D CG-6 REQUIRED
  - 2 ST'D RADIAL CG-6 REQUIRED
  - 3 10' WIDE CONCRETE SIDEWALK
  - 4 10' WIDE ASPHALT TRAIL
  - 5 12' WIDE ASPHALT TRAIL
  - 6 ST'D CG-12 TYPE B MODIFIED REQUIRED
  - 7 ST'D CG-12 TYPE C REQUIRED
  - 8 TIE INTO EXISTING CURB & GUTTER
  - 9 FULL DEPTH SAWCUT
  - 10 ST'D MS-2 REQUIRED
  - 11 RELOCATE EXISTING UTILITY BY OTHERS
  - 12 ST'D VDOT UD-4
  - 13 ST'D VDOT CG-2
  - 14 REMOVE EXISTING CURB, CURB RAMP OR SIDEWALK
  - 15 8' PEDESTRIAN FENCE
  - 16 RELOCATE EXISTING UTILITY

- (C3) Curve W&D-3  
PI = 120+96.08  
DELTA = 13° 05' 20.8" (RT)  
D = 32' 44' 26"  
T = 20.08'  
L = 39.98'  
R = 175.00'  
PC = 120+76.01  
PT = 121+5.98
- (C4) Curve W&D-4  
PI = 121+45.33  
DELTA = 19° 02' 22.55" (LT)  
D = 32' 44' 26"  
T = 29.35'  
L = 58.15'  
R = 175.00'  
PC = 121+5.98  
PT = 121+74.4

NOTES:  
1. GRADE AROUND TRAIL TO ENSURE POSITIVE DRAINAGE (2" MAX, 3" IF PREFERRED).  
2. IT IS THE CONTRACTOR'S RESPONSIBILITY TO PROTECT FROM HARM OR REPLACE UNDER LICENSED LAND SURVEYOR ALL PROPERTY MONUMENTATION DISTURBED BY CONSTRUCTION.

REFERENCES (PROFILES, DETAIL & DRAINAGE DESCRIPTION SHEETS, ETC.)	
Drainage Desc.	2H(1)-2H(2)
W&OD Trail Profile	5A(1)
Gravel Trail B Profile	5A(2)
Erosion & Sediment Control Plan	5B
Utility Plan	9(3)

EMERGENCY POLICE - FIRE - RESCUE 911						
FAIRFAX COUNTY, VIRGINIA						
DEPARTMENT OF PUBLIC WORKS AND ENVIRONMENTAL SERVICES						
12000 GOVERNMENT CENTER PARKWAY, SUITE 449 FAIRFAX, VA., 22035-0052						
R E V I S I O N S					OFFICE OF CAPITAL FACILITIES 703-324-5800	
						WIEHLE AVENUE (RTE 828) AT W&OD TRAIL PLAN SHEET
						PROJECT NO: 1400102-2013
						SCALE 1"=25'
						DESIGNED: NDD DRAFTED: WRA CHECKED: RBH
					SHEET 5	
Δ/	DESCRIPTION	BY	APPROVED	DATE	APPROVED BY THE TRANSPORTATION DESIGN DIVISION	




PROJECT MANAGER: SCOTT RUFFNER, P.E. (703) 877-5736  
SURVEYED BY, DATE: FAIRFAX COUNTY, NOVEMBER 28, 2014  
DESIGN BY: WHITMAN, REQUARDT & ASSOCIATES, LLP (703) 293-9072  
SUBSURFACE UTILITY BY, DATE: SQ DEEP, INC. (703) 361-6002, DECEMBER 23, 2014

# W&OD TRAIL
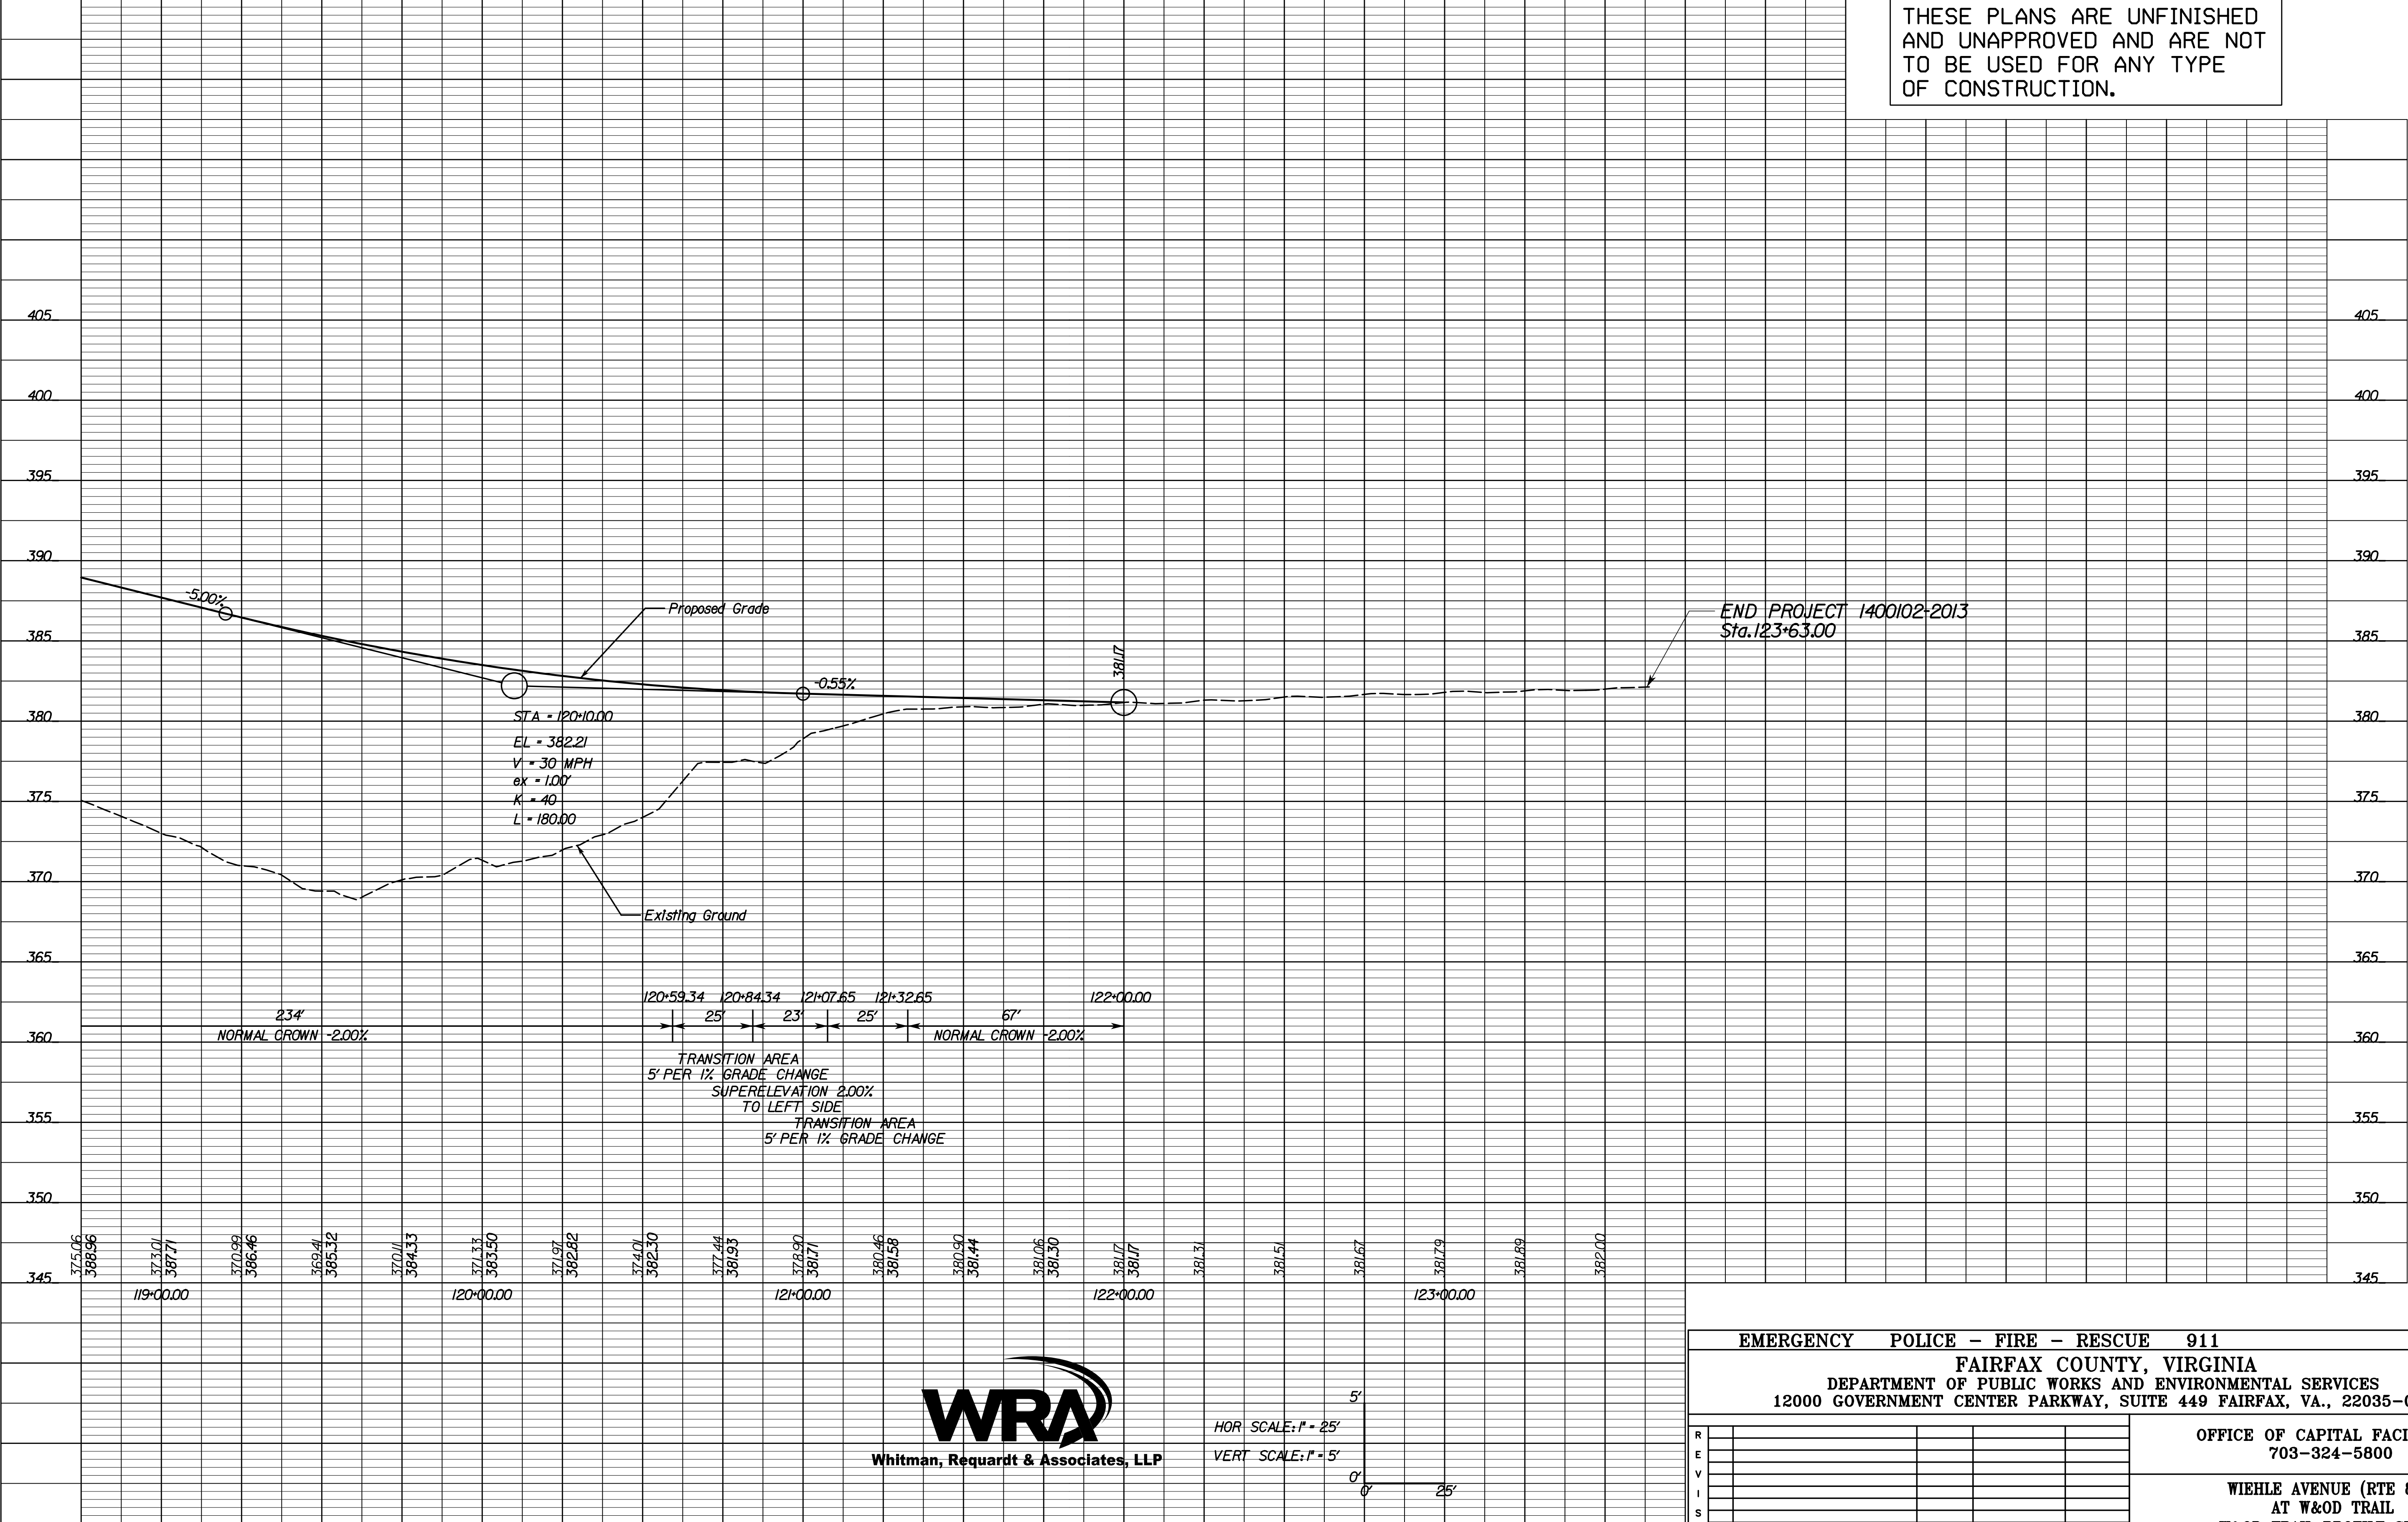
## CONSTRUCTION BASELINE

THESE PLANS ARE UNFINISHED  
AND UNAPPROVED AND ARE NOT  
TO BE USED FOR ANY TYPE  
OF CONSTRUCTION.



HOR SCALE: 1" = 25'  
VERT SCALE: 1" = 5'

EMERGENCY POLICE - FIRE - RESCUE 911			
FAIRFAX COUNTY, VIRGINIA			
DEPARTMENT OF PUBLIC WORKS AND ENVIRONMENTAL SERVICES			
12000 GOVERNMENT CENTER PARKWAY, SUITE 449 FAIRFAX, VA., 22035-0052			
OFFICE OF CAPITAL FACILITIES 703-324-5800			
WIEHLE AVENUE (RTE 828) AT W&OD TRAIL W&OD TRAIL PROFILE SHEET			
PROJECT NO: 1400102-2013			
SCALE AS SHOWN	DESIGNED: NDD DRAFTED: WRA CHECKED: RBH	SHEET 5A(1)	
APPROVED BY THE TRANSPORTATION DESIGN DIVISION			




PROJECT MANAGER: SCOTT RUFFNER, P.E. (703) 877-5736  
SURVEYED BY, DATE: FAIRFAX COUNTY, NOVEMBER 28, 2014  
DESIGN BY: WHITMAN, REQUARDT & ASSOCIATES, LLP (703) 293-9072  
SUBSURFACE UTILITY BY, DATE: SQ DEEP, INC. (703) 361-6002, DECEMBER 23, 2014

# GRAVEL TRAIL B
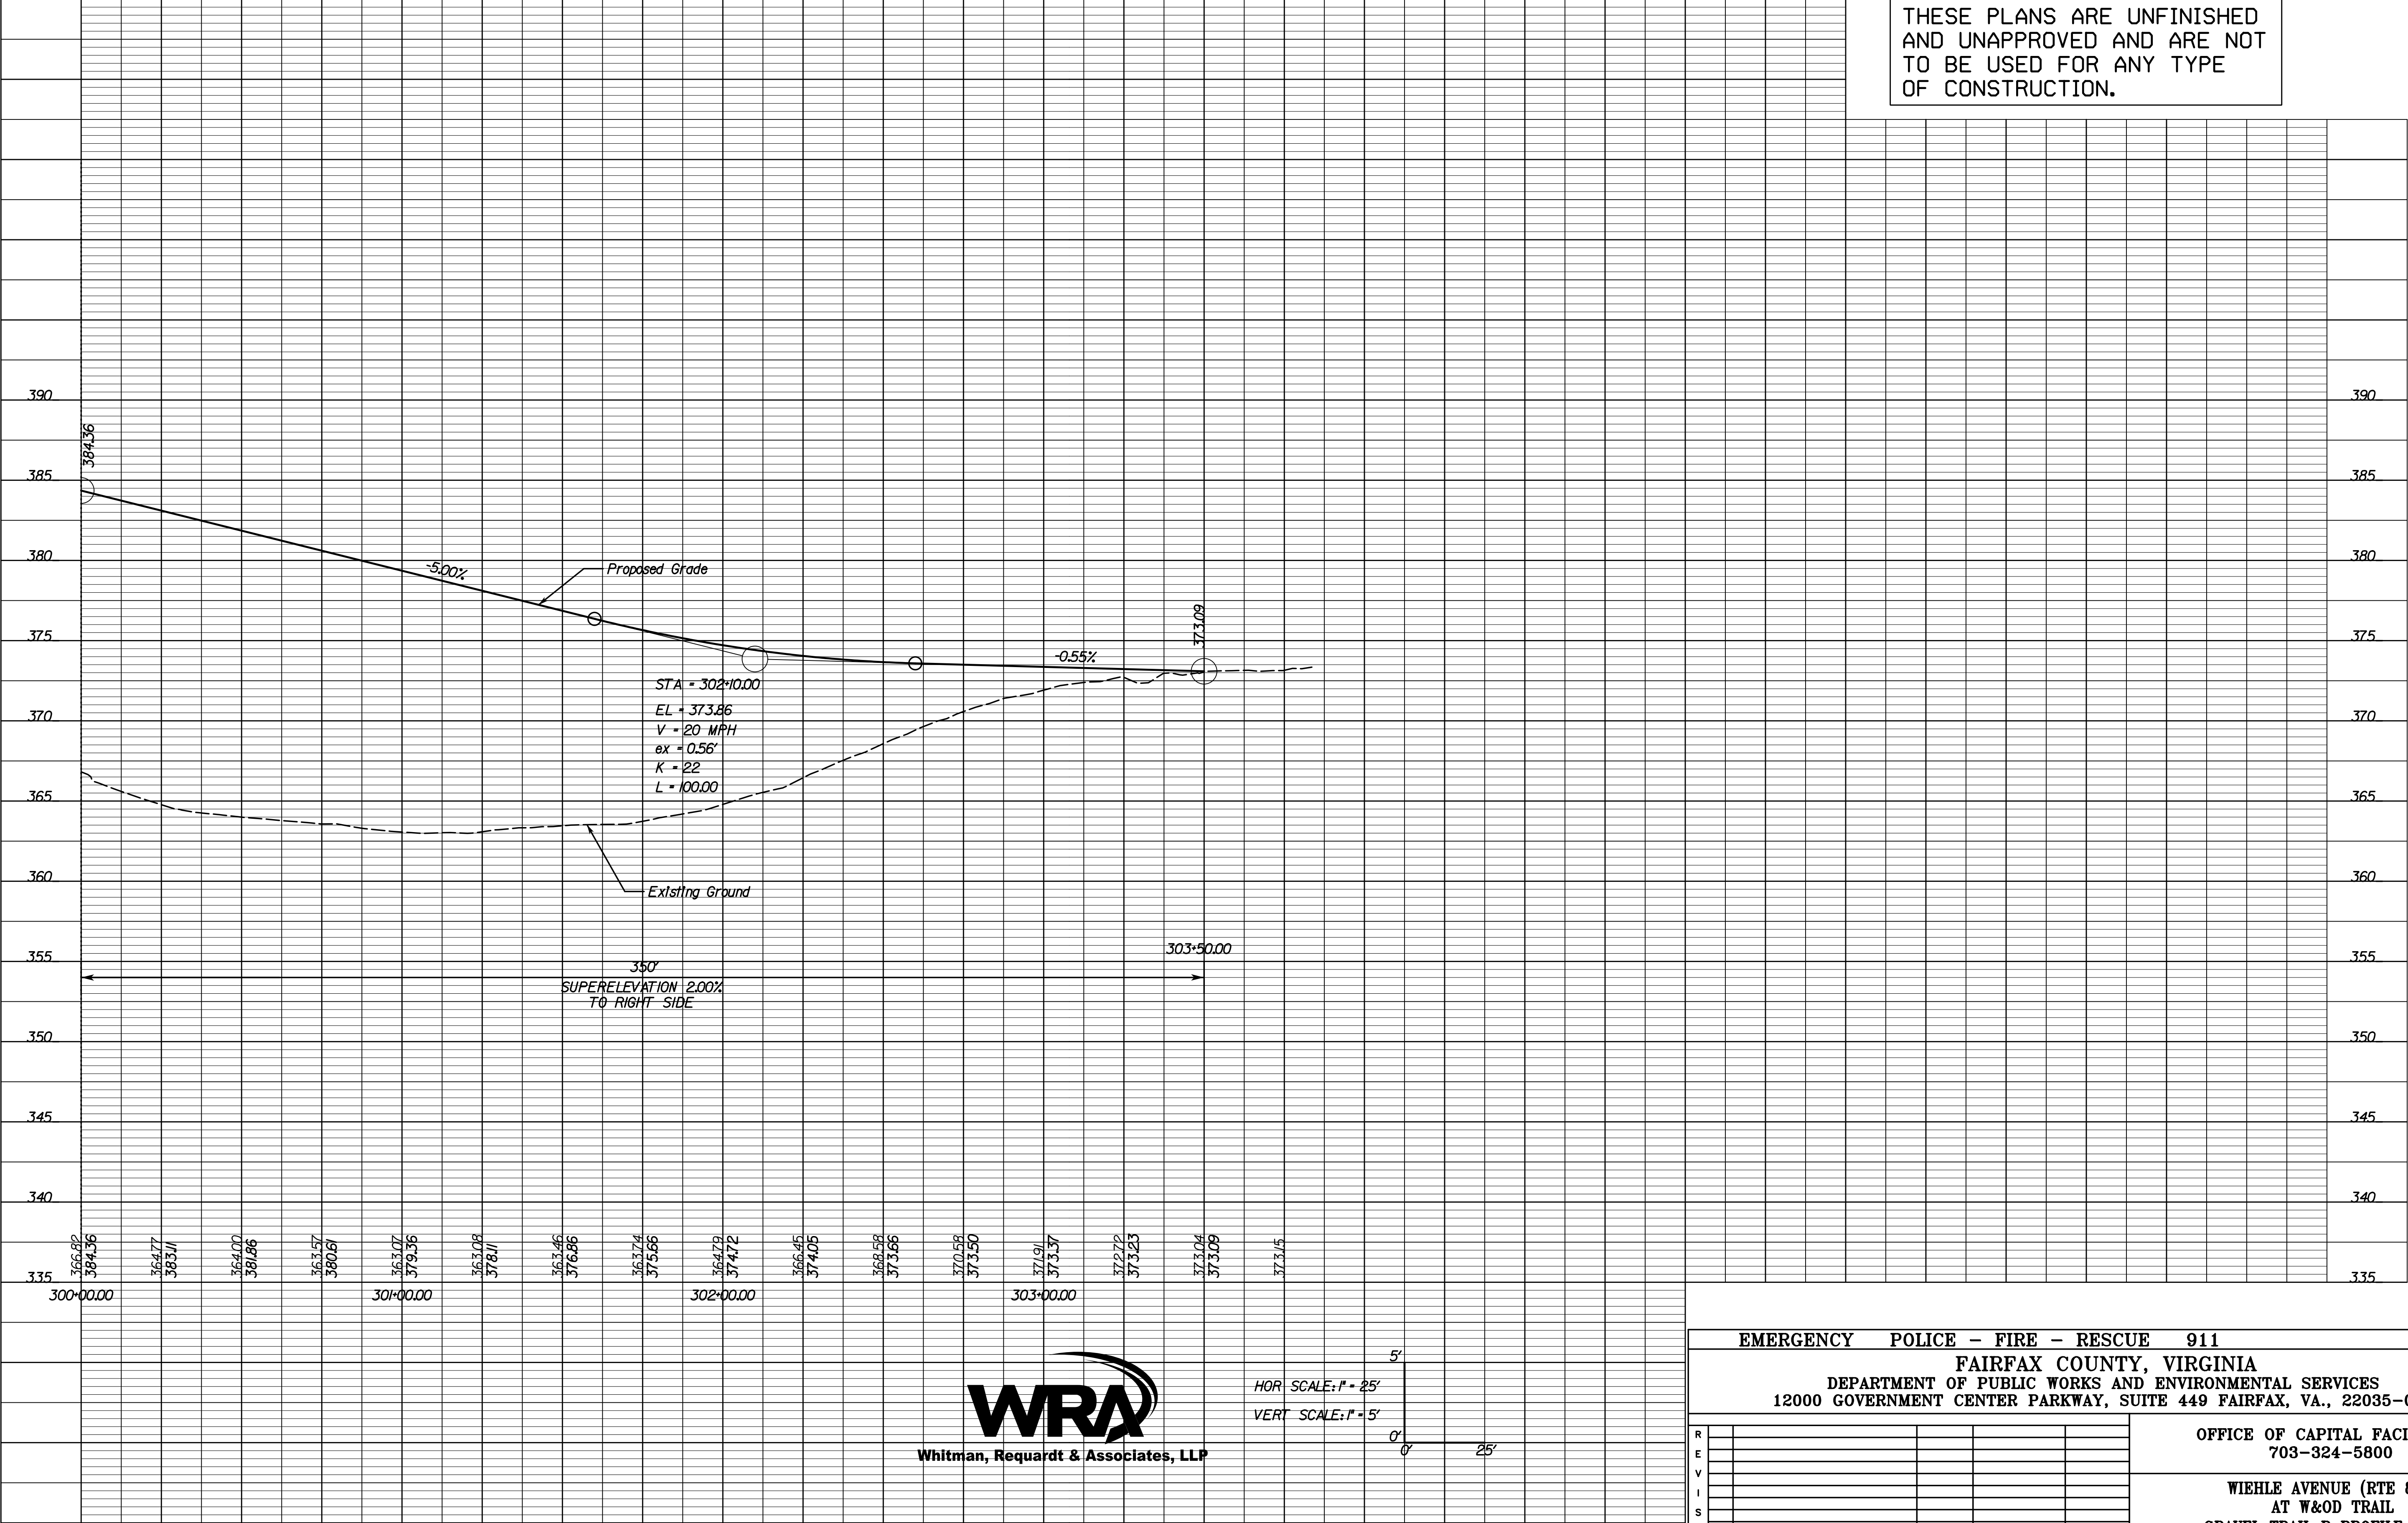
## CONSTRUCTION BASELINE

THESE PLANS ARE UNFINISHED  
AND UNAPPROVED AND ARE NOT  
TO BE USED FOR ANY TYPE  
OF CONSTRUCTION.



Whitman, Requardt & Associates, LLP

HOR SCALE: 1" = 25'

VERT SCALE: 1" = 5'


EMERGENCY POLICE - FIRE - RESCUE 911			
FAIRFAX COUNTY, VIRGINIA			
DEPARTMENT OF PUBLIC WORKS AND ENVIRONMENTAL SERVICES			
12000 GOVERNMENT CENTER PARKWAY, SUITE 449 FAIRFAX, VA., 22035-0052			
OFFICE OF CAPITAL FACILITIES			
703-324-5800			
WIEHLE AVENUE (RTE 828)			
AT W&OD TRAIL			
GRAVEL TRAIL B PROFILE SHEET			
PROJECT NO: 1400102-2013			
SCALE AS SHOWN		DESIGNED: NDD	SHEET 5A(2)
DRAFTED: WRA		CHECKED: RBH	
APPROVED BY THE TRANSPORTATION DESIGN DIVISION			

FUND # 500-C5000



PROJECT MANAGER: SCOTT RUEFFNER, P.E. (703) 871-5736  
SURVEYED BY: DATE: FAIRFAX COUNTY, NOVEMBER 28, 2014  
DESIGN BY: WHITMAN, REQUARDT & ASSOCIATES, LLP (703) 293-9717  
SUBSURFACE UTILITY BY: DATE: SO DEEP, INC. (703) 361-6005 DECEMBER 23, 2014

# EROSION & SEDIMENT CONTROL PLAN

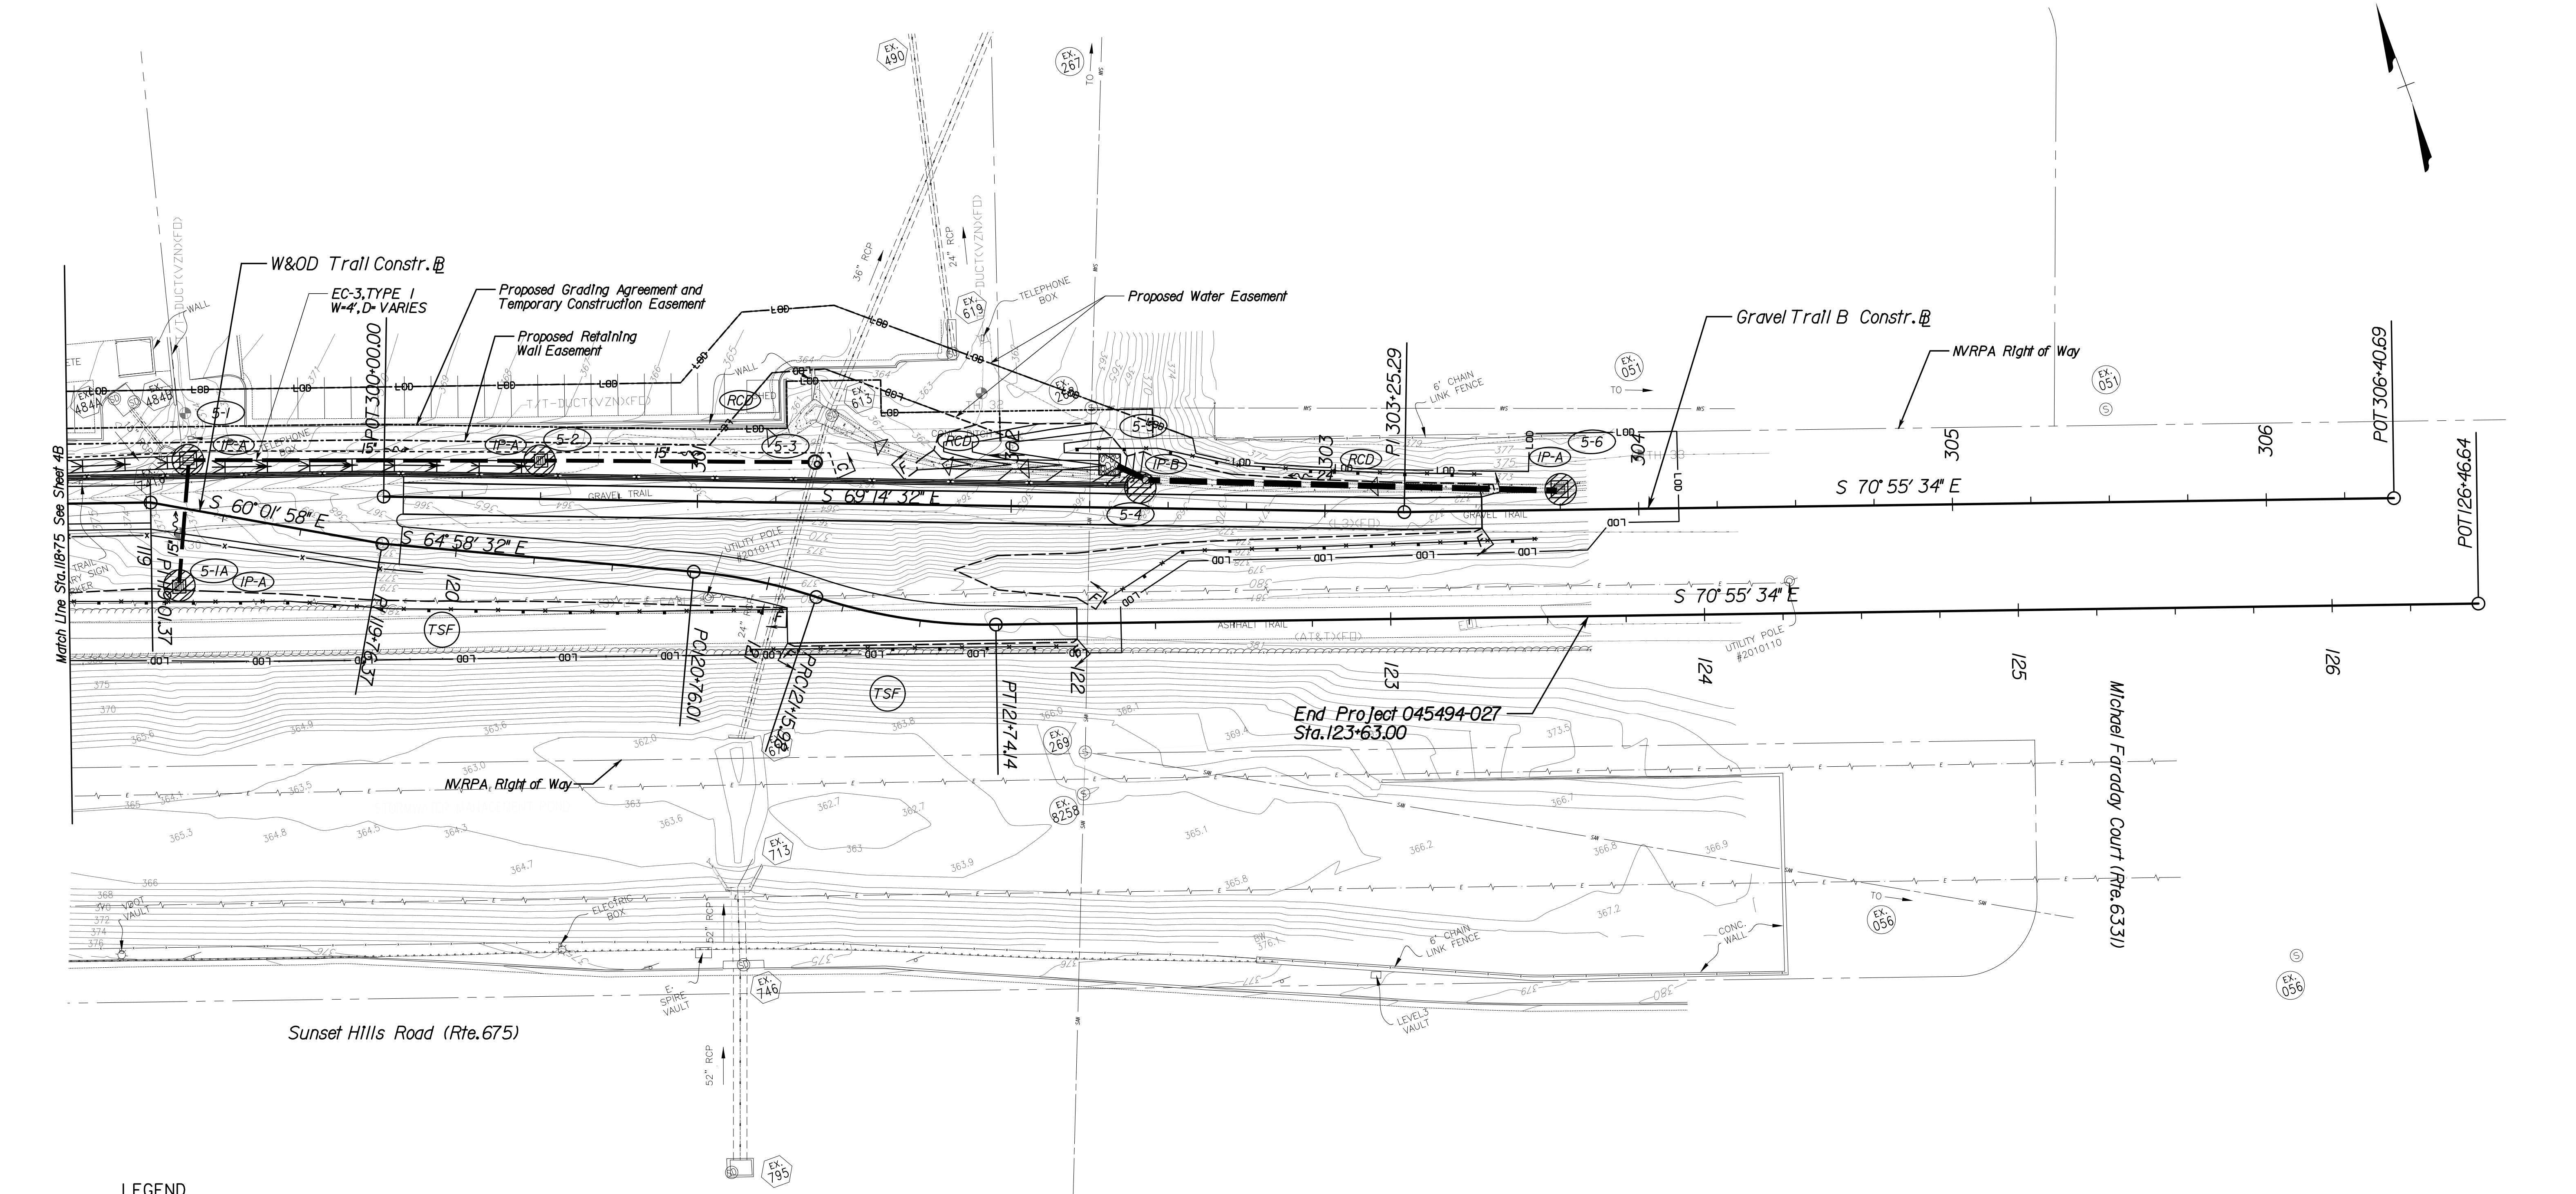

## LEGEND

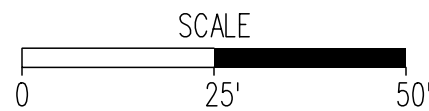
- C--- DENOTES CONSTRUCTION LIMITS IN CUT  
---E--- DENOTES CONSTRUCTION LIMITS IN FILL  
---X--- DENOTES EC-3  
---LDD--- DENOTES LIMITS OF DISTURBANCE  
IP-A IP-B DENOTES INLET PROTECTION, VESCH 3.07 AND 3.08, GUTTER BUDDY ONLY (SEE DETAIL ON SHEET 2E)  
RCD DENOTES ROCK CHECK DAMS, ST'D EC-4 TYPE II  
TSF DENOTES TEMPORARY SILT FENCE, ST'D EC-5  
CIP DENOTES CULVERT INLET PROTECTION, ST'D EC-6 TYPE C

## THE SEQUENCE OF E&S MEASURES IS GENERALLY AS FOLLOWS:

- 1.) INSTALL PERIMETER ESC MEASURES, INCLUDING SILT FENCE AND ROCK CHECK DAMS.
- 2.) PLACE INLET PROTECTION ON EXISTING STORM DRAIN SYSTEMS.
- 3.) INSTALL TEMPORARY AND PERMANENT PIPES AND CHANNELS USED TO CONVEY OFFSITE RUNOFF THROUGH THE CONSTRUCTION SITE.
- 4.) PLACE INLET PROTECTION ON PROPOSED DRAINAGE INLETS AS SOON AS THEY ARE CONSTRUCTED.
- 5.) STABILIZE ALL FINISH GRADED AREAS.
- 6.) REMOVE ALL TEMPORARY ESC MEASURES.

## NOTES:

- 1.) THIS SHEET IS TO BE USED FOR EROSION AND SEDIMENT CONTROL MEASURES ONLY!



THESE PLANS ARE UNFINISHED AND UNAPPROVED AND ARE NOT TO BE USED FOR ANY TYPE OF CONSTRUCTION.





Whitman, Requardt & Associates, LLP

EMERGENCY POLICE - FIRE - RESCUE 911							
FAIRFAX COUNTY, VIRGINIA							
DEPARTMENT OF PUBLIC WORKS AND ENVIRONMENTAL SERVICES							
12000 GOVERNMENT CENTER PARKWAY, SUITE 449 FAIRFAX, VA., 22035-0052							
R E V I S I O N S					OFFICE OF CAPITAL FACILITIES 703-324-5800		
						WIEHLE AVENUE (RTE 828) AT W&OD TRAIL EROSION & SEDIMENT CONTROL PLAN PROJECT NO: 1400102-2013	
					SCALE 1"=25'	DESIGNED: NDD DRAFTED: WRA CHECKED: RBH	SHEET 5B
Δ#	DESCRIPTION	BY	APPROVED	DATE			
APPROVED BY THE TRANSPORTATION DESIGN DIVISION							



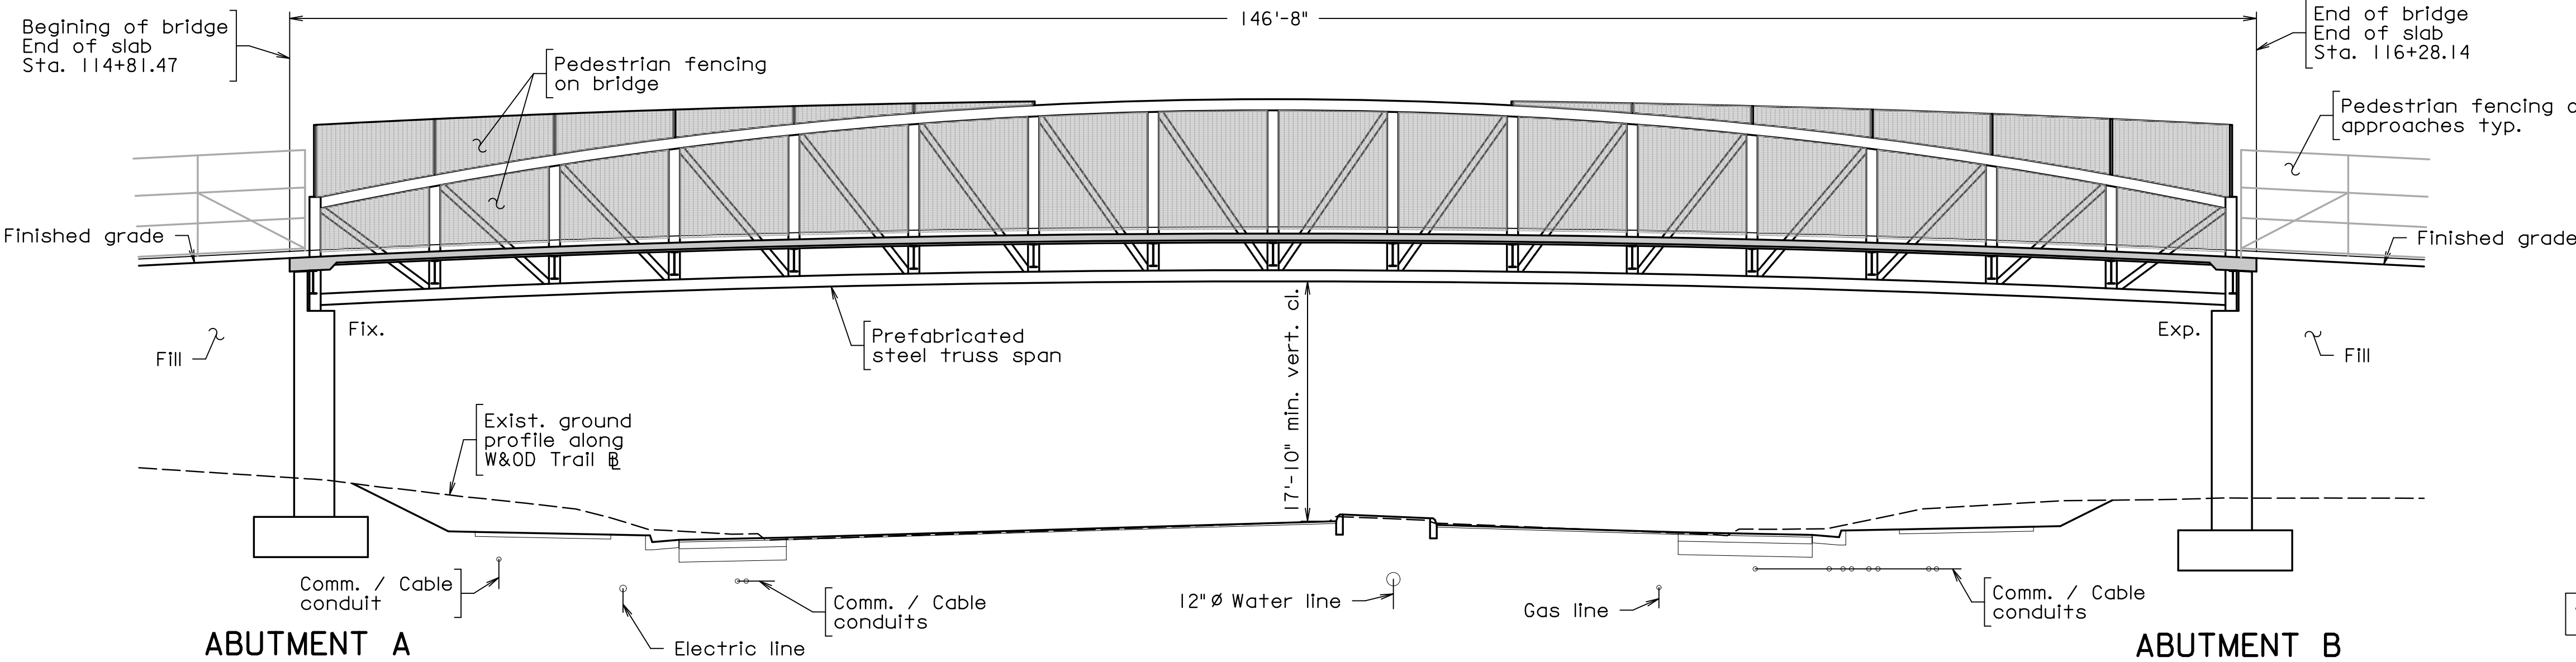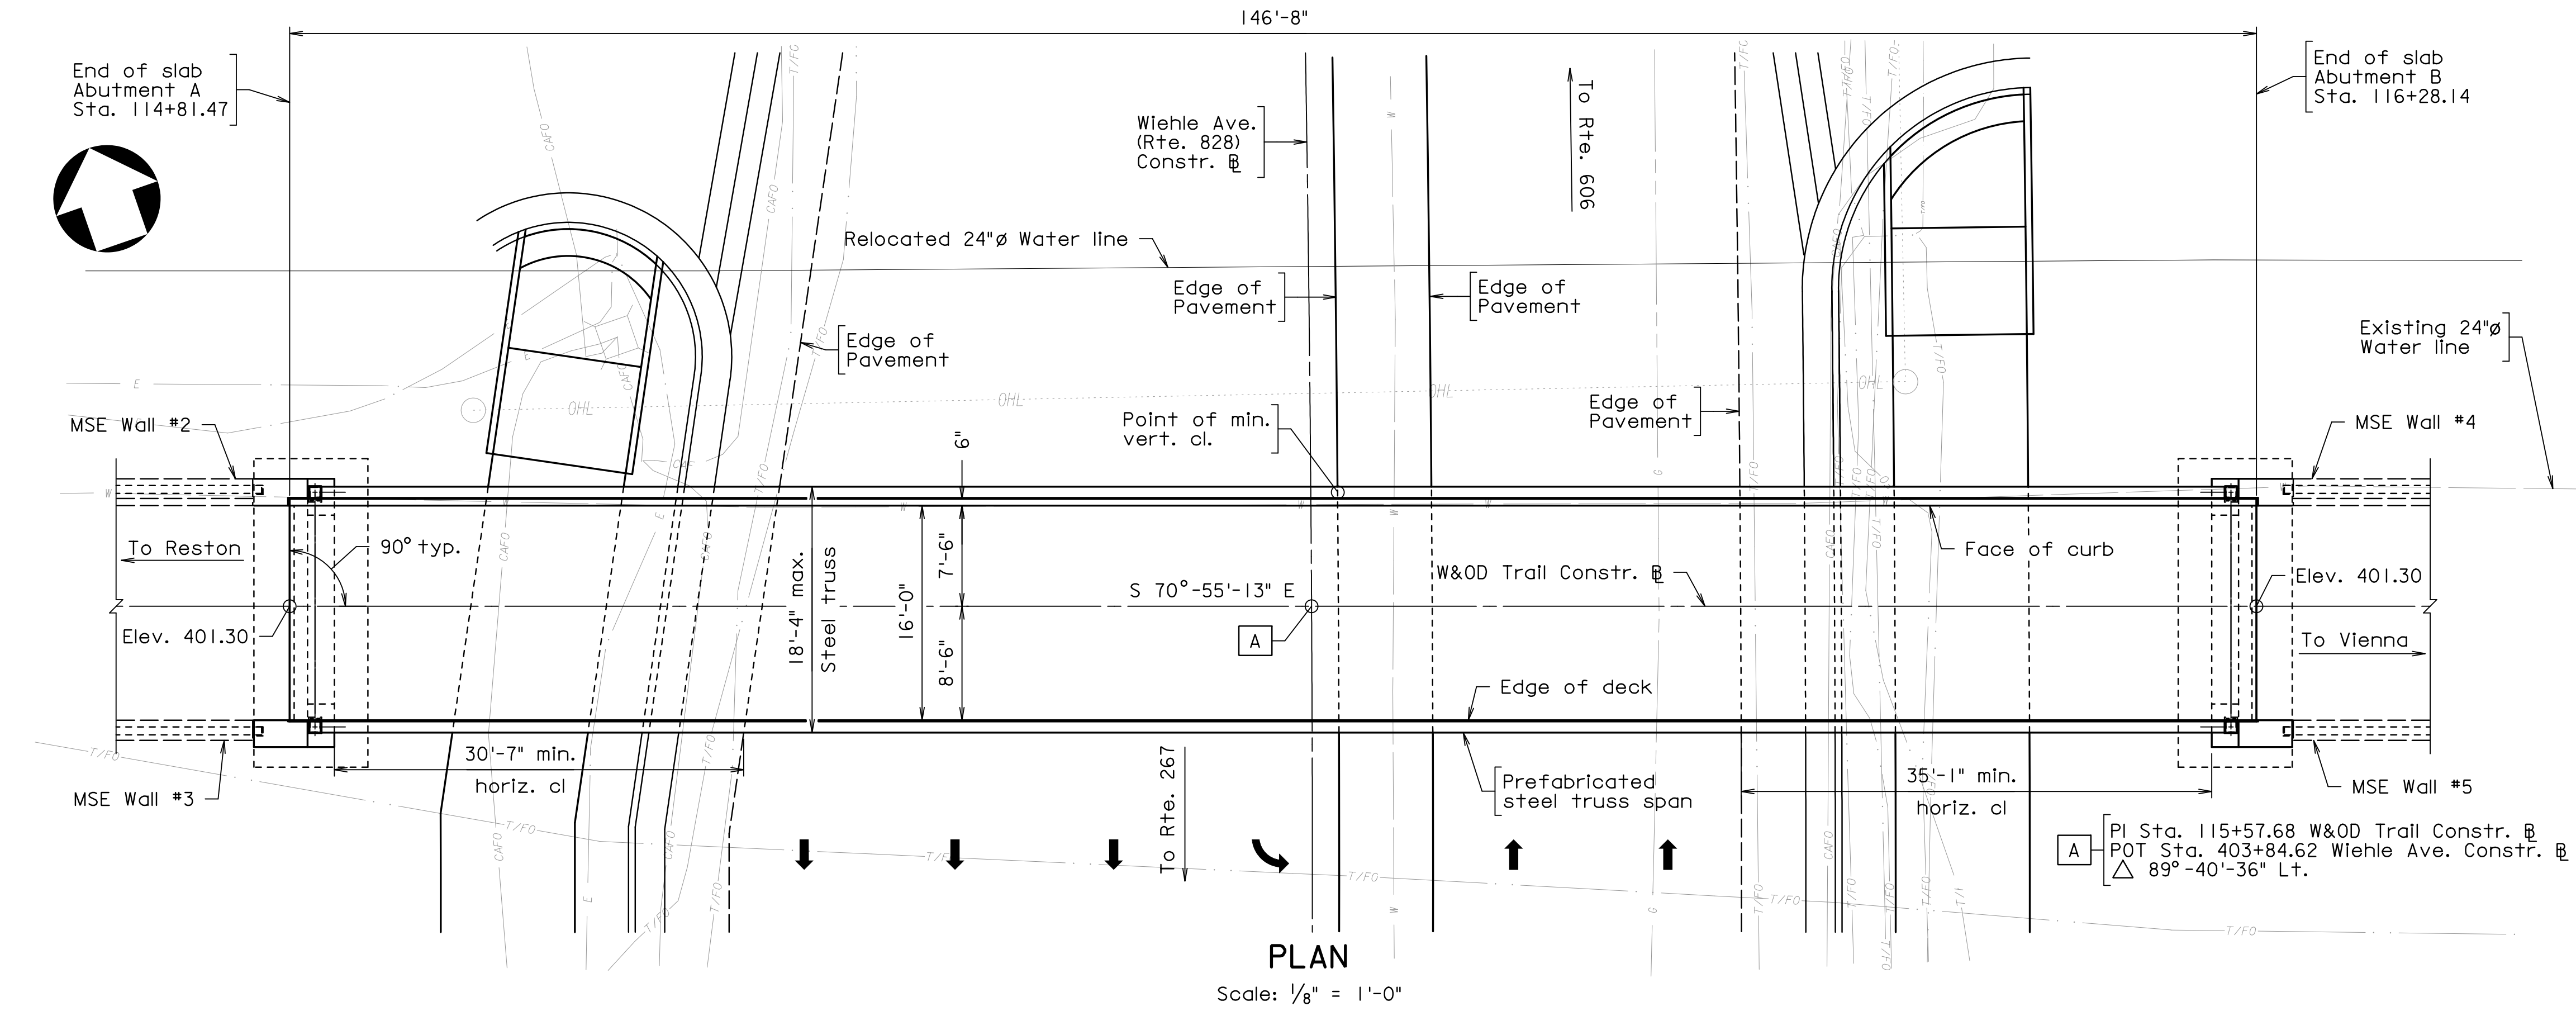PROJECT MANAGER: SCOTT, BUFFNER, P.E. (703) 293-5236  
SURVEYED BY, DATE: FAIRFAX COUNTY  
DESIGN BY: WHITMAN, REQUARDT & ASSOCIATES, LLP (703) 293-9717  
SUBSURFACE UTILITY BY, DATE: SO DEEP, INC. (703) 361-6005 December 23, 2014



DEVELOPED SECTION ALONG W&OD TRAIL CONSTR. B  
Showing Truss and fencing beyond.  
Scale: 1/8" = 1'-0"

STATE	FEDERAL AID		STATE	
	ROUTE	PROJECT	ROUTE	PROJECT
VA.	—	RSTP-5A01( )	828	0828-029-248, B-601
NBIS Number:		000000000030981	UPC No. 107439	
Federal Oversight Code:			FHWA Construction and Scour Code: X932-SN	

GENERAL NOTES:

- Width: 16'-0" face of curb to edge of deck
- Span Layout: 146'-8" simple span prefabricated steel truss span.
- Capacity: 90 psf Pedestrian Live Loading or H-10 (20,000 lb) vehicle defined as a front axle load of 4,000 lbs and a rear axle of 16,000 lbs, with axle spacing of 14'-0", wheel spacing of 6'-0".
- Specifications:
- Construction: Virginia Department of Transportation Road and Bridge Specifications, 2016 and attached Special Provisions
  - Standards: Virginia Uniform Statewide Building Code, latest edition and applicable local ordinances as determined by the County of Fairfax Building Official.
  - Design: Virginia Department of Transportation Road and Bridge Standards, 2016, including all current revisions.
  - AASHTO LRFD Bridge Design Specifications 7th Edition, 2014; and VDOT Modifications.
  - AASHTO LRFD Guide Specifications for the Design of Pedestrian Bridges, 2nd Edition 2009.
  - AISC Steel Construction Manual, 2011 14th Edition.

These plans are incomplete unless accompanied by the Specifications and Special Provisions included in the contract documents.

The Contractor shall refer to the trail plans and the Specification for general project requirements and erosion and sediment control measures.

Contractor shall be responsible for protecting existing utilities and shall repair or replace, at no additional cost, if damaged, as directed by the County.

For W&OD Trail Constr. Baseline alignment data and information, see trail sheets.

The Contractor shall be responsible for obtaining all necessary permits from the County before beginning construction.

The Contractor shall field verify all dimensions, locations, and elevations of existing structures and utilities shown on the current drawings. All discrepancies between field conditions and these plans shall be brought to the attention of the project manager for the County before proceeding with work that is directly affected by the discrepancy.

Any deviations from the approved plans and/or Specifications must be approved by the Engineer/Owner in writing prior to the start of the affected portion of work.

All excavation, temporary support, dewatering and backfilling shall be in accordance with Section 401 of the Specifications. All excavations shall be clean and dry prior to the placement of any concrete.

All formwork shall be in accordance with Section 404 of the VDOT Specifications.

The Contractor shall refer to the plans herein for the design, fabrication and installation requirements of the prefabricated steel truss spans.

Concrete in superstructure shall be Low Shrinkage Class A4 Modified in accordance with section 217.12(a); in abutments Class A3.

Abutment concrete shall be finished in accordance with Section 404.07 of the VDOT Specifications, Class 2 rubbed finished, except for bridge seat bearing areas.

For continuation of General notes, see sheet 6(2).

VDOT please provide

PREFINAL PLANS

EMERGENCY POLICE - FIRE - RESCUE 911			
FAIRFAX COUNTY, VIRGINIA			
DEPARTMENT OF PUBLIC WORKS AND ENVIRONMENTAL SERVICES			
12000 GOVERNMENT CENTER PARKWAY, SUITE 449 FAIRFAX, VA., 22035-0052			
OFFICE OF CAPITAL FACILITIES		703-324-5800	
WIEHLE AVENUE (RTE 828) AT W&OD TRAIL		TITLE SHEET: PLAN, DEVELOPED SECTION AND GENERAL NOTES	
PROJECT NO: 1400102-2013		PLAN NO: XXX-XX	
DESIGNED: JRM		SHEET 6(1)	
DRAFTED: CRR		CHECKED: TAB	
APPROVED BY THE TRANSPORTATION DESIGN DIVISION			

WHITMAN REQUARDT & ASSOCIATES	BY	APPROVED	DATE
RICHMOND, VA			
STRUCTURAL ENGINEER			



PROJECT MANAGER: SCOTT, BUFFNER, P.E., (703) 877-5236  
SURVEYED BY, DATE: FAIRFAX COUNTY  
DESIGN BY: WHITMAN, REQUARDT & ASSOCIATES, LLP, (703) 293-9717  
SUBSURFACE UTILITY BY, DATE: SO DEEP, INC., (703) 361-6005, December 23, 2014

ESTIMATED QUANTITIES - SUBSTRUCTURE ONLY									
		Concrete Class A3	Corrosion Resistant Reinf. Steel, Class I	Reinforcing Steel	Struct. Excav.	Retaining Structure	Geo- composite Wall Drain	Pipe Underdrain 6"	Pedestrian Fence 8'
		CY	LB	LB	CY⊗	SF	SY	LF	LF
Abutment A	Neat	43.4	4,000	_____	_____	3,872	27	25	499
	Footing	21.6	_____	1,800	67	_____	_____	_____	_____
Abutment B	Neat	48.1	4,200	_____	_____	12,019	28	25	751
	Footing	21.6	_____	1,800	61	_____	_____	_____	_____
Totals		134.7	8,200	3,600	128	15,891	55	50	1,250

⊗ Denotes items to be paid for on the basis of plan quantities in accordance with current VDOT Road and Bridge Specifications.

LUMP SUM BID ITEMS	
Mobilization	LS
Construction Surveying	LS
Procure Prefabricated Steel Truss	LS
Install Prefabricated Steel Truss	LS
Architectural Treatment	LS

ESTIMATED QUANTITIES - SUPERSTRUCTURE ONLY			
Item		Units	Quantity
Concrete Low shrinkage Class A4 Mod.		CY	63.0
Corrosion Resistant Reinf. Steel, ⊗ Class I		LB	9,500

⊗ Denotes items to be paid for on the basis of plan quantities in accordance with current VDOT Road and Bridge Specifications.

GENERAL NOTES CONTINUED:

Bridge seat bearing areas shall be installed level in areas of bearing according to dimensions provided by bridge manufacturer or the plans herein with the remainder of the seat installed with a 1/2" wash according to details herein, see Section 404.06 of the VDOT Specifications for additional requirements.

All exposed concrete edges shall be chamfered 3/4" unless otherwise noted.

Deformed reinforcing bars shall conform to ASTM A615, Grade 60. All reinforcing bar dimensions on the detailed drawings are to centers of bars except where otherwise noted and are subject to fabrication and construction tolerances.

All reinforcing steel shall be deformed and shall conform to ASTM A615, Grade 60 except for reinforcing steels noted as CRR (corrosion resistant reinforcing) which shall conform to Section 223 of the Specifications. All reinforcing bar dimensions on the detailed drawings are to centers of bars except where otherwise noted and are subject to fabrication and construction tolerances.

Corrosion resistant reinforcing (CRR) steels shall conform to one or more of the three Classes listed in Section 223 of the Specifications. The Class(es) of CRR steel(s) required on this project is/are noted on the plan sheets and in the reinforcing steel schedule. Corrosion Resistant Reinforcing Steel, Class II or Class III may be substituted for Class I. Corrosion Resistant Reinforcing Steel, Class III, may be substituted for Class II.

Footings for abutments shall bear on firm material. For bearing requirements, see the Spread Footing Data Table on sheet 6(3).

The Geotechnical Engineer of Record shall inspect all footing subgrades and certify that the exposed bearing material meets design requirements. If unsuitable material is encountered, Contractor shall overexcavate as directed by the Geotechnical Engineer and replace with unreinforced Class C1 concrete.

B.M.:

STATE	FEDERAL AID		STATE	
	ROUTE	PROJECT	ROUTE	PROJECT
VA.	—	RSTP-5A01( )	828	0828-029-248, B-601

INDEX OF SHEETS	
Sheet No.	Description
6(1)	Title Sheet: Plan, Developed Section and General Notes
6(2)	Estimated Quantities and Index of Sheets
6(3)	Substructure Layout
6(4)	Abutment A Plan and Elevation
6(5)	Abutment A Footing Plan and Details
6(6)	Abutment B Plan and Elevation
6(7)	Abutment B Footing Plan and Details
6(8)	Transverse Section
6(9)	Framing Plan
6(10)	Prefabricated Steel Truss Details
6(11)	Deck Slab Elevations
6(12)	Deck Slab Plan and Details
6(13)	Pedestrian Fence Details - 8 ft. fence
6(14)	Wire Mesh Fence Panel Details on Superstructure
6(15)	Architectural Treatment Details
6(16)	Reinforcing Steel Schedule - Abutments
6(17)	Engineering Geology (1 of 6)
6(18)	Engineering Geology (2 of 6)
6(19)	Engineering Geology (3 of 6)
6(20)	Engineering Geology (4 of 6)
6(21)	Engineering Geology (5 of 6)
6(22)	Engineering Geology (6 of 6)
6(23)	MSE Walls General Notes and Details
6(24)	MSE Wall Layout (1 of 2)
6(25)	MSE Wall Layout (2 of 2)
6(26)	MSE Wall Elevations Walls 2 and 3
6(27)	MSE Wall Elevation Wall 4
6(28)	MSE Wall Elevation Wall 5
6(29)	MSE Wall Architectural Treatment Details

Rev. No.	Sheets Revised	Date
TABLE OF REVISIONS		

PREFINAL PLANS

EMERGENCY POLICE - FIRE - RESCUE 911										
FAIRFAX COUNTY, VIRGINIA										
DEPARTMENT OF PUBLIC WORKS AND ENVIRONMENTAL SERVICES										
12000 GOVERNMENT CENTER PARKWAY, SUITE 449 FAIRFAX, VA., 22035-0052										
R E V I S I O N S						OFFICE OF CAPITAL FACILITIES 703-324-5800				
						WIEHLE AVENUE (RTE 828) AT W&OD TRAIL				
						ESTIMATED QUANTITIES AND INDEX OF SHEETS				
						PROJECT NO: 1400102-2013				
						PLAN NO.	DESIGNED: JRM	SHEET		
						XXX-XX	DRAFTED: CRR	6(2)		
							CHECKED: TAB			
	APPROVED BY THE TRANSPORTATION DESIGN DIVISION									

WHITMAN REQUARDT & ASSOCIATES RICHMOND, VA STRUCTURAL ENGINEER	△#	DESCRIPTION	BY	APPROVED	DATE
--	----	-------------	----	----------	------

FUND # 500-C5000

THESE PLANS ARE UNFINISHED AND UNAPPROVED AND ARE NOT TO BE USED FOR ANY TYPE OF CONSTRUCTION.



PROJECT MANAGER: SCOTT, BUFFNER, P.E., (703) 877-5236  
SURVEYED BY, DATE: FAIRFAX COUNTY  
DESIGN BY: WHITMAN, REQUARDT & ASSOCIATES, LLP, (703) 293-9717  
SUBSURFACE UTILITY BY, DATE: SO DEEP, INC., (703) 361-6005, December 23, 2014

STATE	FEDERAL AID		STATE	
	ROUTE	PROJECT	ROUTE	PROJECT
VA.	—	—	828	0828-029-248, B-601

Notes:

This substructure layout is to be used only for the purpose of locating the footings of the abutments.

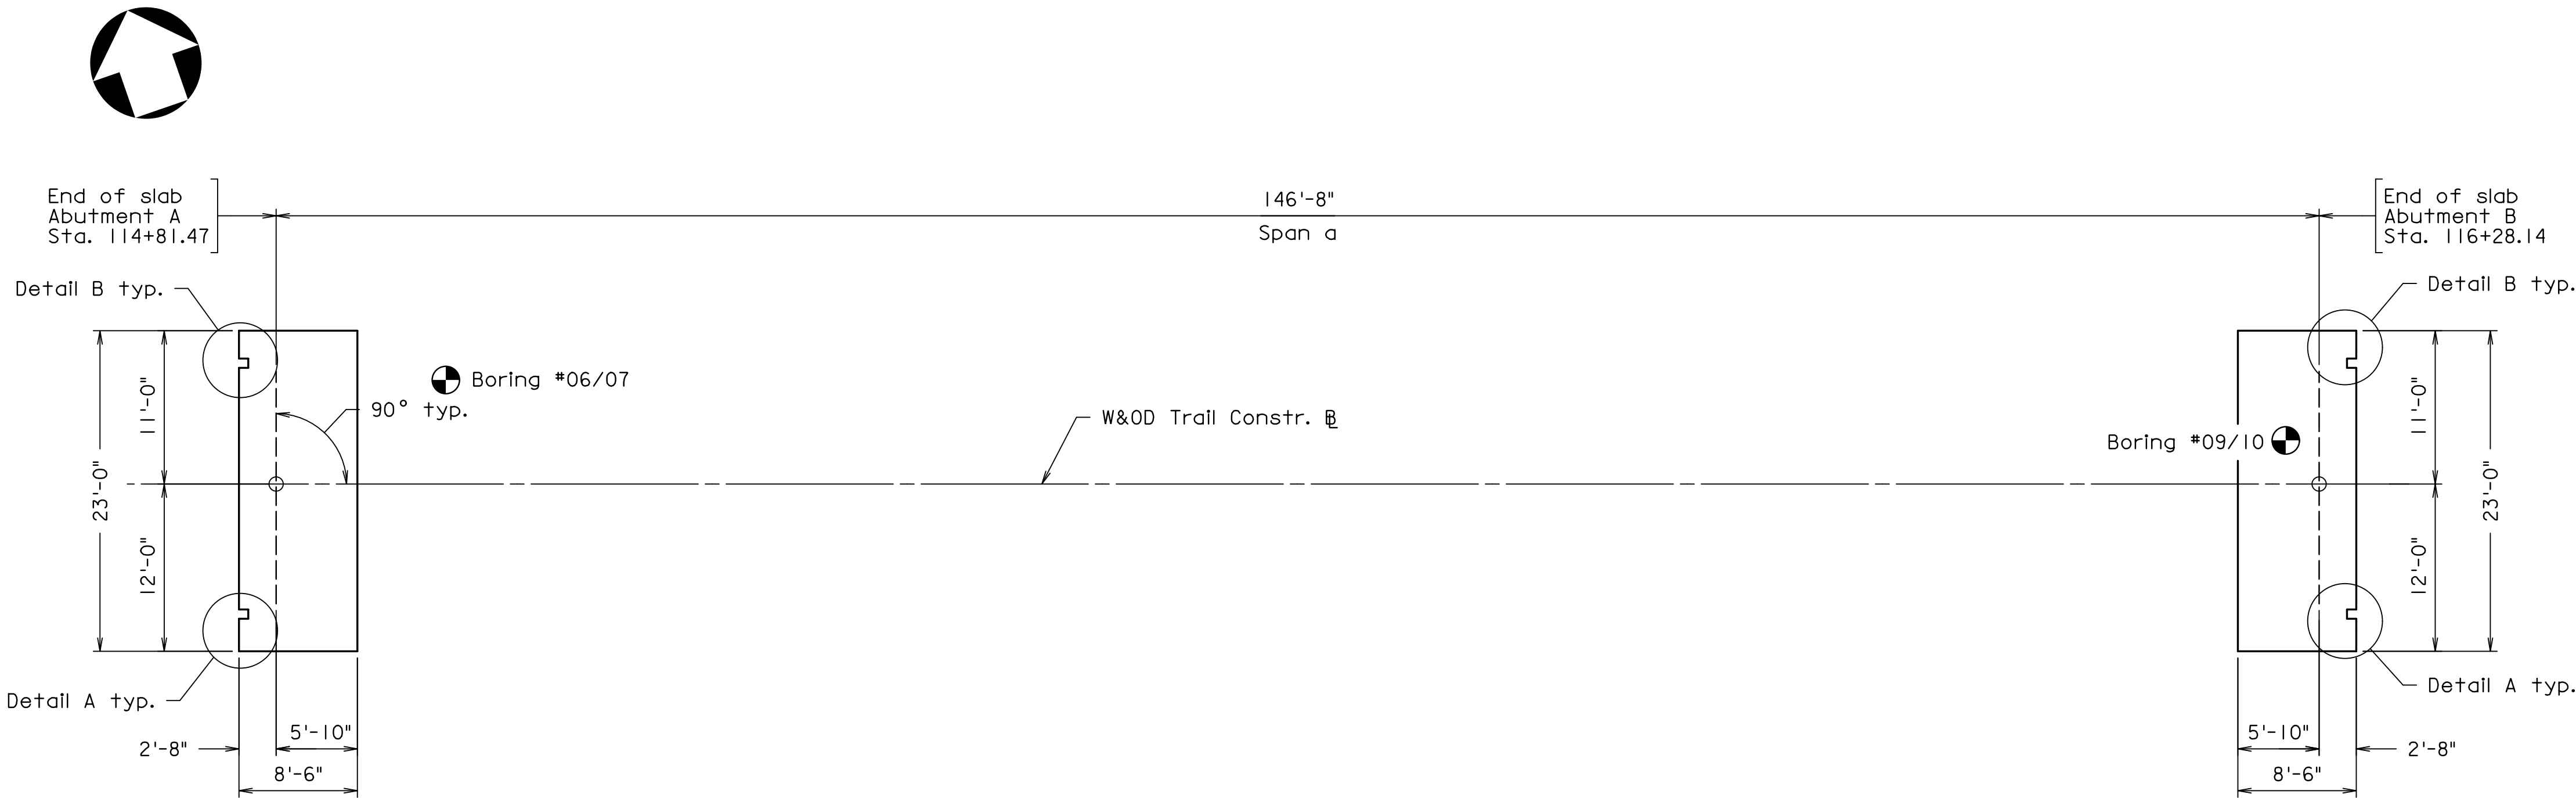
For abutment details, see sheets 6(4) through 6(7).

For Engineering Geology, see sheets 6(17) through 6(22).

For MSE walls, see sheets 6(23) through 6(29).


Legend:

 Indicates boring location



SUBSTRUCTURE LAYOUT


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DETAIL A

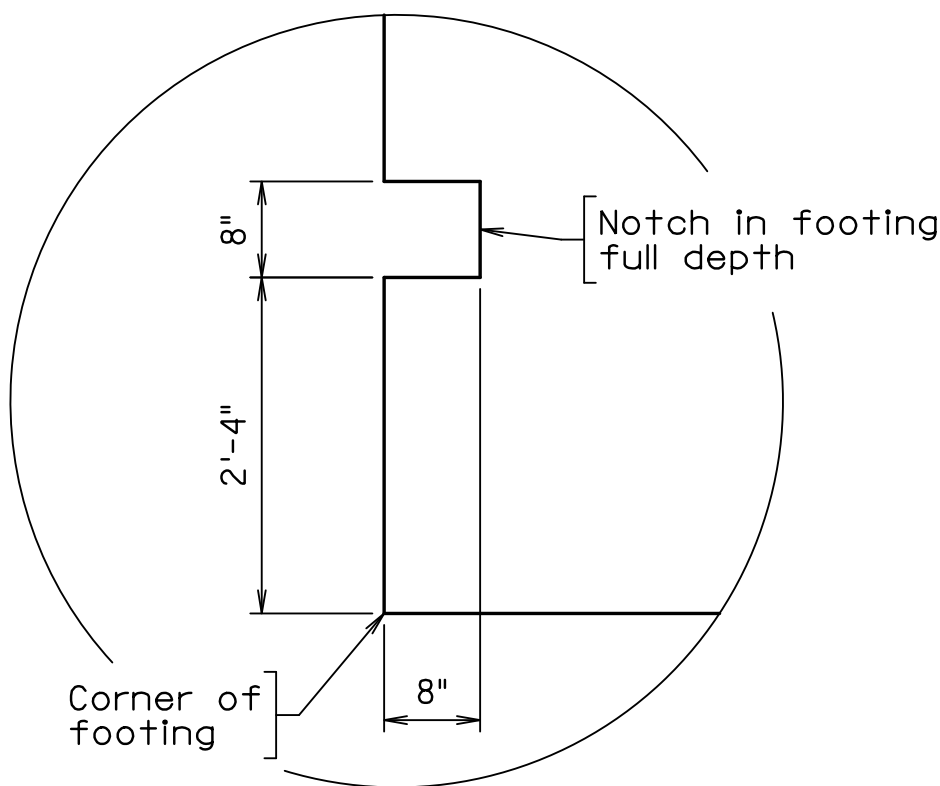Abut. A shown, Abut. B opposite hand

Scale: 3/4" = 1'-0"



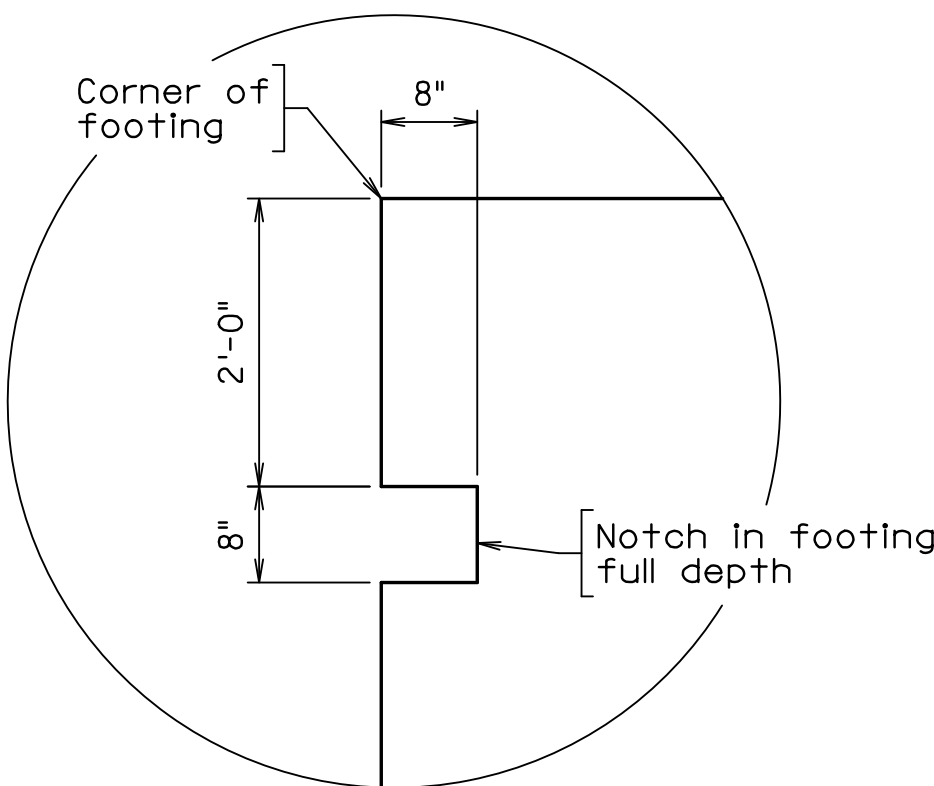DETAIL B

Abut. A shown, Abut. B opposite hand

Scale: 3/4" = 1'-0"

SPREAD FOOTING DATA TABLE				
Substructure Unit	SERVICE		STRENGTH	
	Nominal Bearing Resistance (tsf)	Tolerable Settlement (Inches)	Nominal Bearing Resistance (tsf)	Factored Bearing Resistance (tsf)
Abutment A	3.0	1.0	8.3	3.7
Abutment B	3.0	1.0	8.3	3.7

The Service Limit State controls the footing design.


PREFINAL PLANS

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FAIRFAX COUNTY, VIRGINIA						
DEPARTMENT OF PUBLIC WORKS AND ENVIRONMENTAL SERVICES						
12000 GOVERNMENT CENTER PARKWAY, SUITE 449 FAIRFAX, VA., 22035-0052						
R E V I S I O N S						
W H I T M A N R E Q U A R D T & A S S O C I A T E S L L P	OFFICE OF CAPITAL FACILITIES 703-324-5800					
	WIEHLE AVENUE (RTE 828) AT W&OD TRAIL					
	SUBSTRUCTURE LAYOUT					
	PROJECT NO: 1400102-2013					
	PLAN NO. XXX-XX	DESIGNED: JRM DRAFTED: CRR CHECKED: TAB	SHEET 6(3)			
APPROVED BY THE TRANSPORTATION DESIGN DIVISION						
FUND # 500-C5000						


THESE PLANS ARE UNFINISHED AND UNAPPROVED AND ARE NOT TO BE USED FOR ANY TYPE OF CONSTRUCTION.



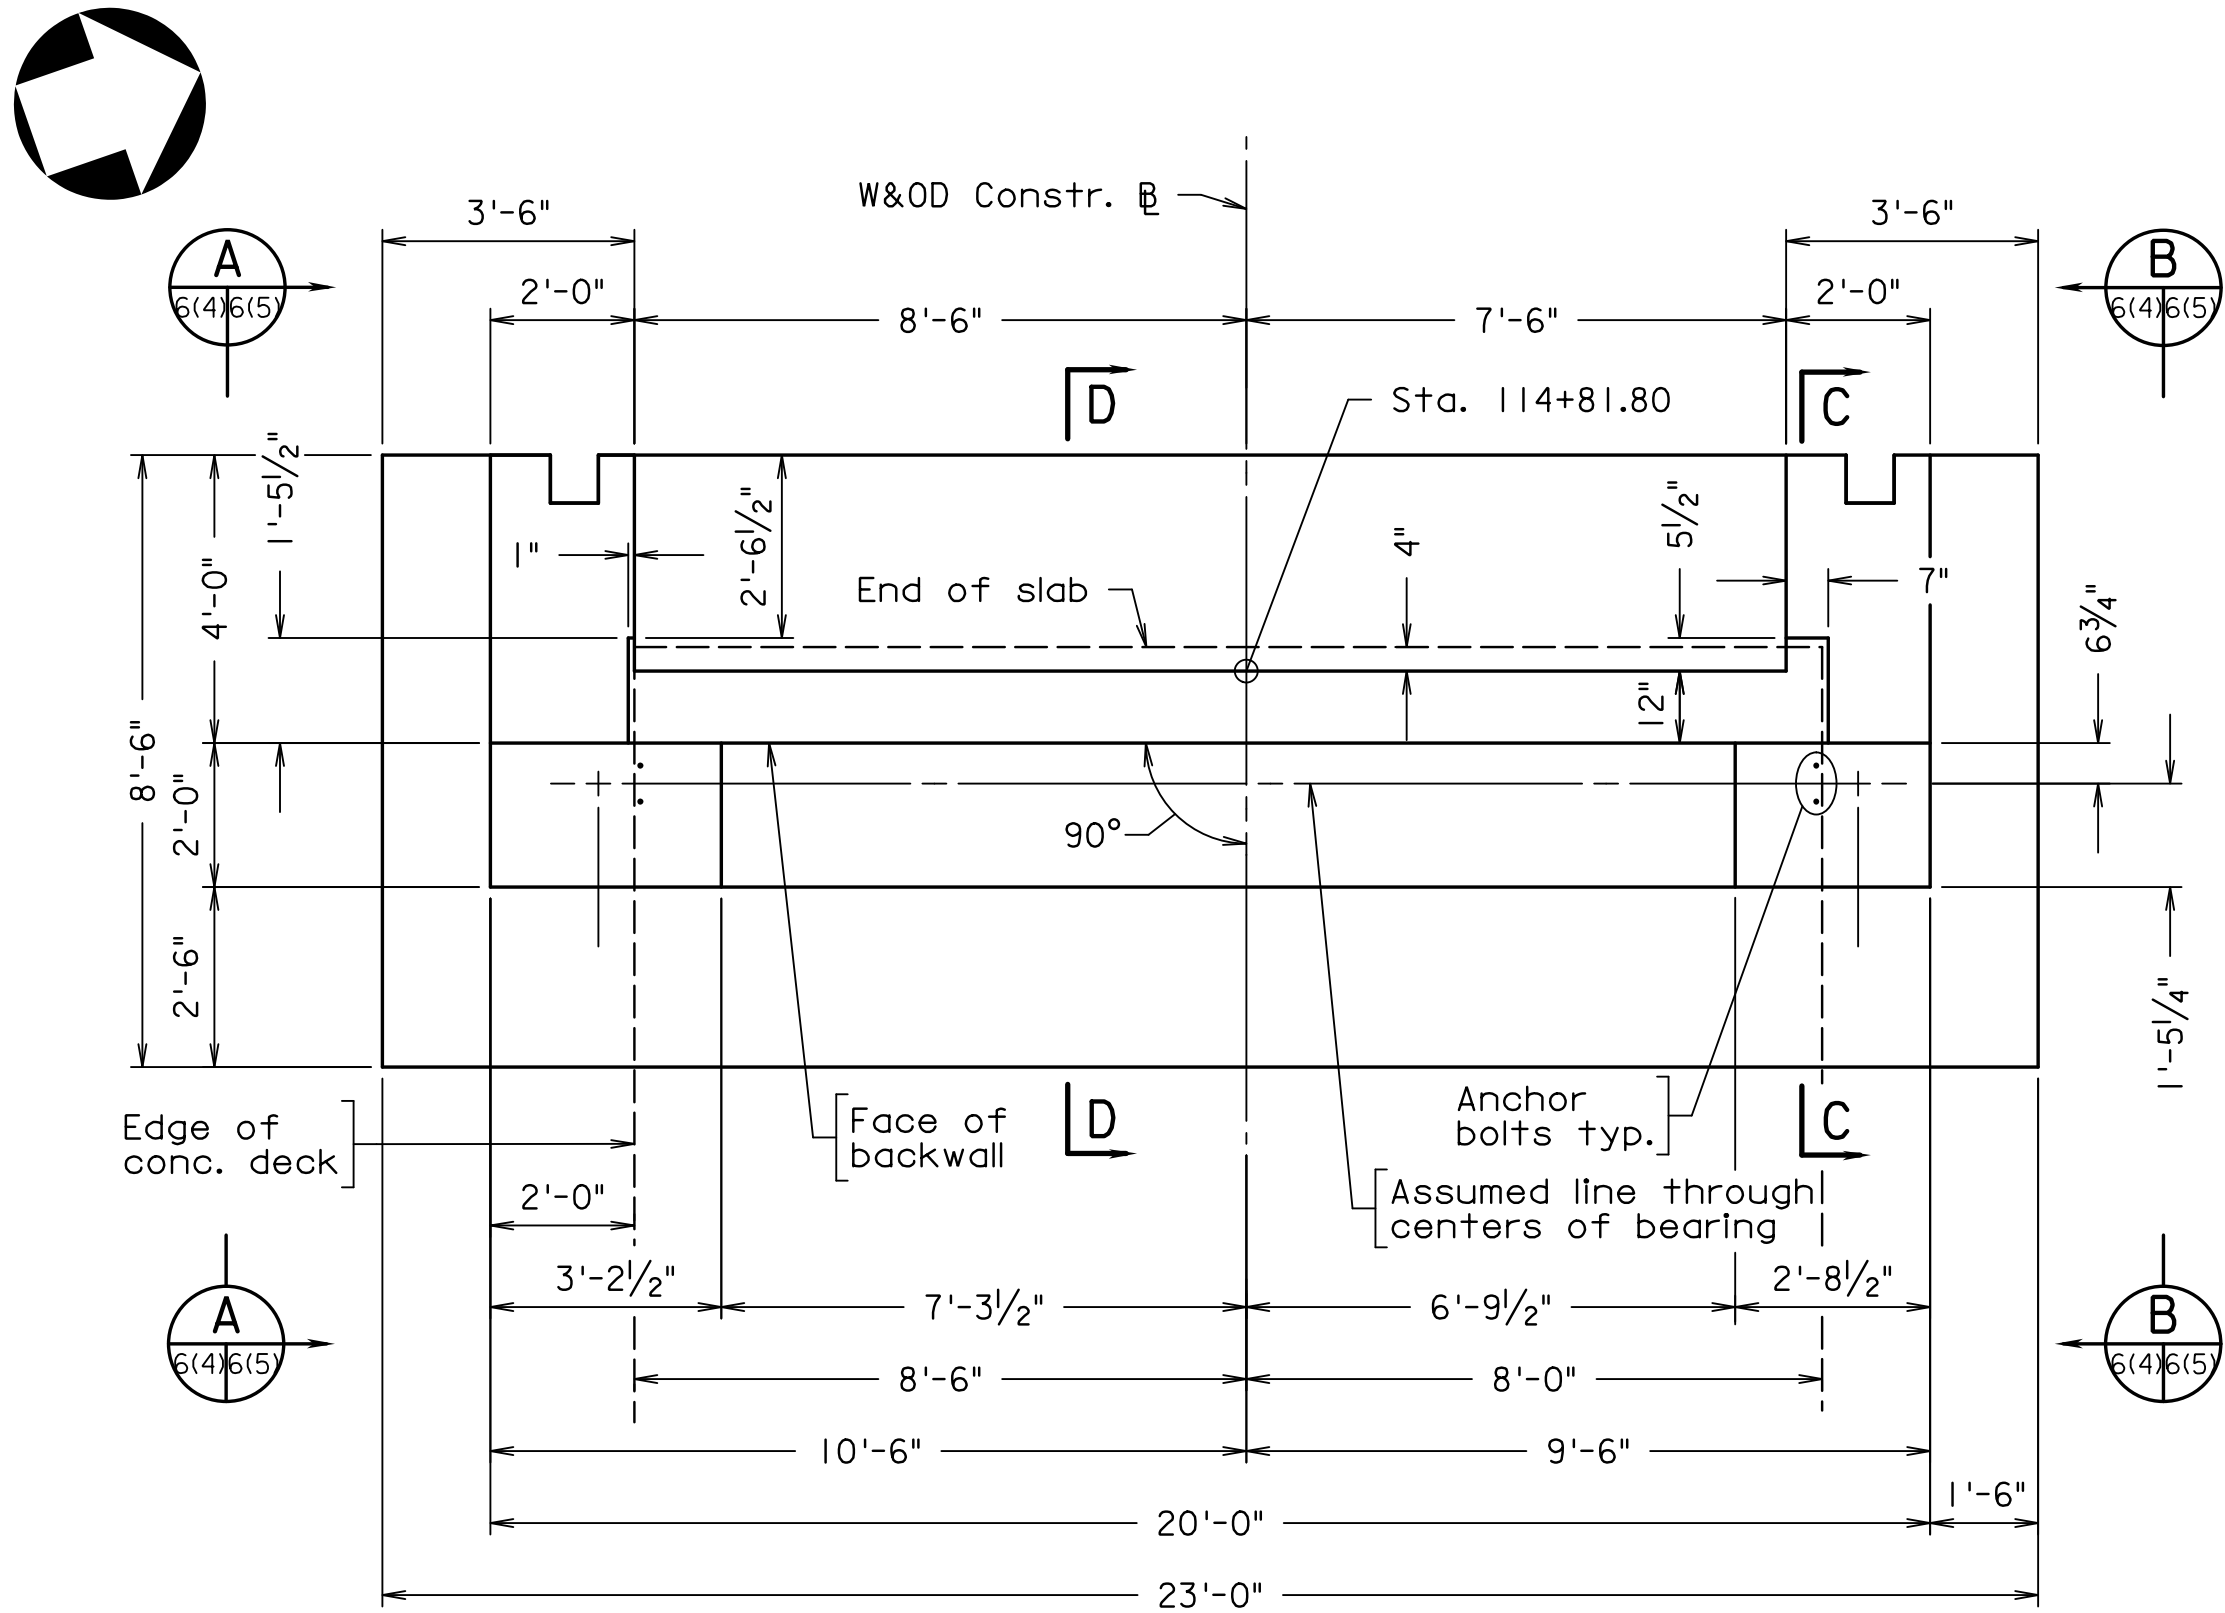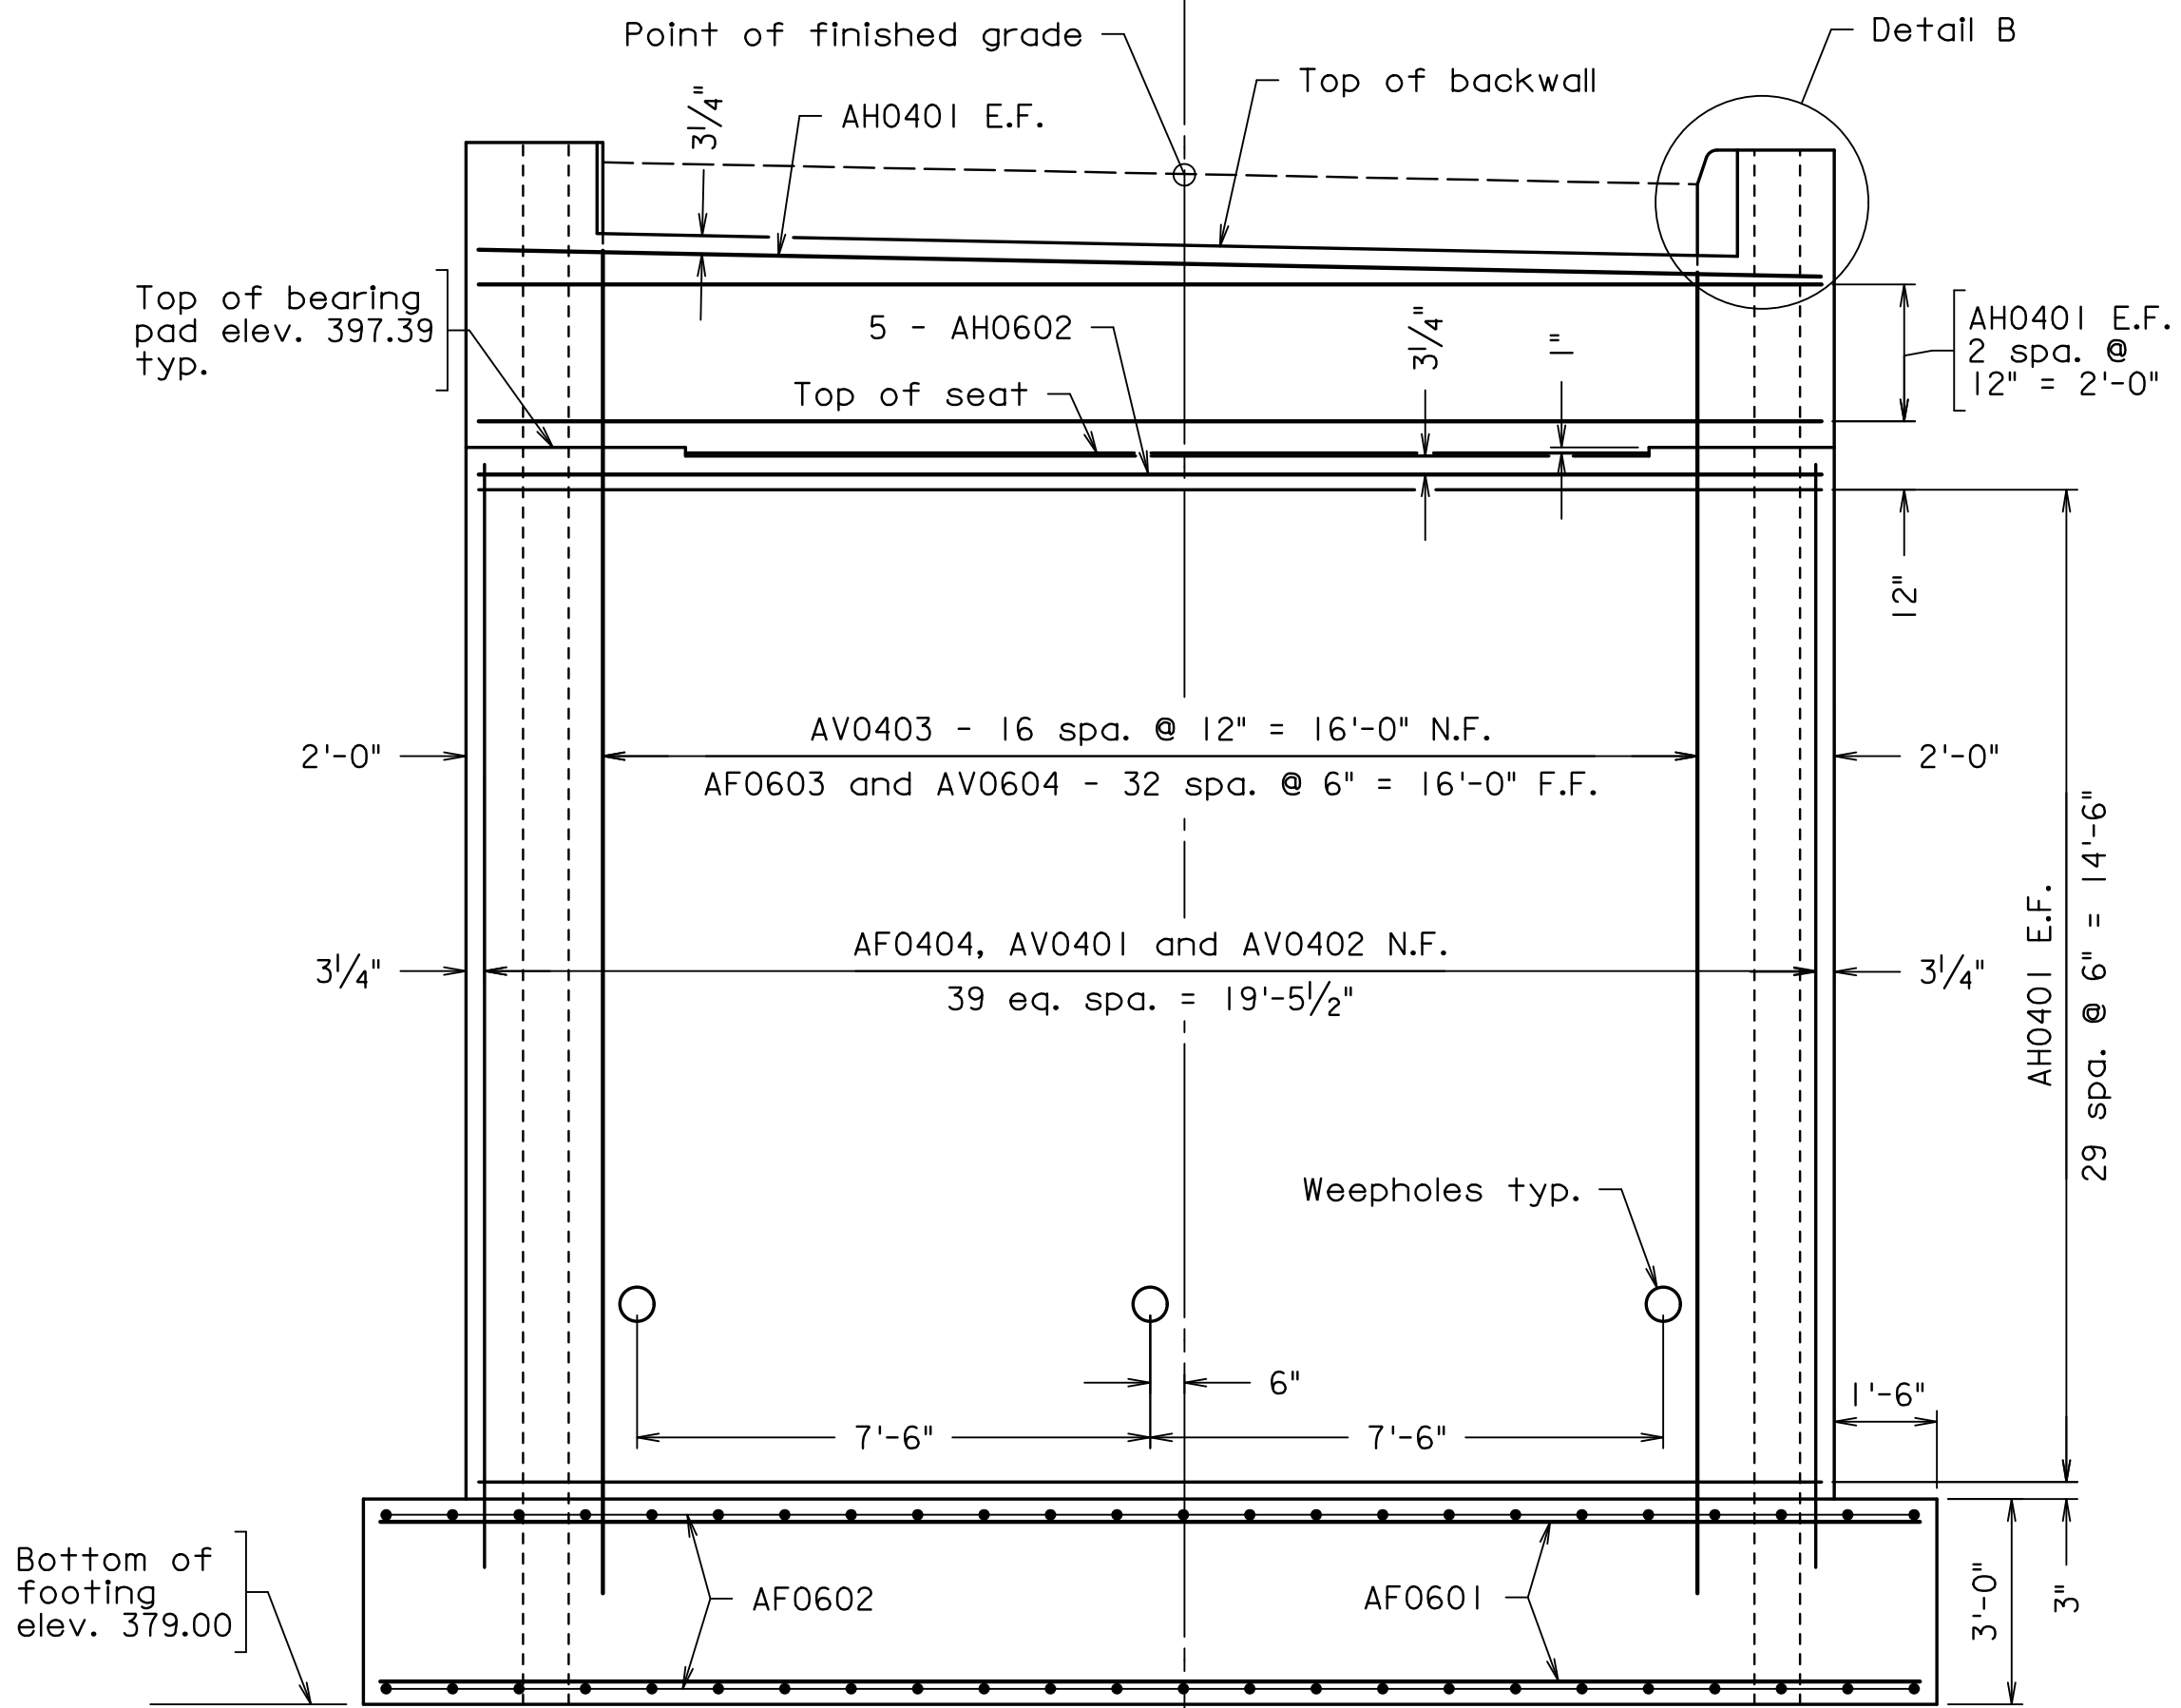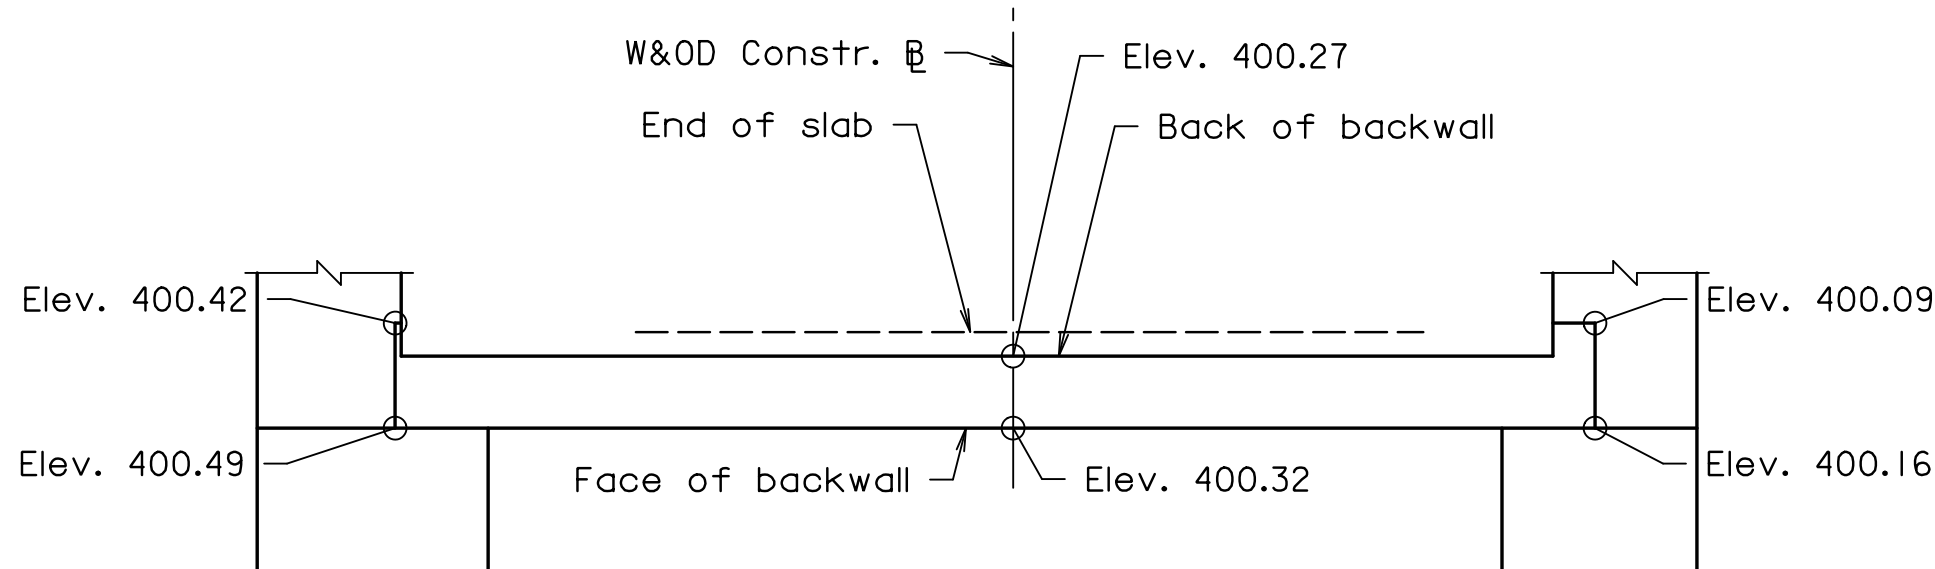
PROJECT MANAGER: SCOTT J. BUFFNER, P.E., (703) 877-5236  
SURVEYED BY, DATE: FAIRFAX COUNTY  
DESIGN BY: WHITMAN, REQUARDT & ASSOCIATES, LLP, (703) 293-9717  
SUBSURFACE UTILITY BY, DATE: SO DEEP, INC. (703) 361-6005, December 23, 2014



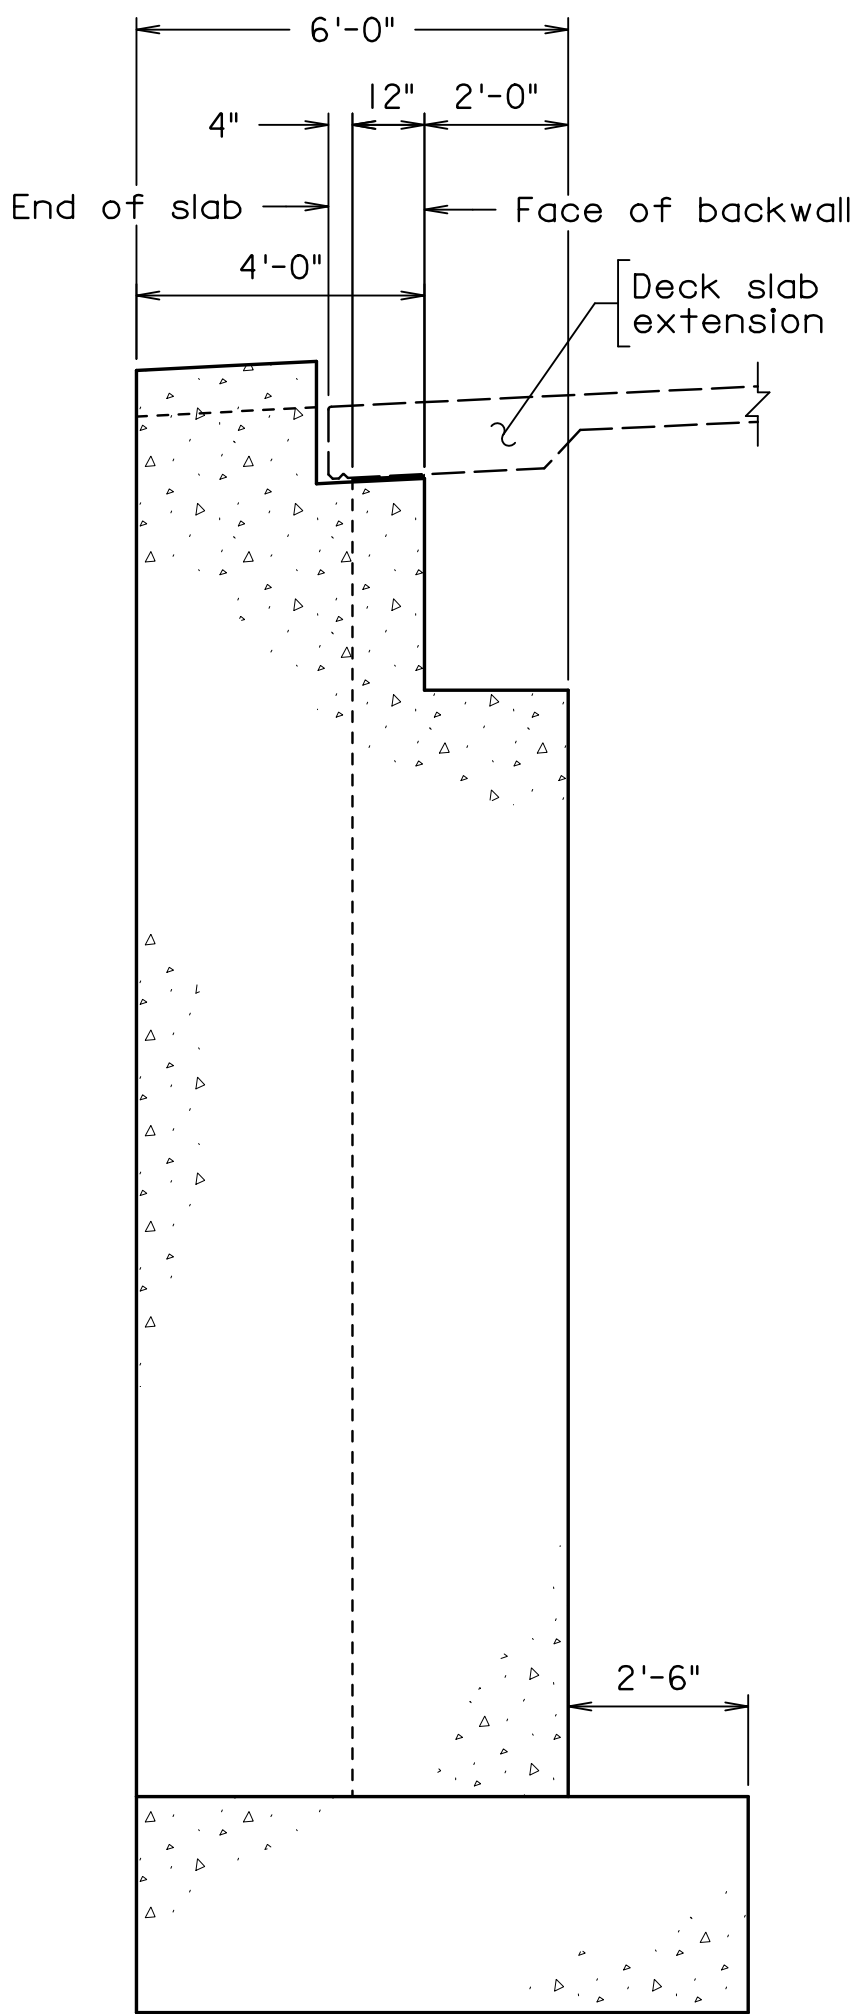
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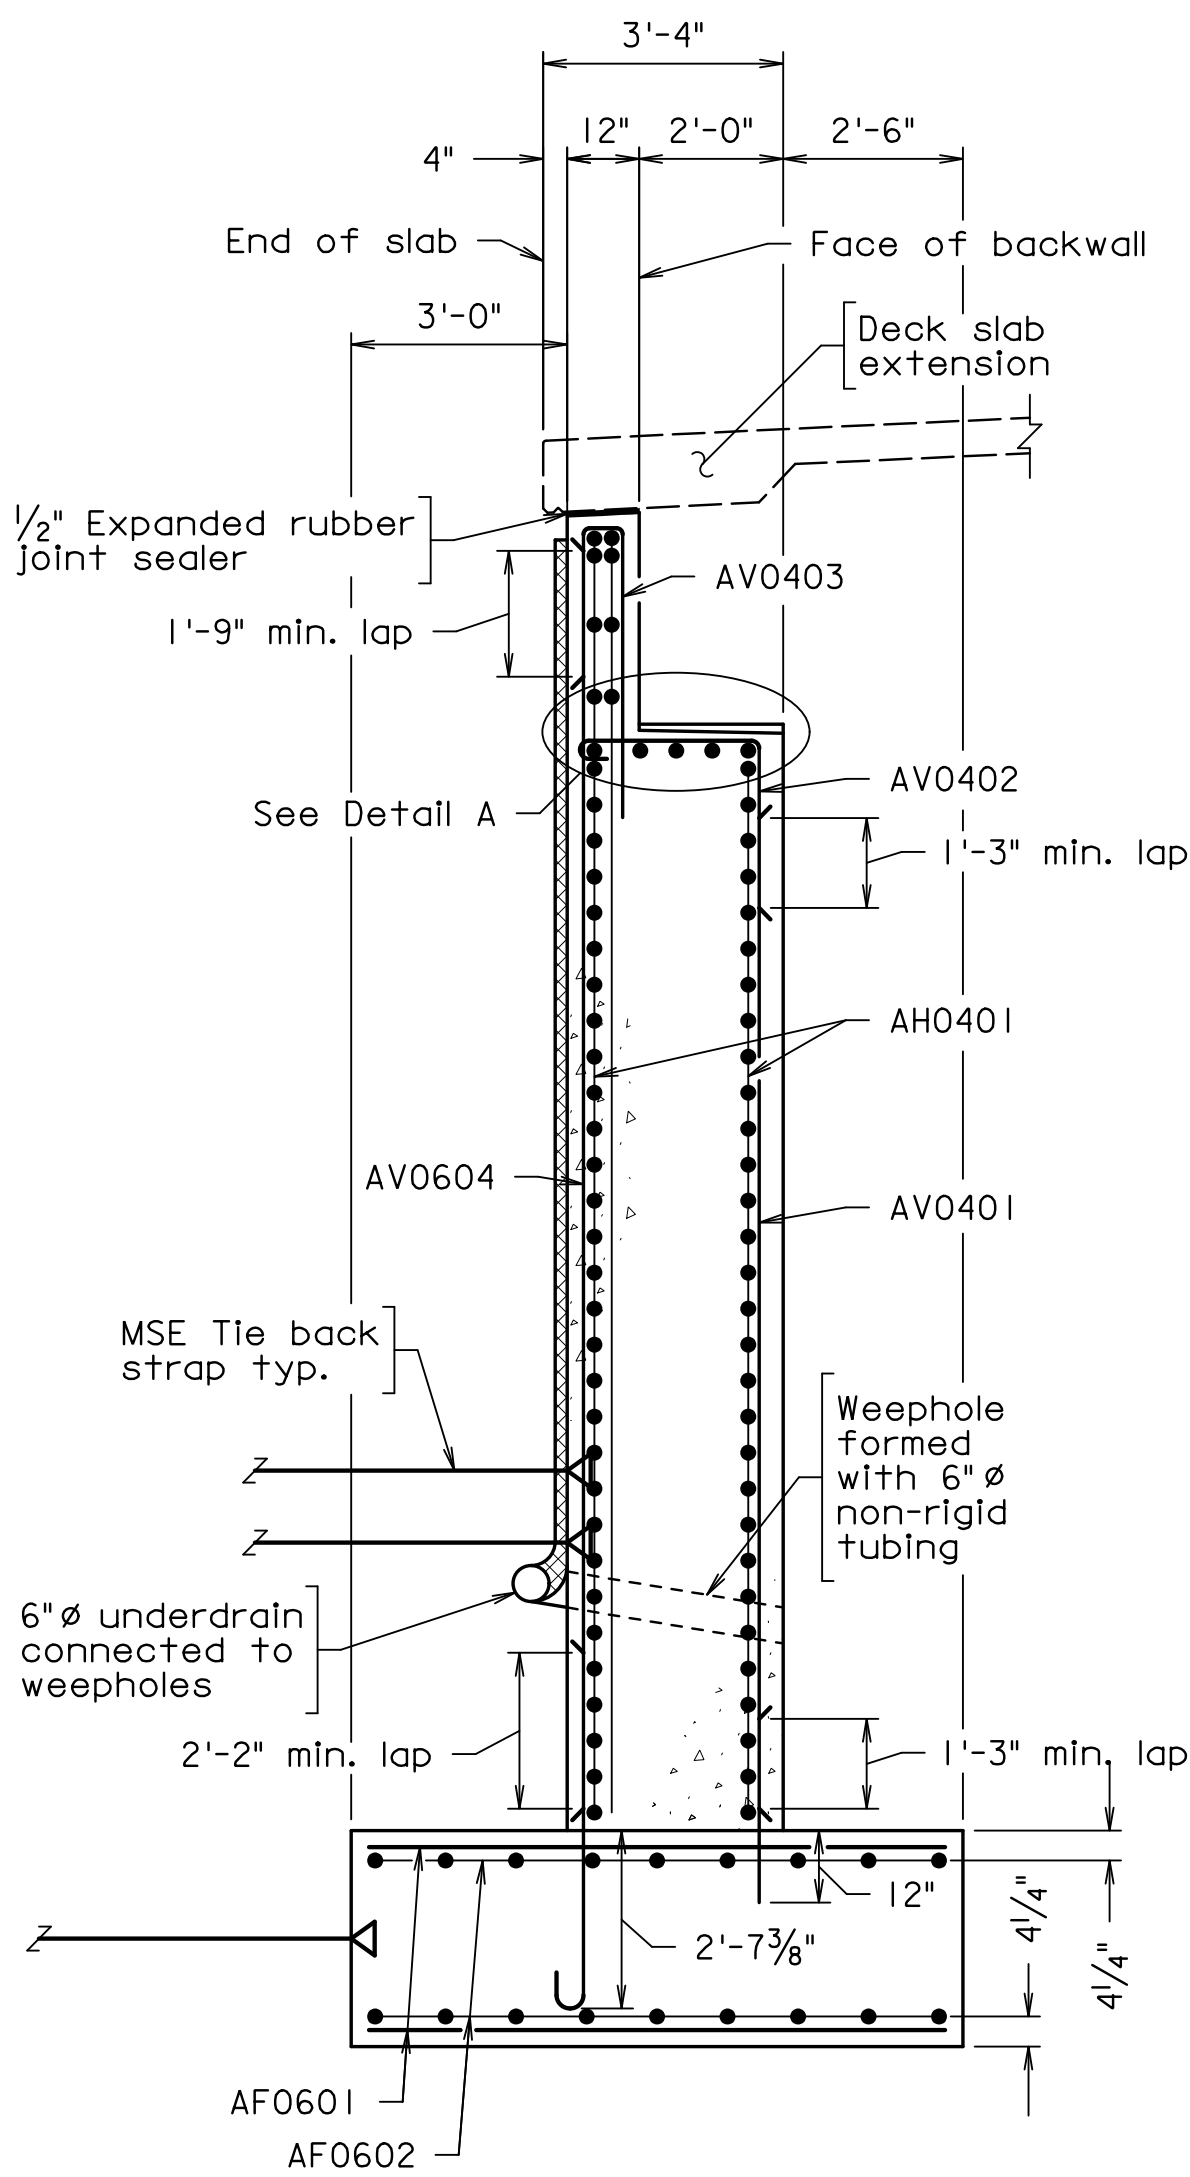
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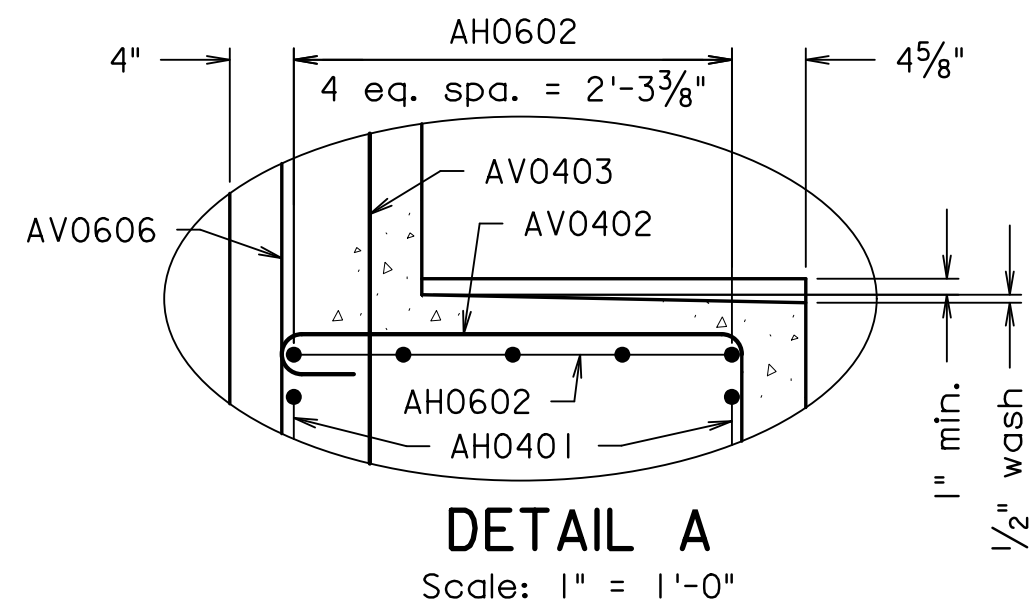
TOP OF BACKWALL ELEVATIONS  
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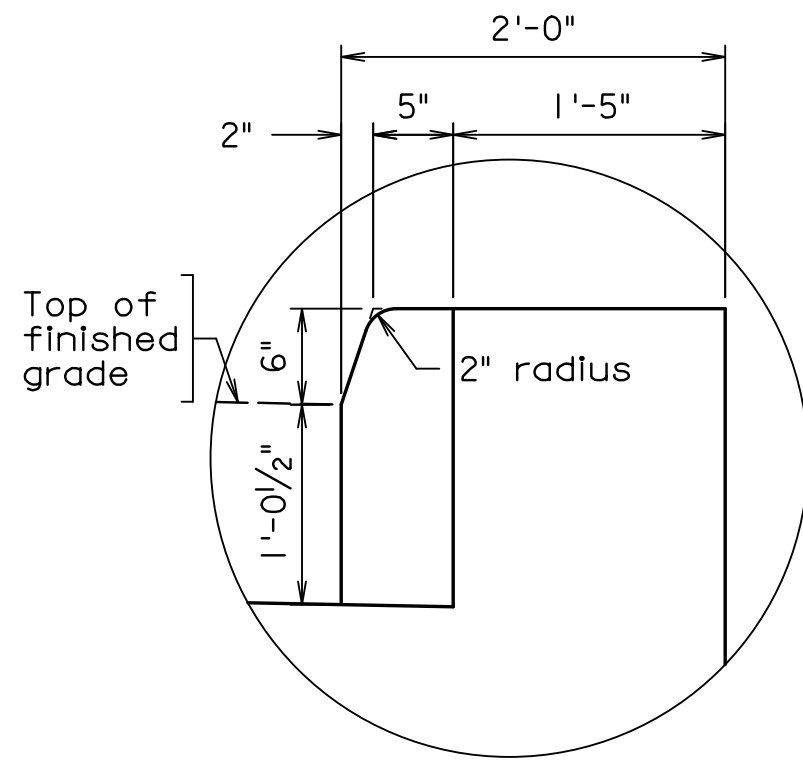
SECTION C-C  
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SECTION D-D  
Scale: 3/8" = 1'-0"



DETAIL A  
Scale: 1" = 1'-0"



DETAIL B  
Scale: 1" = 1'-0"

Notes:

Tie strip length and spacing to be provided by MSE Wall fabricator to resist a design lateral force of 2.2 kips per linear foot of abutment for Tie Strip Line 1 and 2.4 kips per linear foot of abutment for Tie Strip Line 2. Tie strip lines shall be located 1'-9" and 4'-9" above bottom of footing (+/- 3") for Tie Strip Lines 1 and 2 respectively.

Top of backwall below deck slab extension shall be finished to match local grade profile.

For Footing plan, see sheet 6(5).

For wingwall details, see sheet 6(5).

A 1" preformed joint filler shall be placed vertically between deck slab extension and wingwall.

The 1/2" expanded rubber joint filler shall extend the full length of the deck slab extension on top of the backwall.

The cost of preformed and expanded rubber joint fillers shall be incidental to Class A3 concrete.

For architectural treatment, see sheet 6(15).

PREFINAL PLANS

EMERGENCY POLICE - FIRE - RESCUE 911			
FAIRFAX COUNTY, VIRGINIA			
DEPARTMENT OF PUBLIC WORKS AND ENVIRONMENTAL SERVICES			
12000 GOVERNMENT CENTER PARKWAY, SUITE 449 FAIRFAX, VA., 22035-0052			
OFFICE OF CAPITAL FACILITIES 703-324-5800			
WIEHLE AVENUE (RTE 828) AT W&OD TRAIL			
ABUTMENT A PLAN & ELEVATION			
PROJECT NO: 1400102-2013			
PLAN NO.	DESIGNED: JRM	SHEET	
XXX-XX	DRAFTED: CRR	6(4)	
APPROVED BY THE TRANSPORTATION DESIGN DIVISION		CHECKED: TAB	

WHITMAN REQUARDT & ASSOCIATES  
RICHMOND, VA  
STRUCTURAL ENGINEER

DATE

APPROVED

BY

DESCRIPTION

Δ#


FUND # 500-C5000




PROJECT MANAGER: SCOTT, BUFFNER, P.E. (703) 877-5736  
SURVEYED BY: DATE: FAIRFAX COUNTY  
DESIGN BY: WHITMAN, REQUARDT & ASSOCIATES, LLP (703) 293-9717  
SUBSURFACE UTILITY BY: DATE: SO DEEP, INC. (703) 361-6005 December 23, 2014

STATE	ROUTE	FEDERAL AID	ROUTE	STATE
		PROJECT		
VA.			828	0828-029-248, B-601

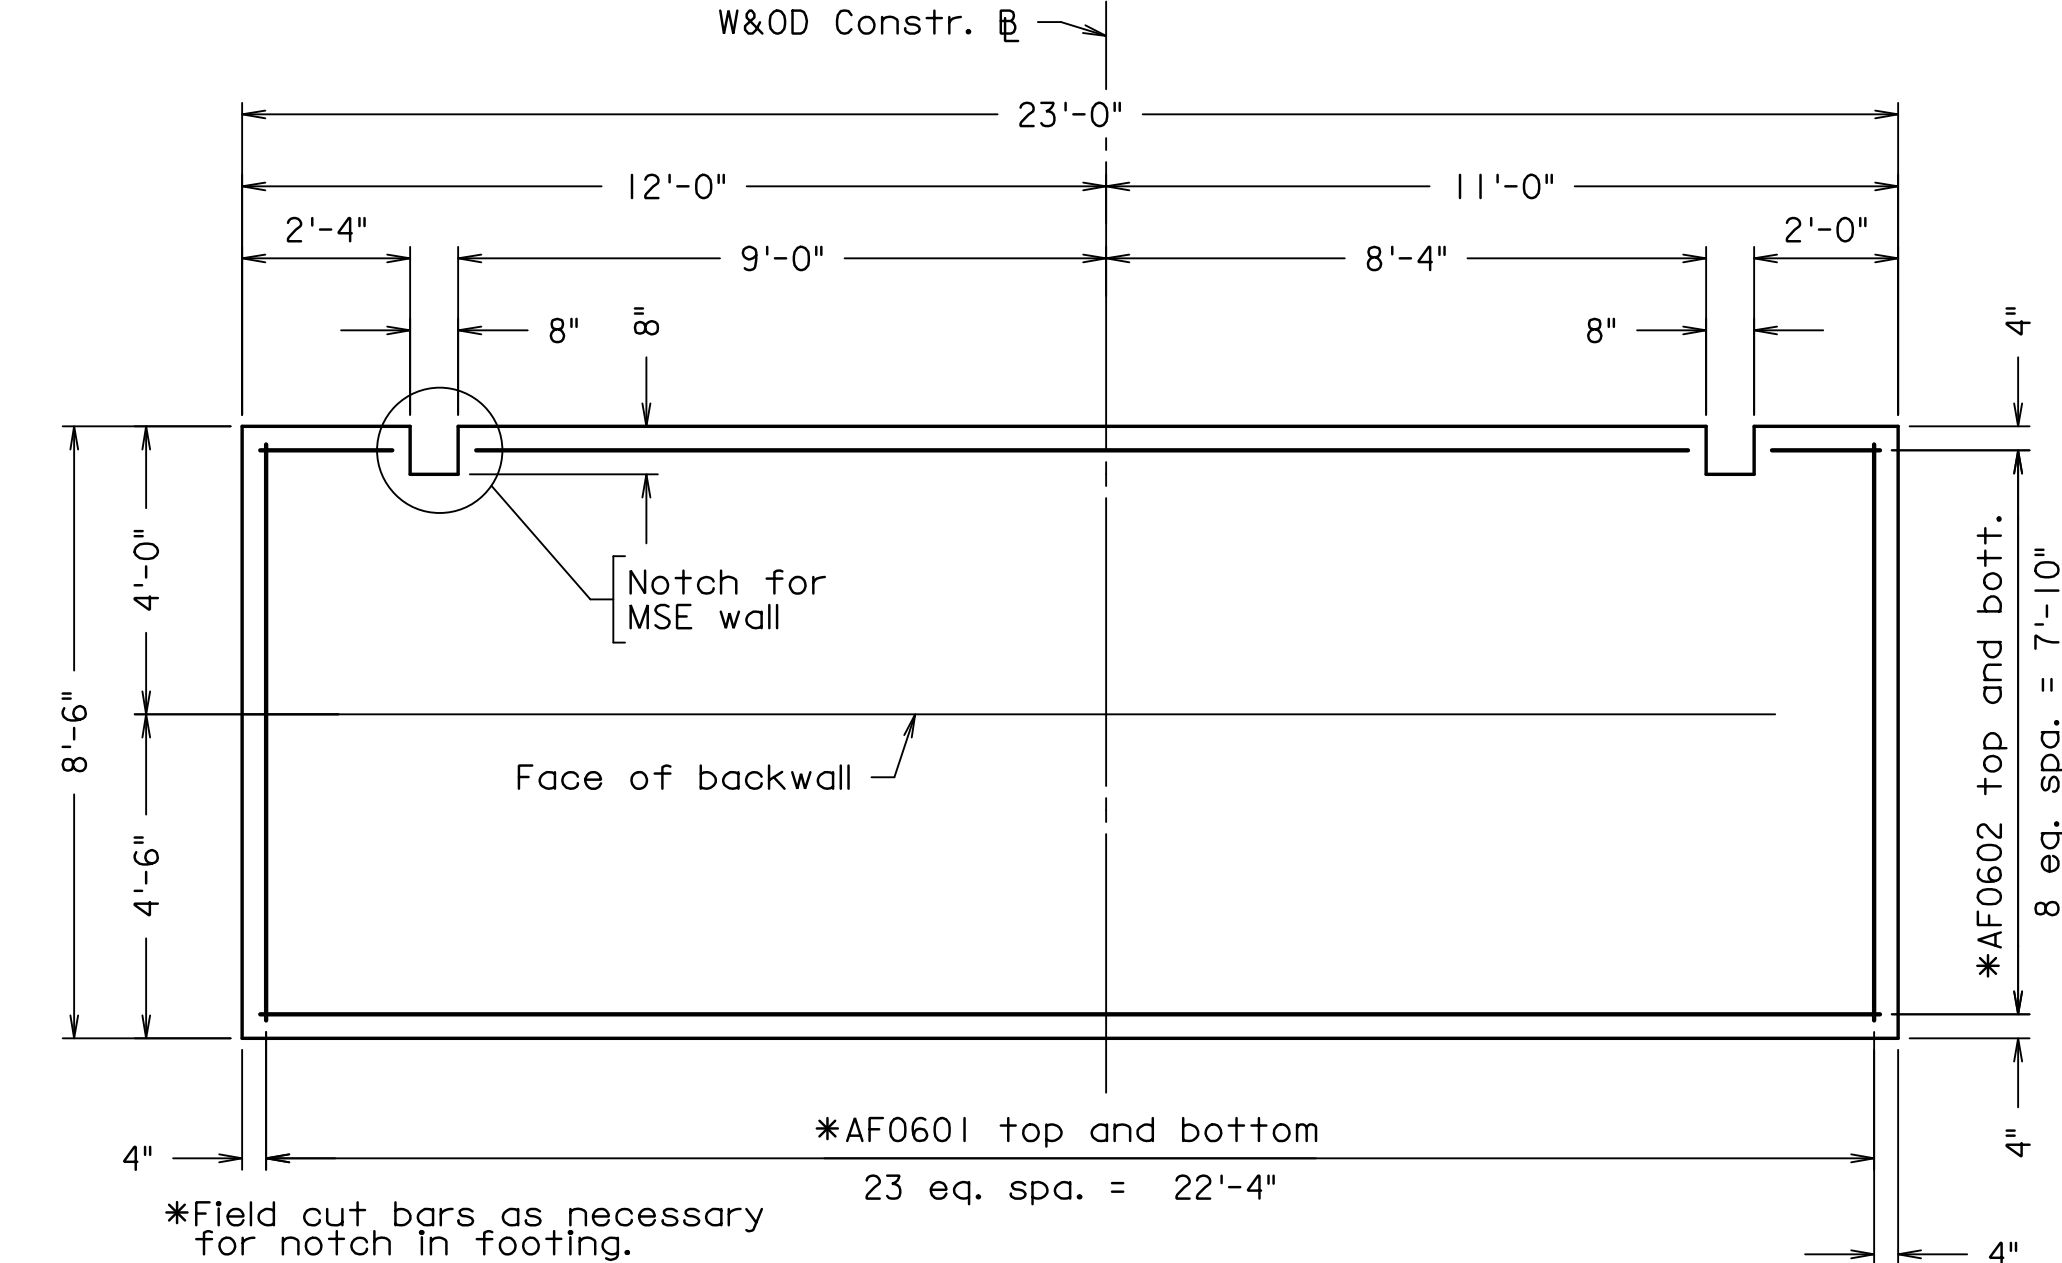
Notes:  
For abutment notes, see sheet 6(4).  
For Substructure Layout, see sheet 6(3).




FOOTING PLAN

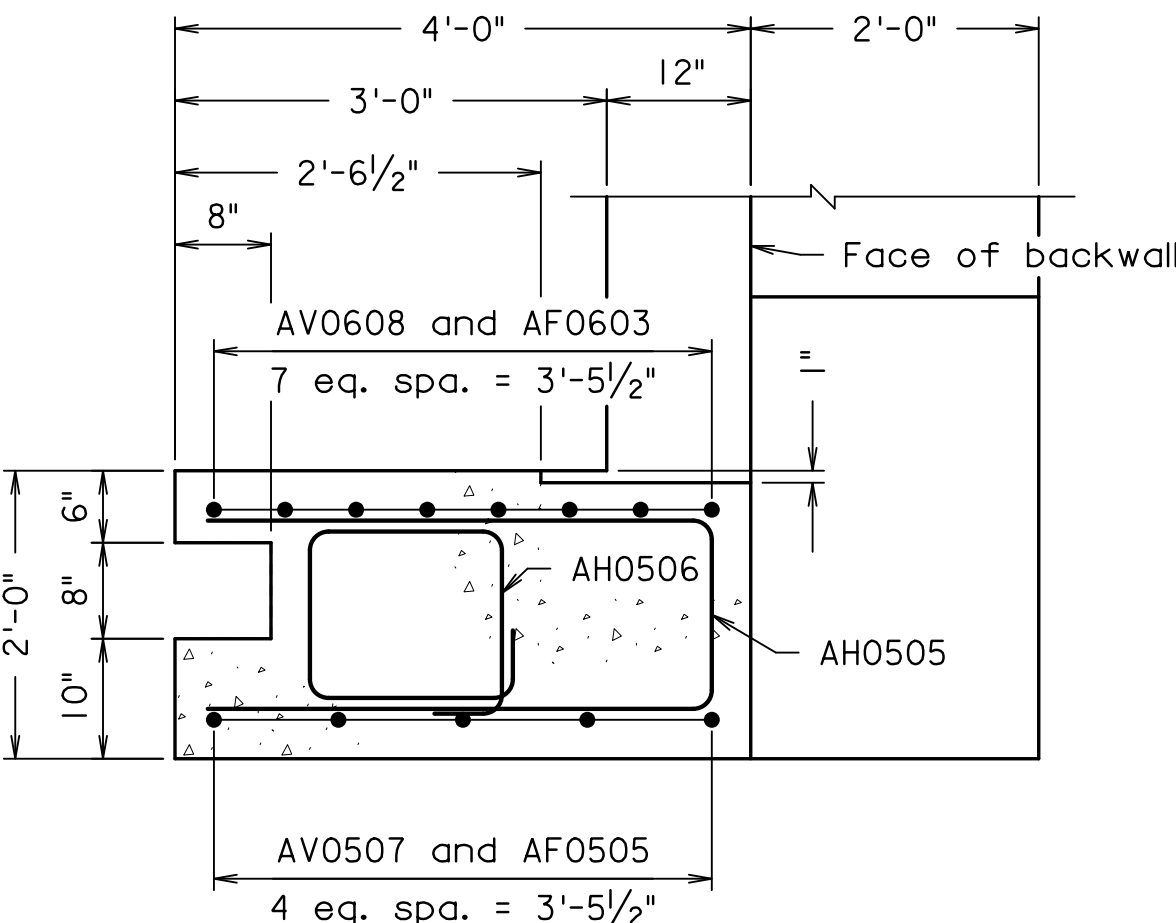


SECTION G-G

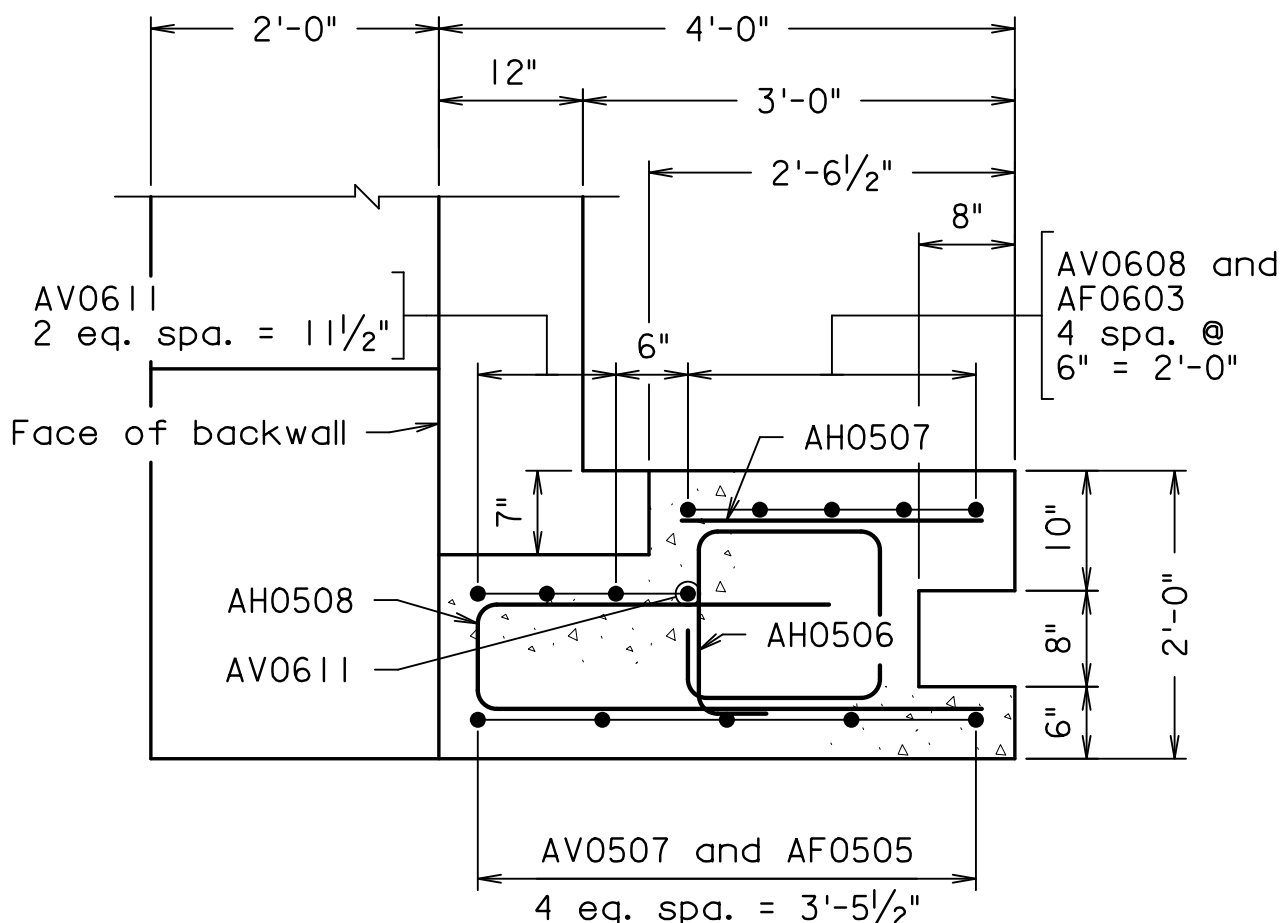

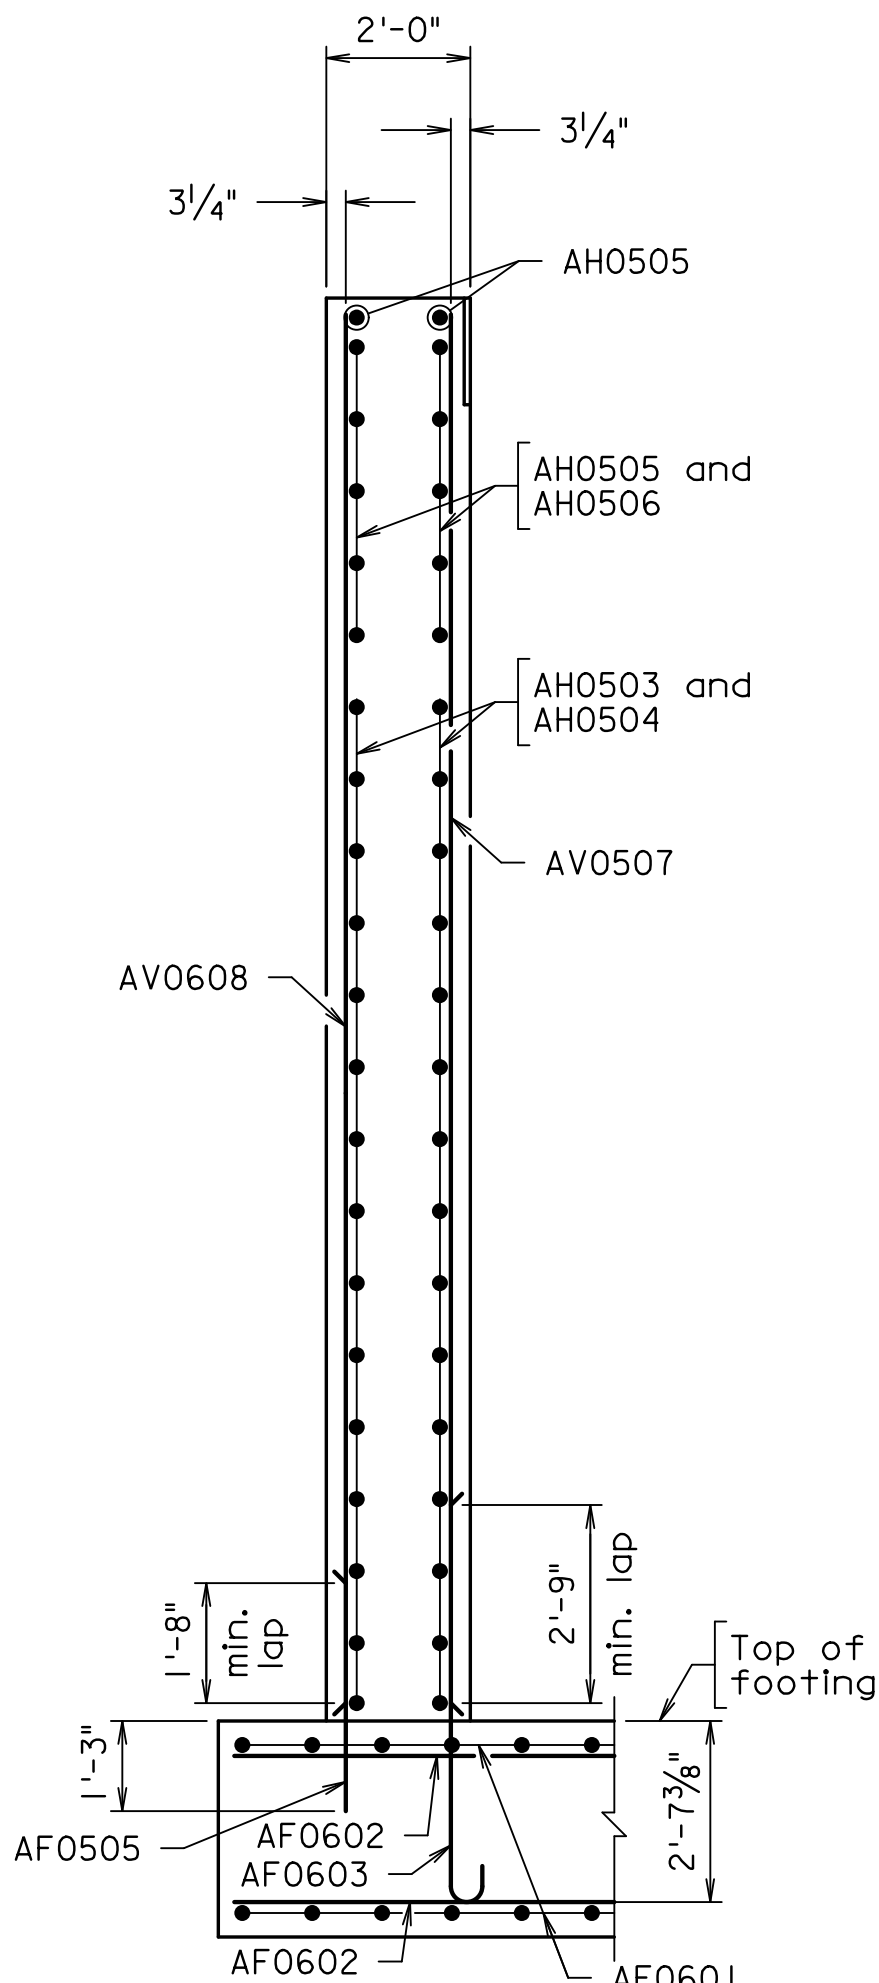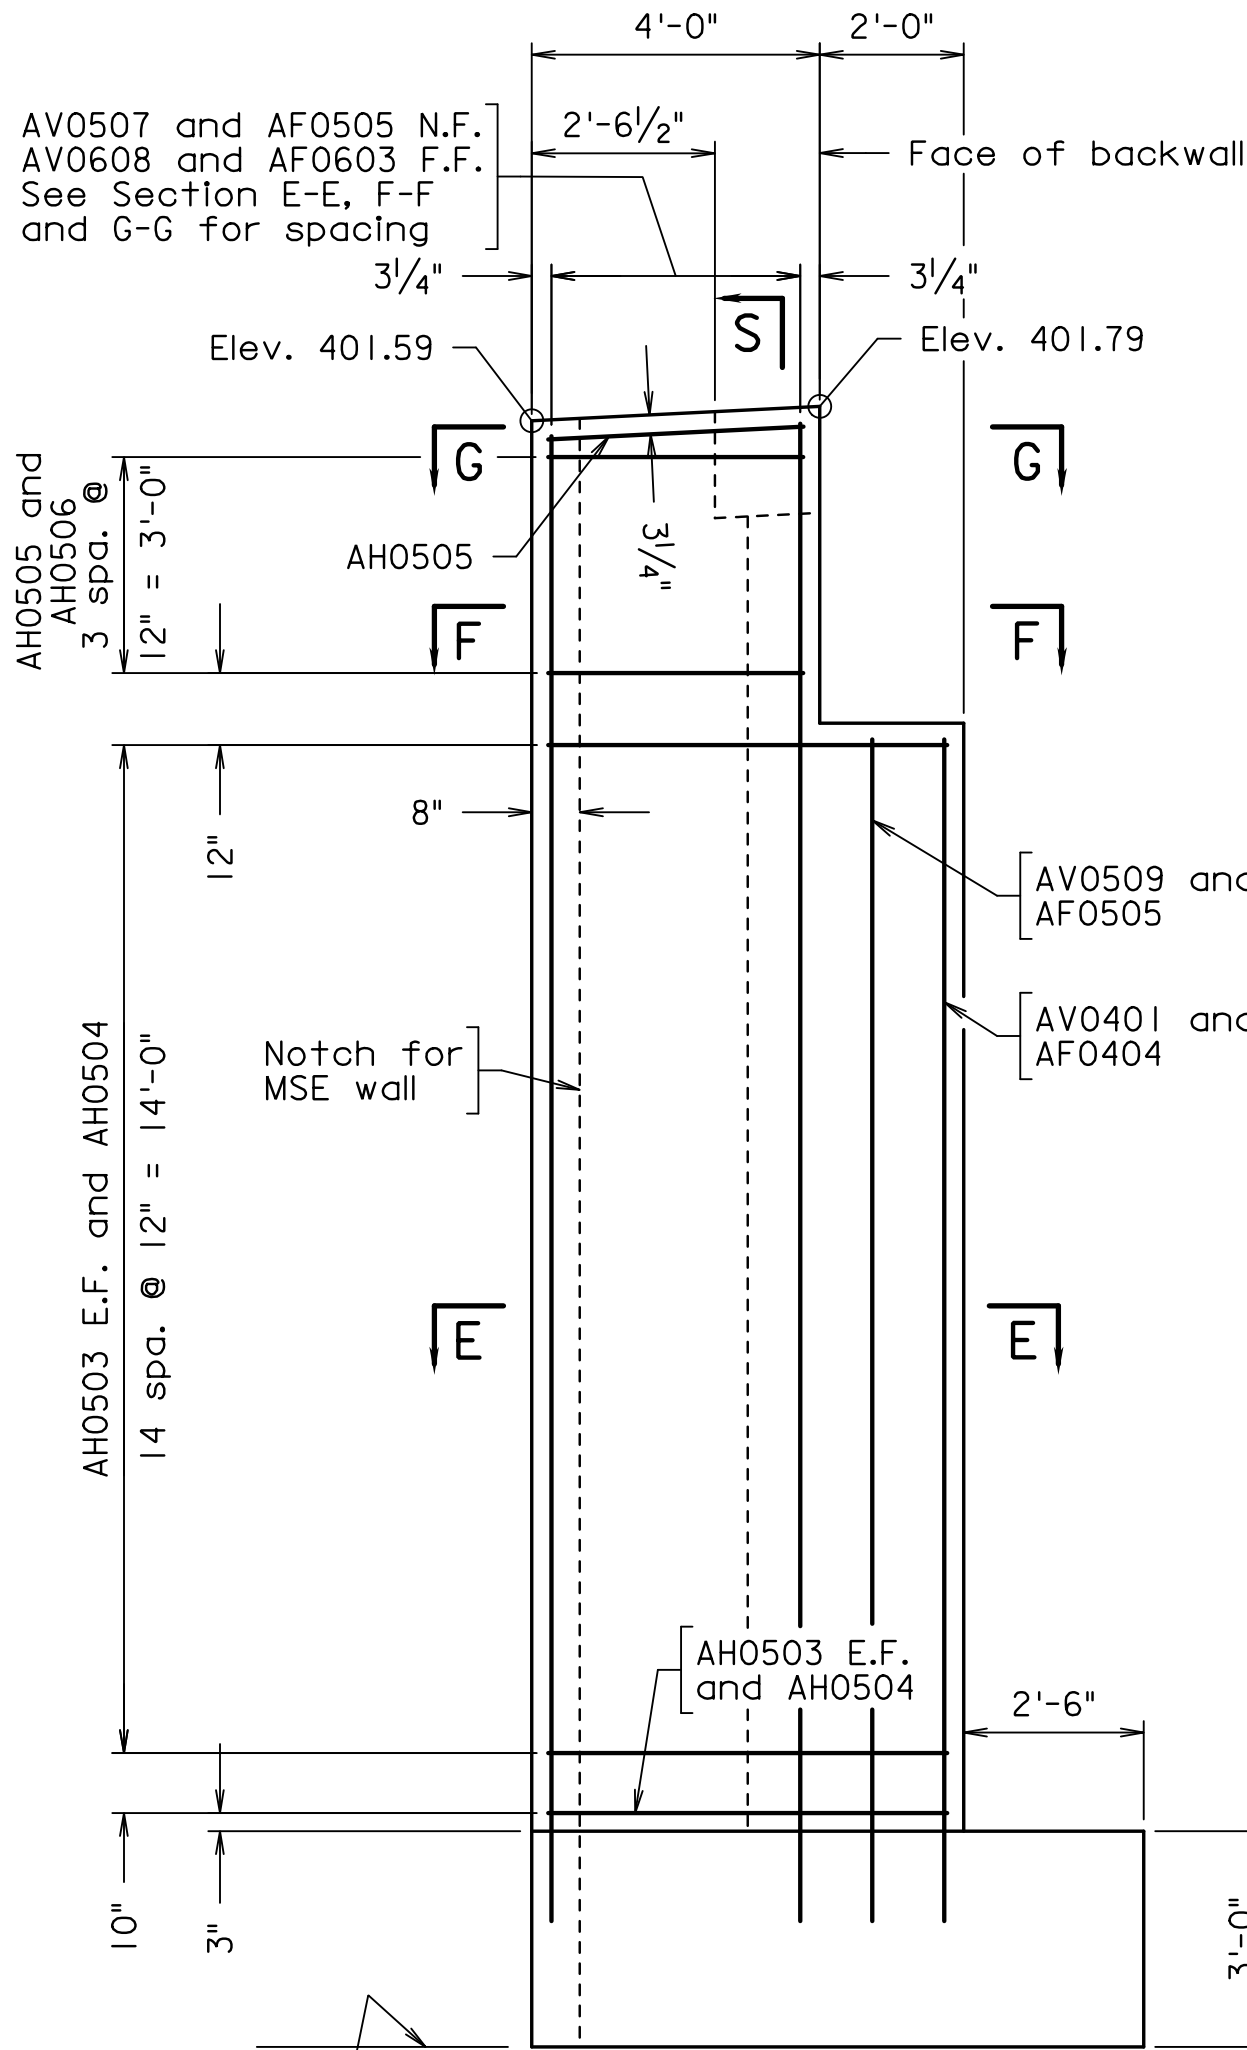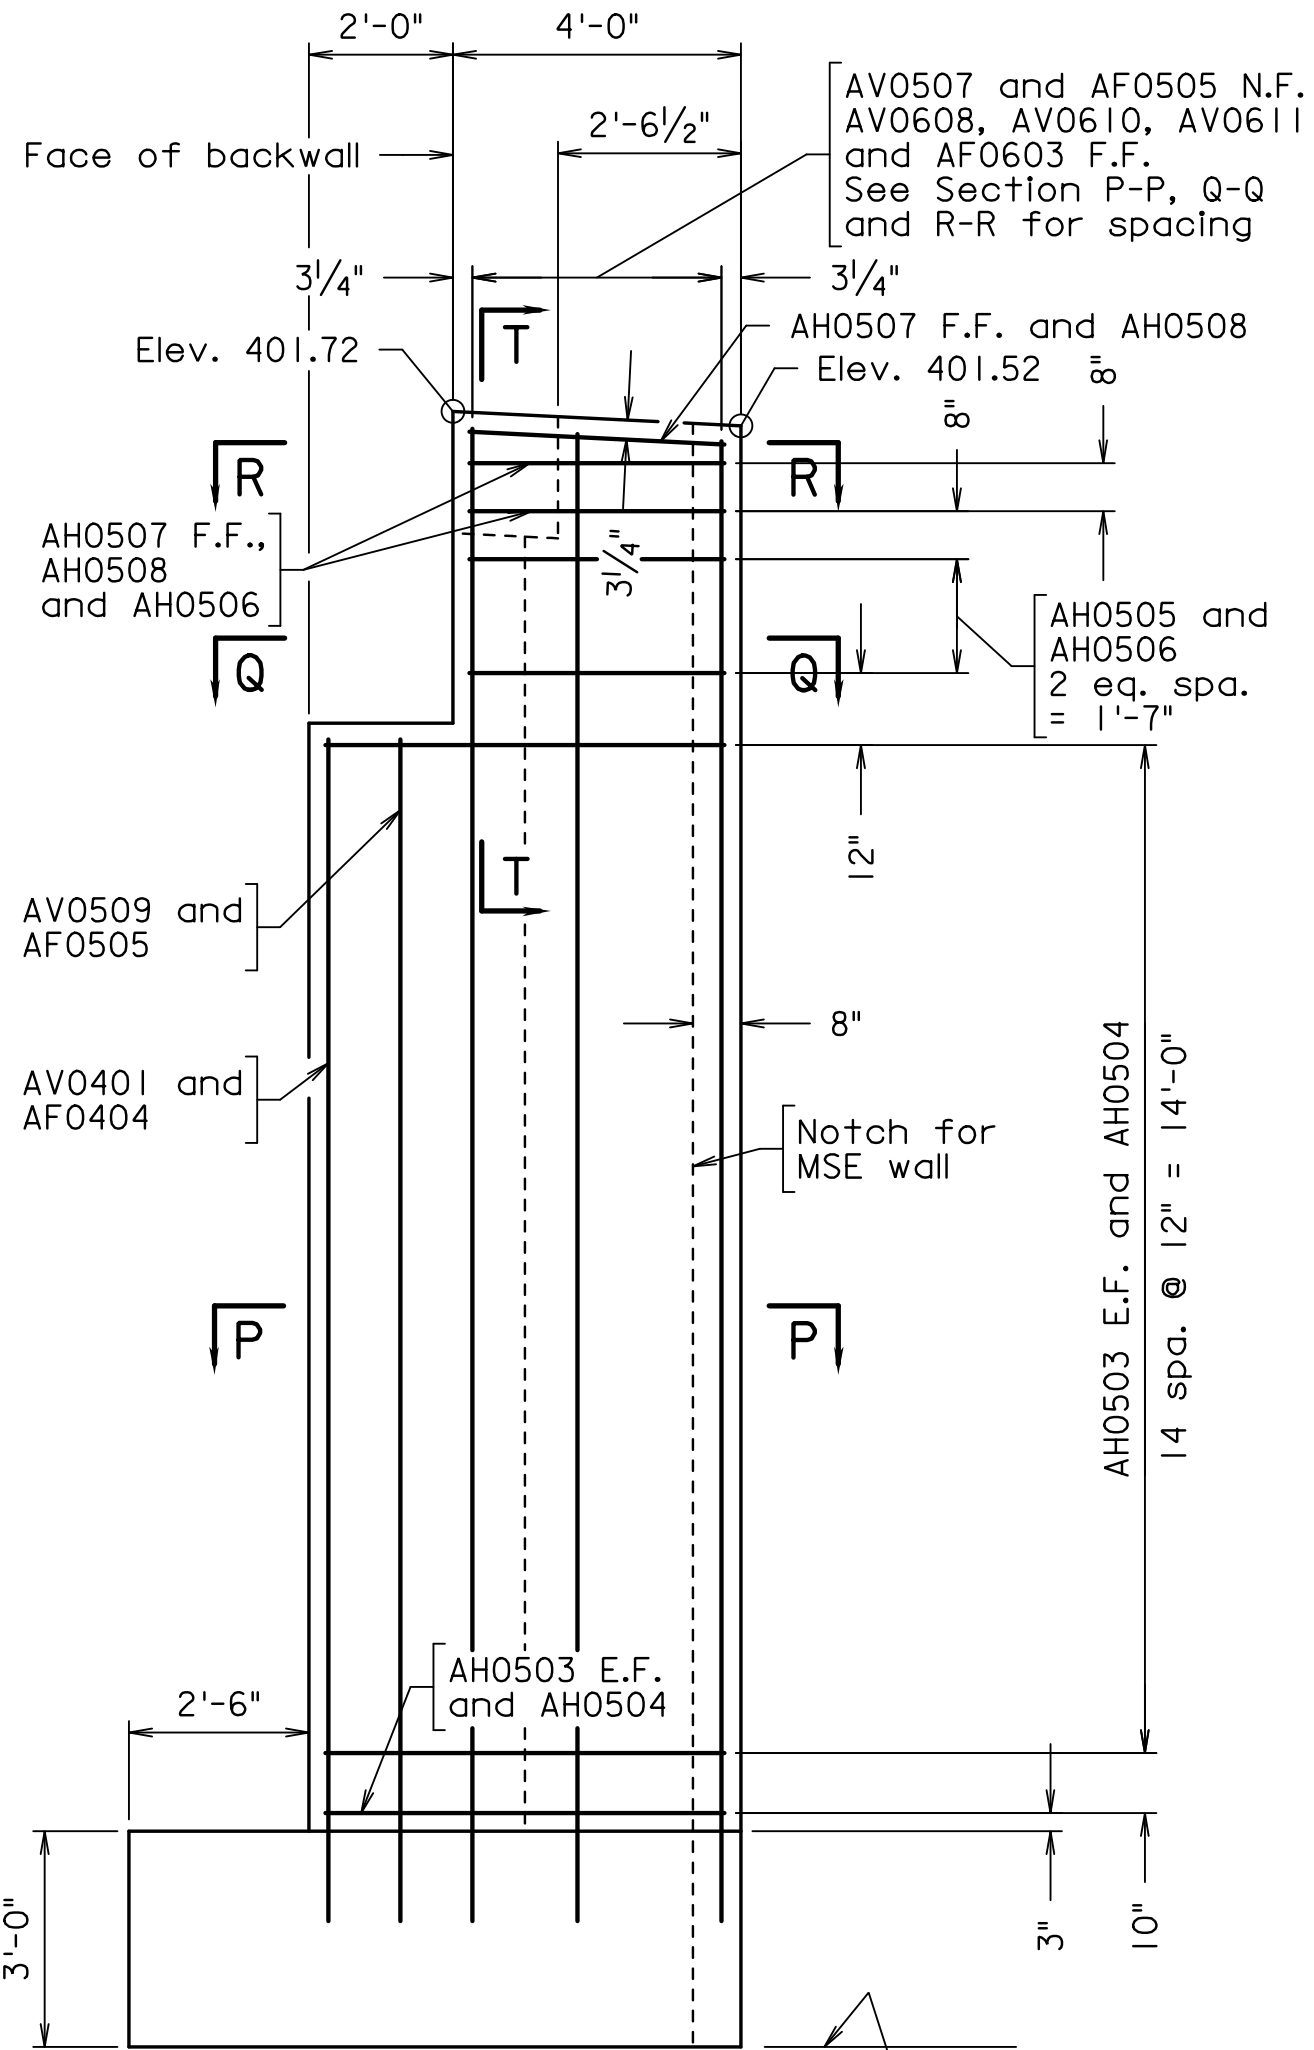
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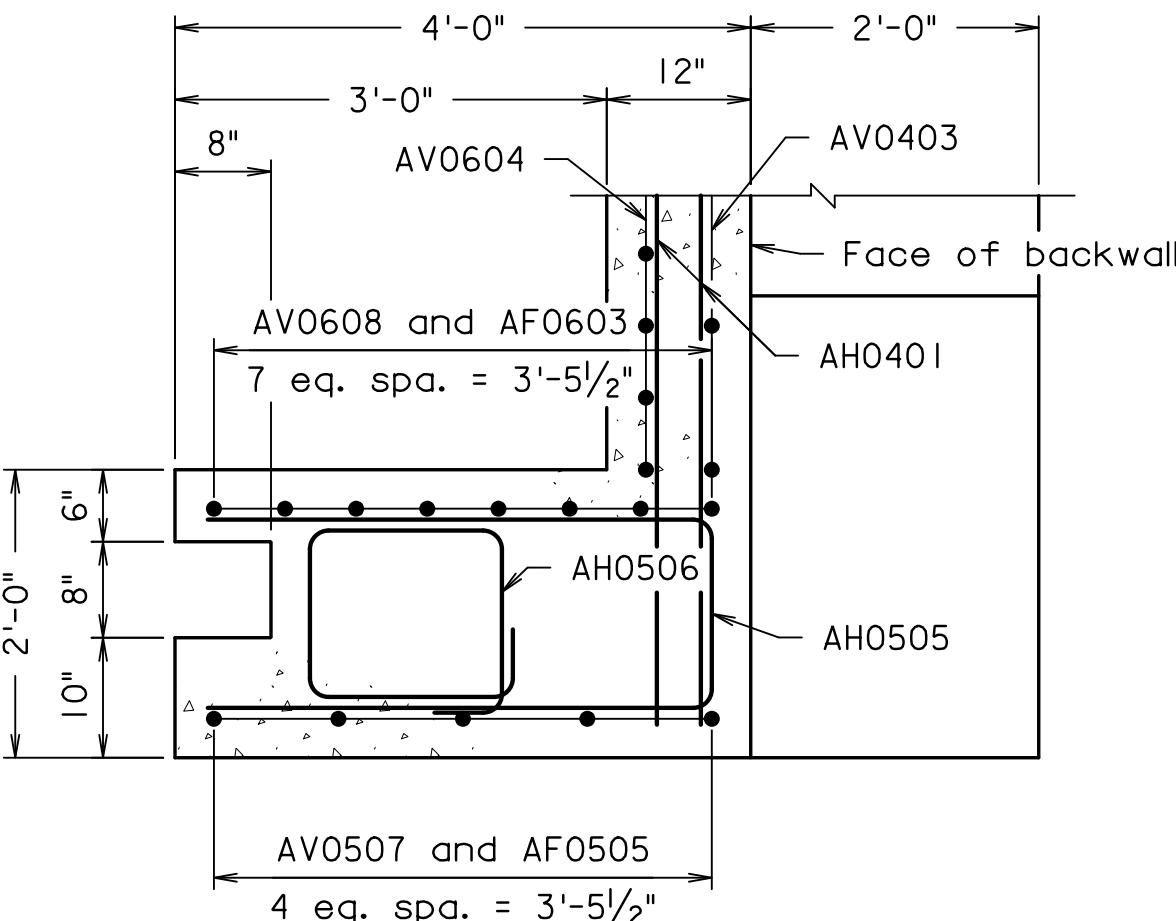
SECTION S-S



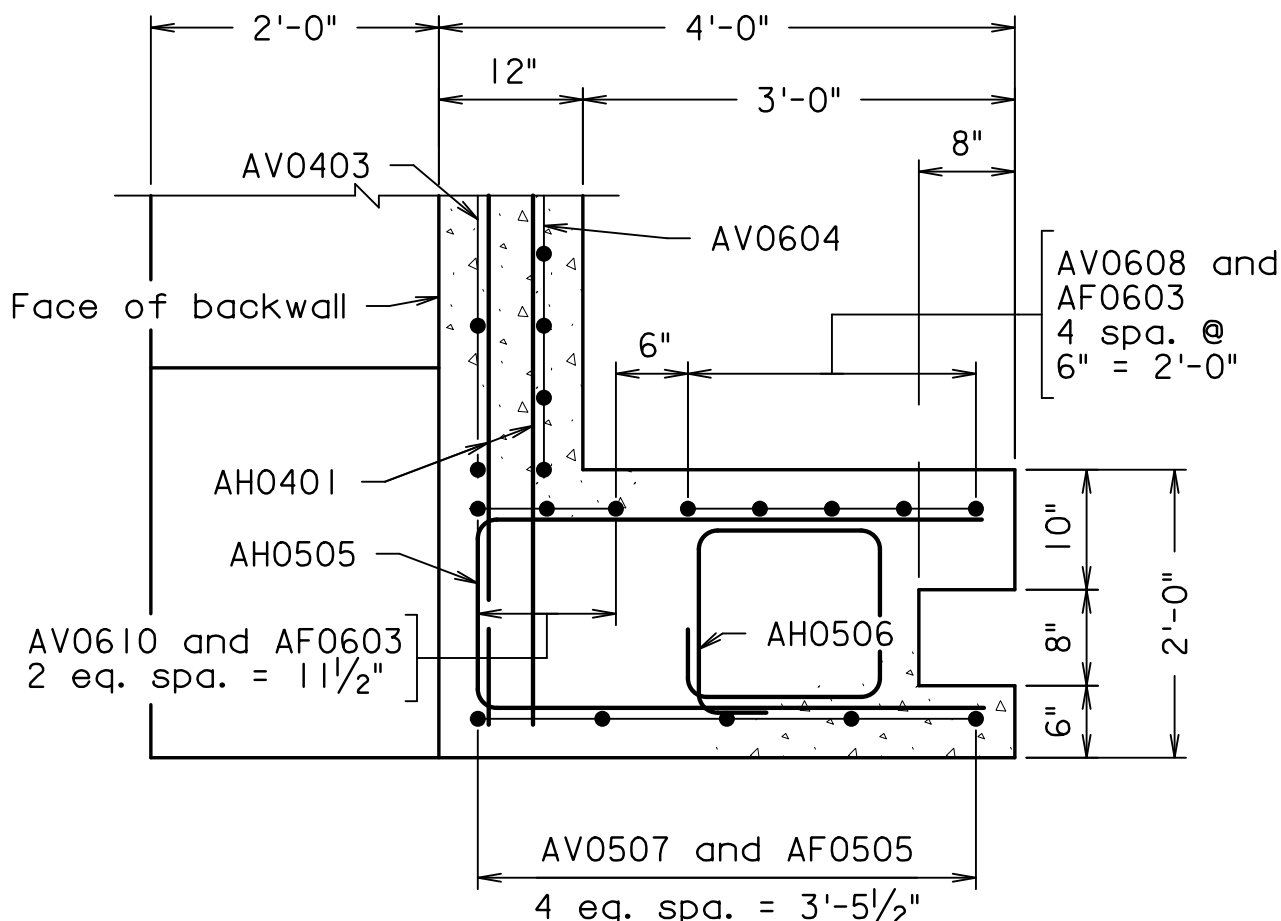
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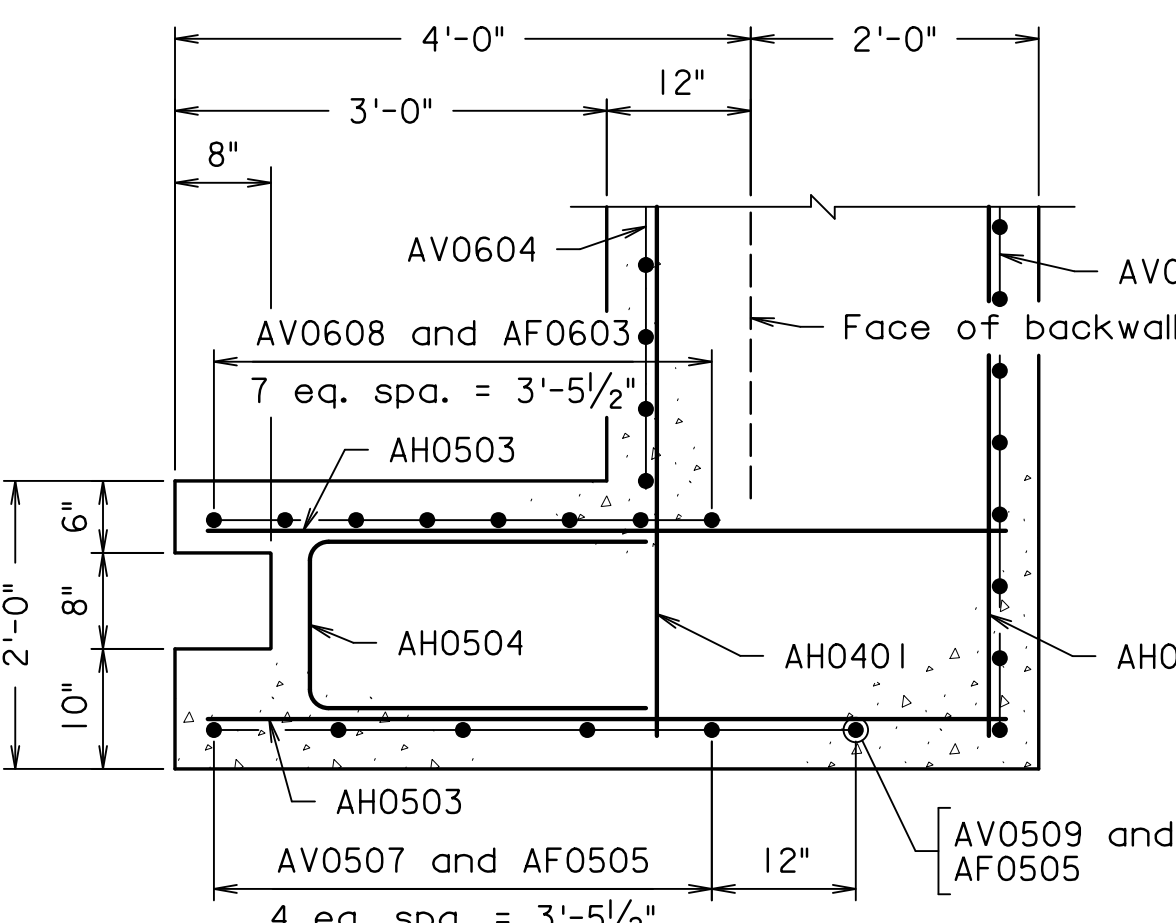
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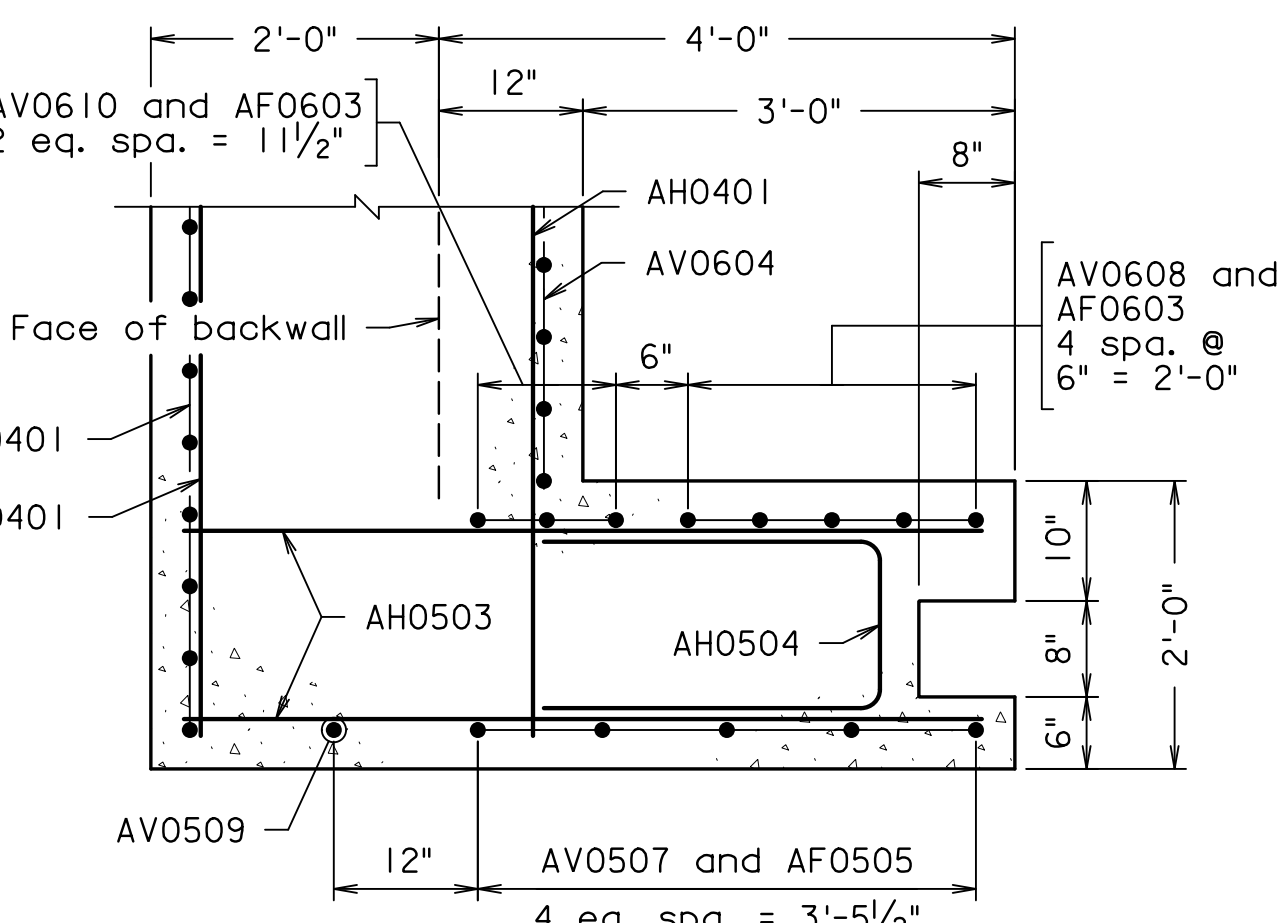
SECTION F-F




SECTION Q-Q



SECTION E-E



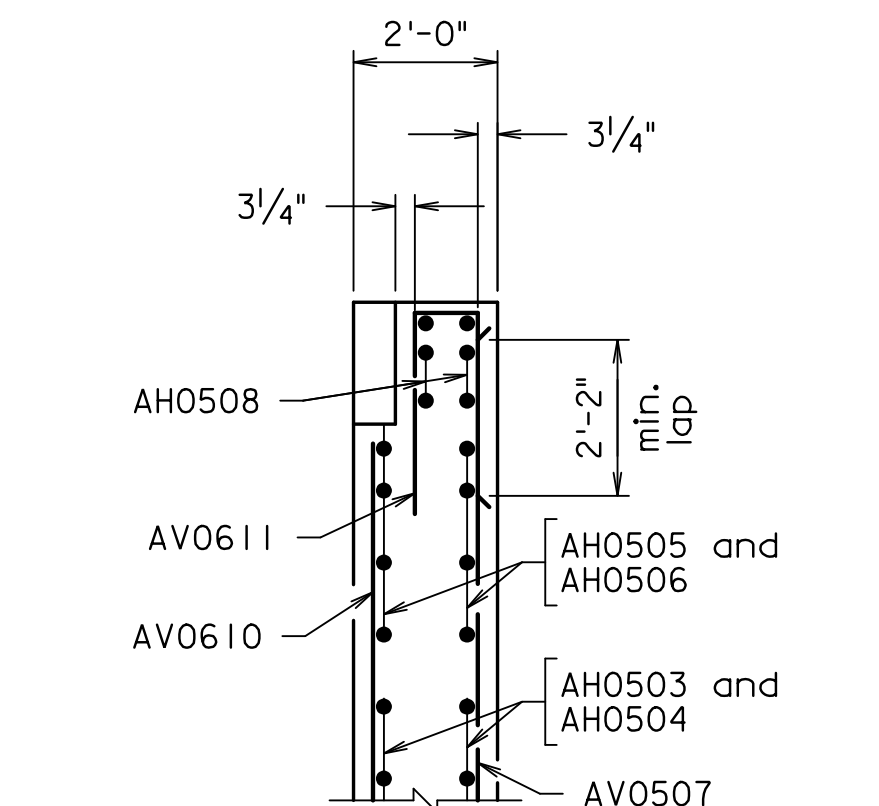SECTION P-P



SECTION T-T

For additional details see Section S-S.

PREFINAL PLANS


EMERGENCY POLICE - FIRE - RESCUE 911			
FAIRFAX COUNTY, VIRGINIA			
DEPARTMENT OF PUBLIC WORKS AND ENVIRONMENTAL SERVICES			
12000 GOVERNMENT CENTER PARKWAY, SUITE 449 FAIRFAX, VA., 22035-0052			
OFFICE OF CAPITAL FACILITIES 703-324-5800			
WIEHLE AVENUE (RTE 828) AT W&OD TRAIL			
ABUTMENT A FOOTING PLAN & DETAILS			
PROJECT NO: 1400102-2013			
PLAN NO.	DESIGNED: JRM	SHEET	
XXX-XX	DRAFTED: CRR	6(5)	
CHECKED: TAB			
FUND # 500-C5000			

WHITMAN REQUARDT & ASSOCIATES RICHMOND, VA STRUCTURAL ENGINEER	DESCRIPTION	BY	APPROVED	DATE
APPROVED BY THE TRANSPORTATION DESIGN DIVISION				


THESE PLANS ARE UNFINISHED AND UNAPPROVED AND ARE NOT TO BE USED FOR ANY TYPE OF CONSTRUCTION.



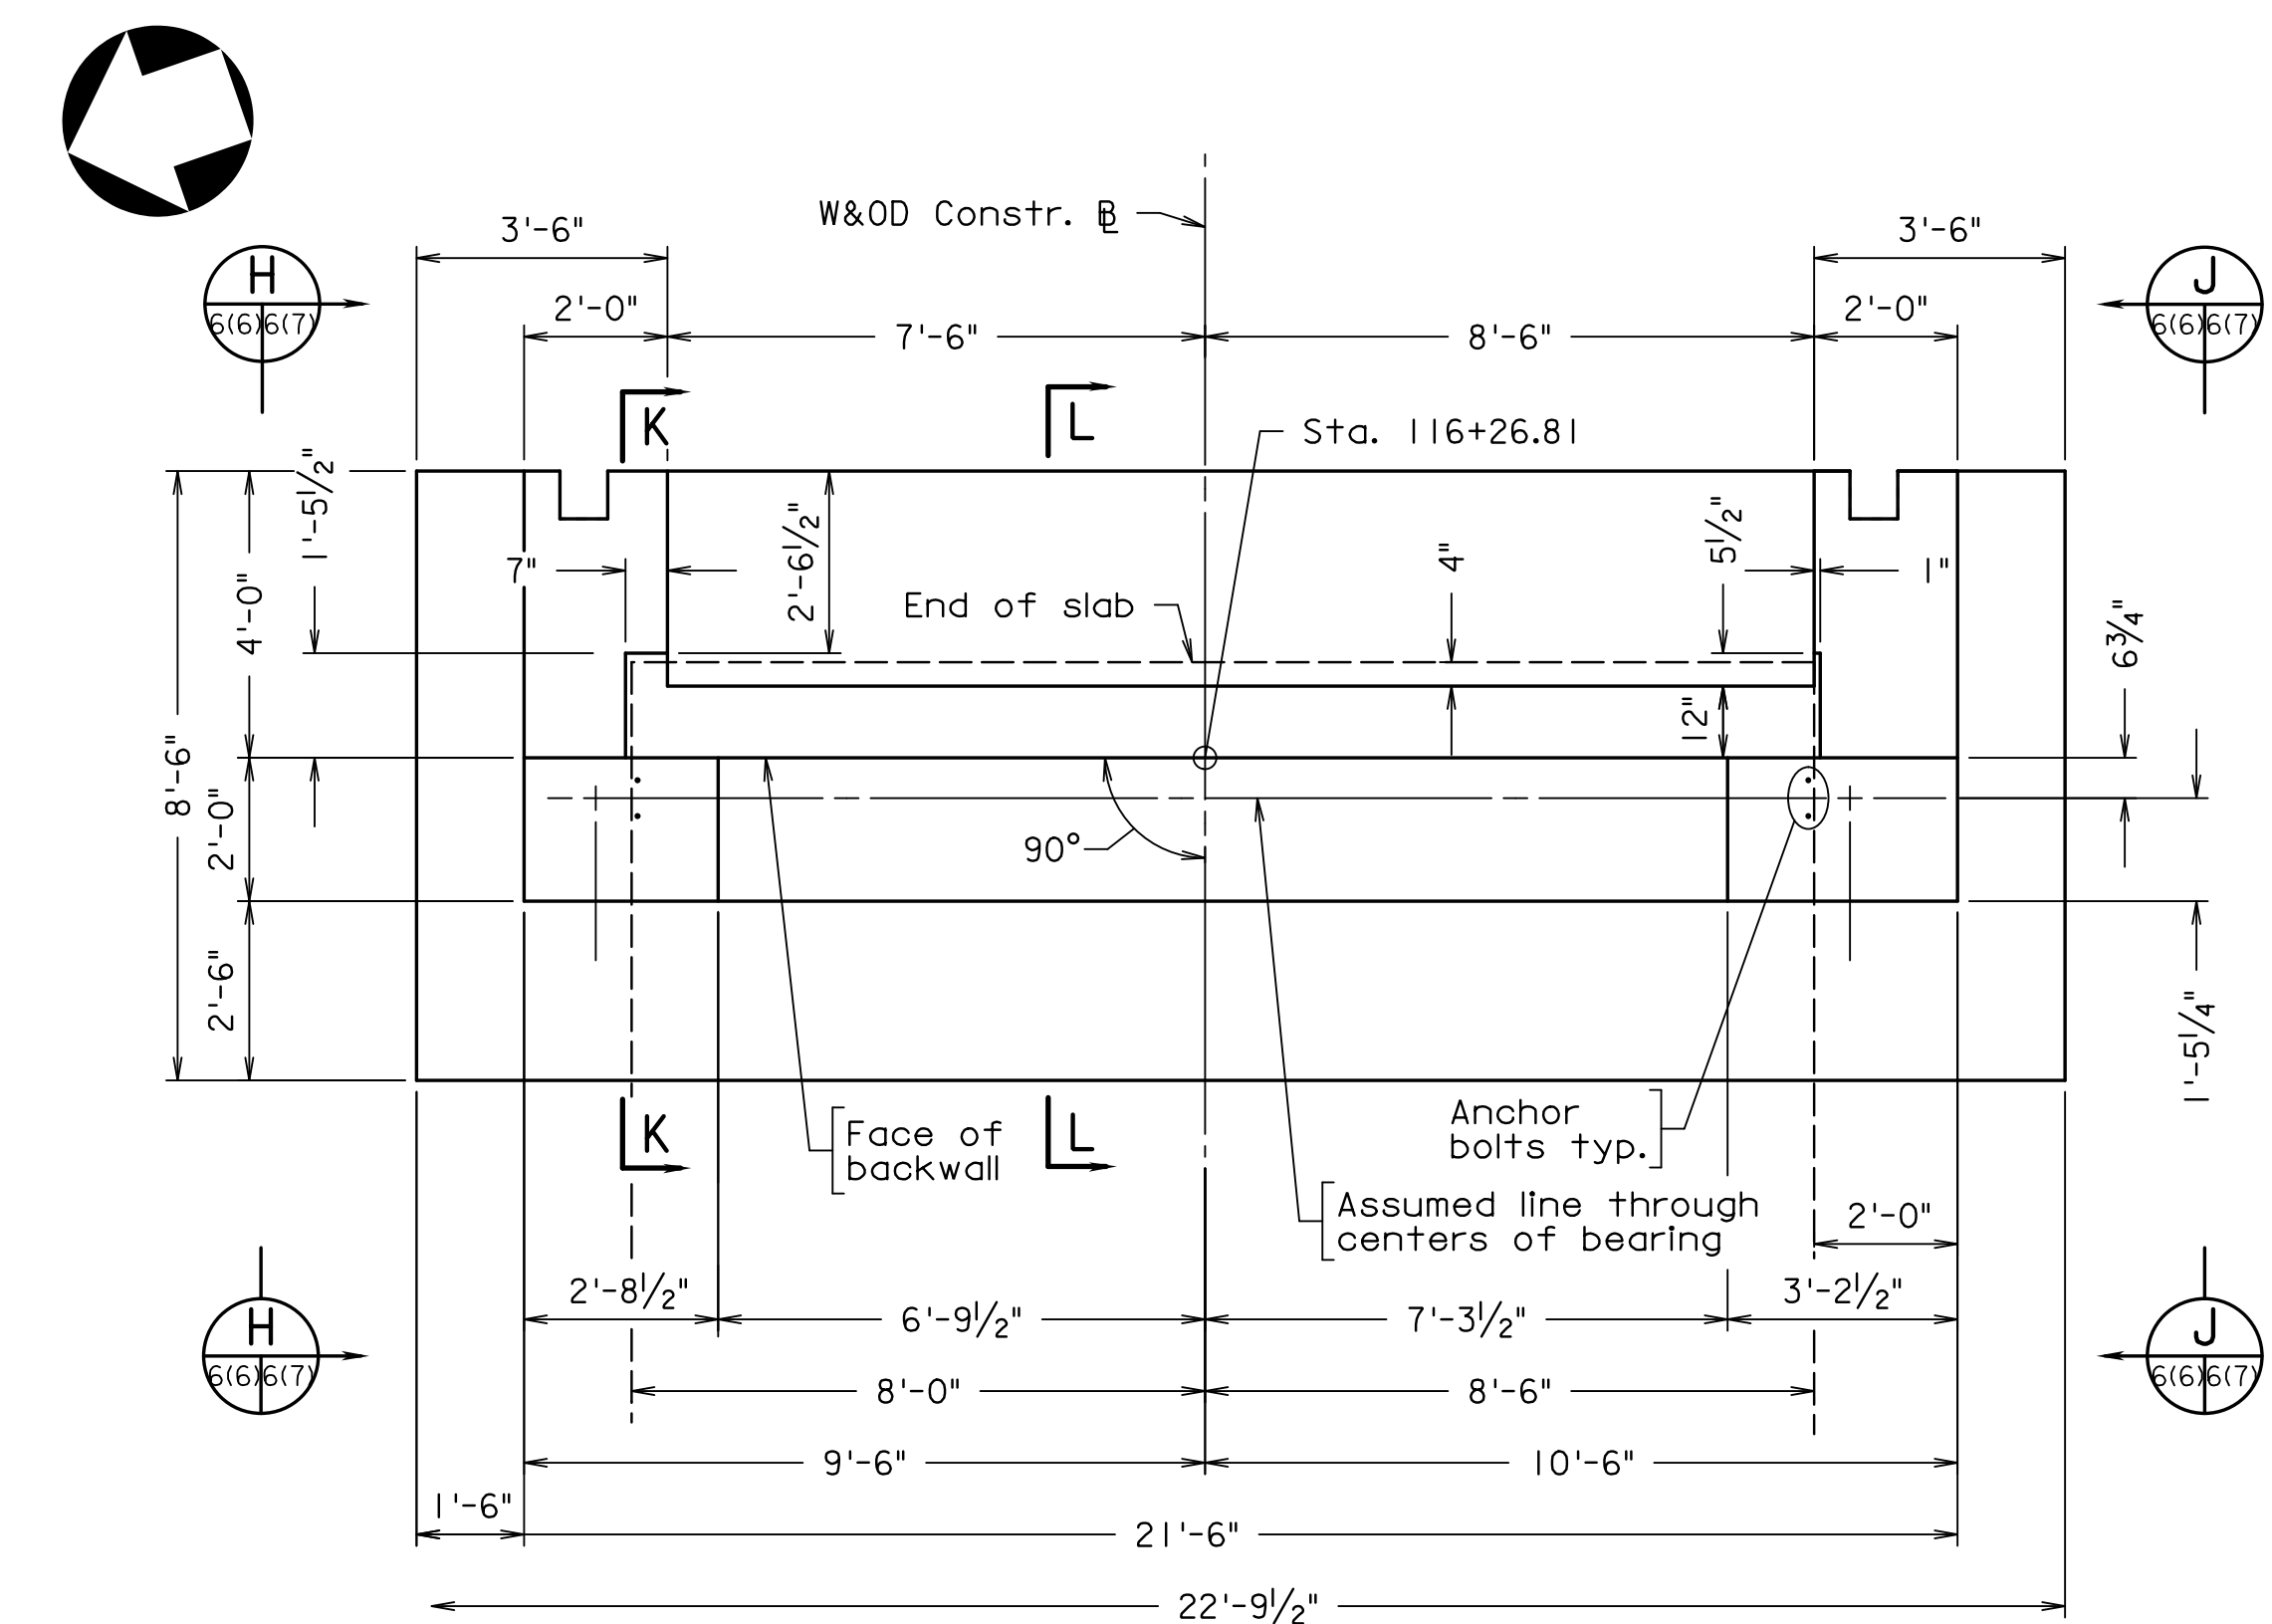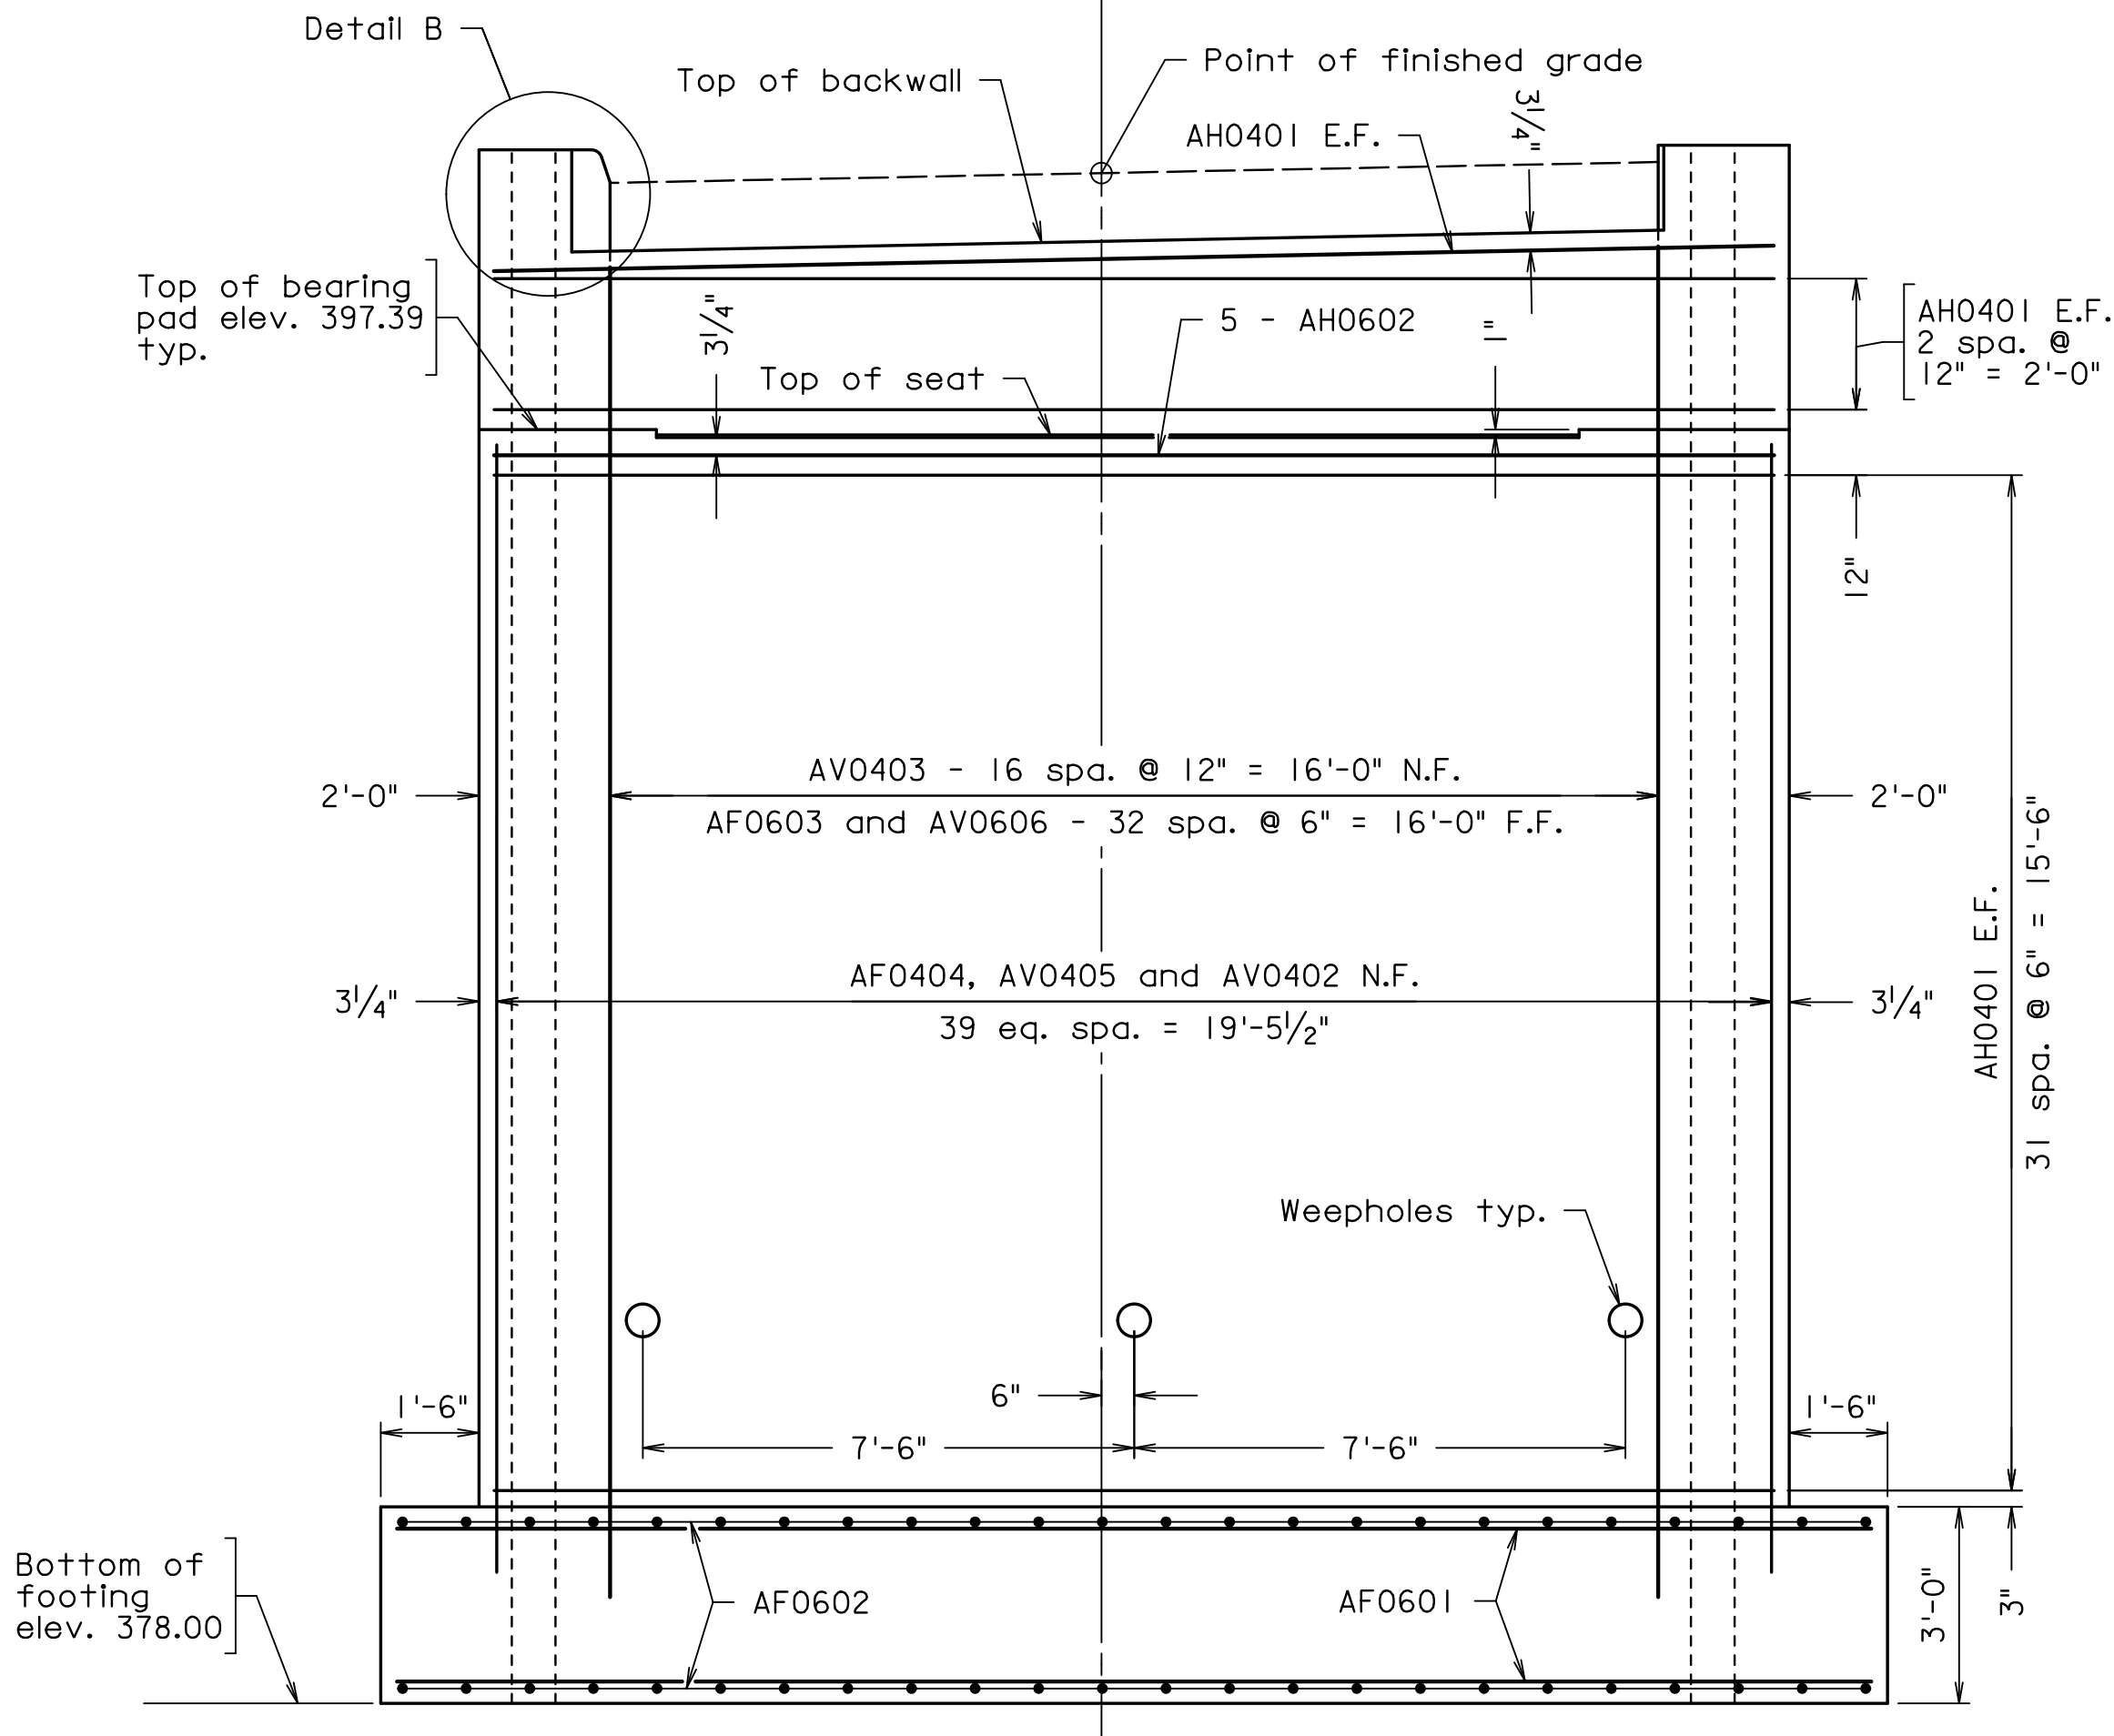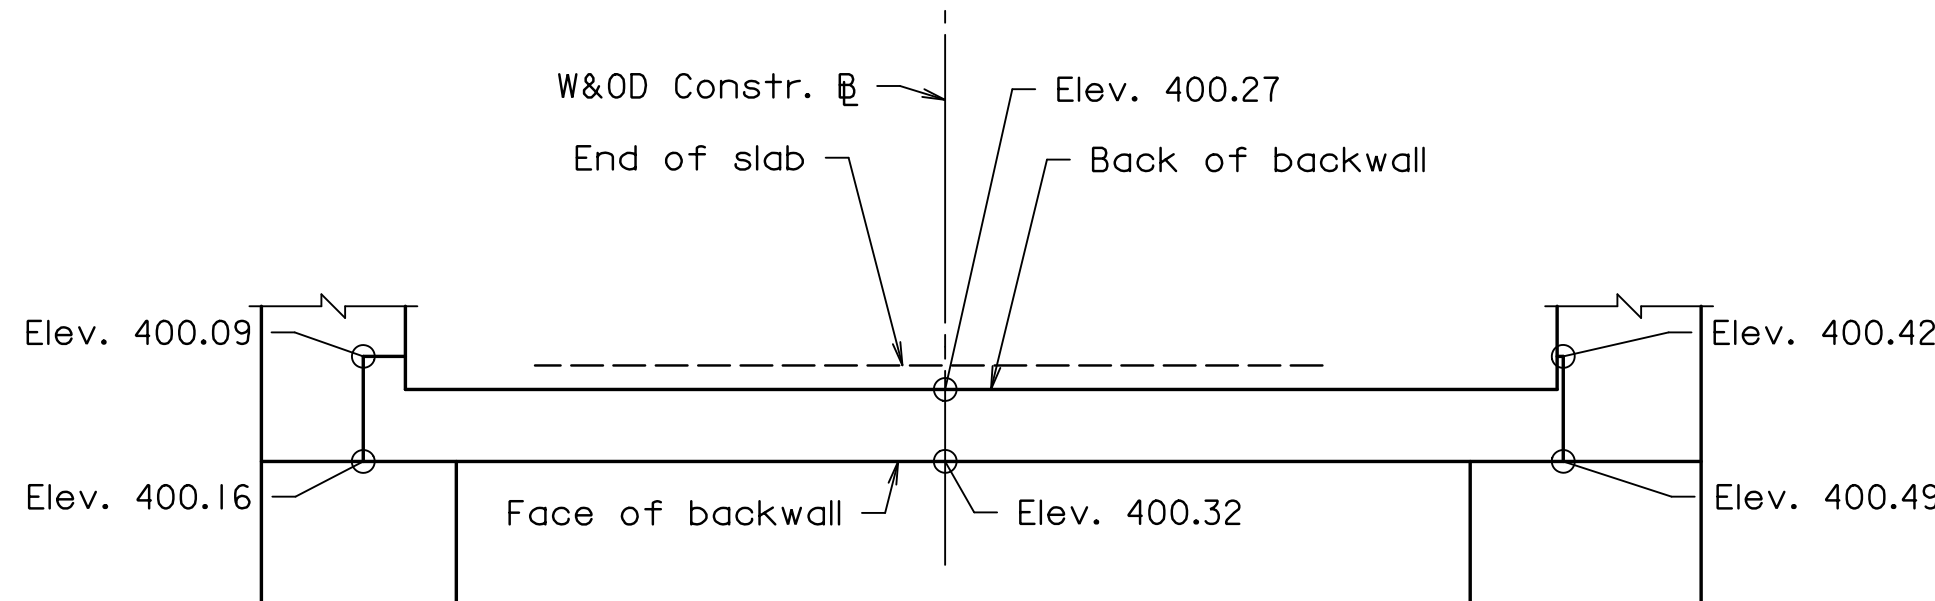
PROJECT MANAGER: SCOTT, BUFFNER, P.E. (703) 287-5236  
SURVEYED BY: DATE: FAIRFAX COUNTY  
DESIGN BY: WHITMAN, REQUARDT & ASSOCIATES, LLP (703) 293-9717  
SUBSURFACE UTILITY BY: DATE: SO DEEP, INC. (703) 361-6005 December 23, 2014



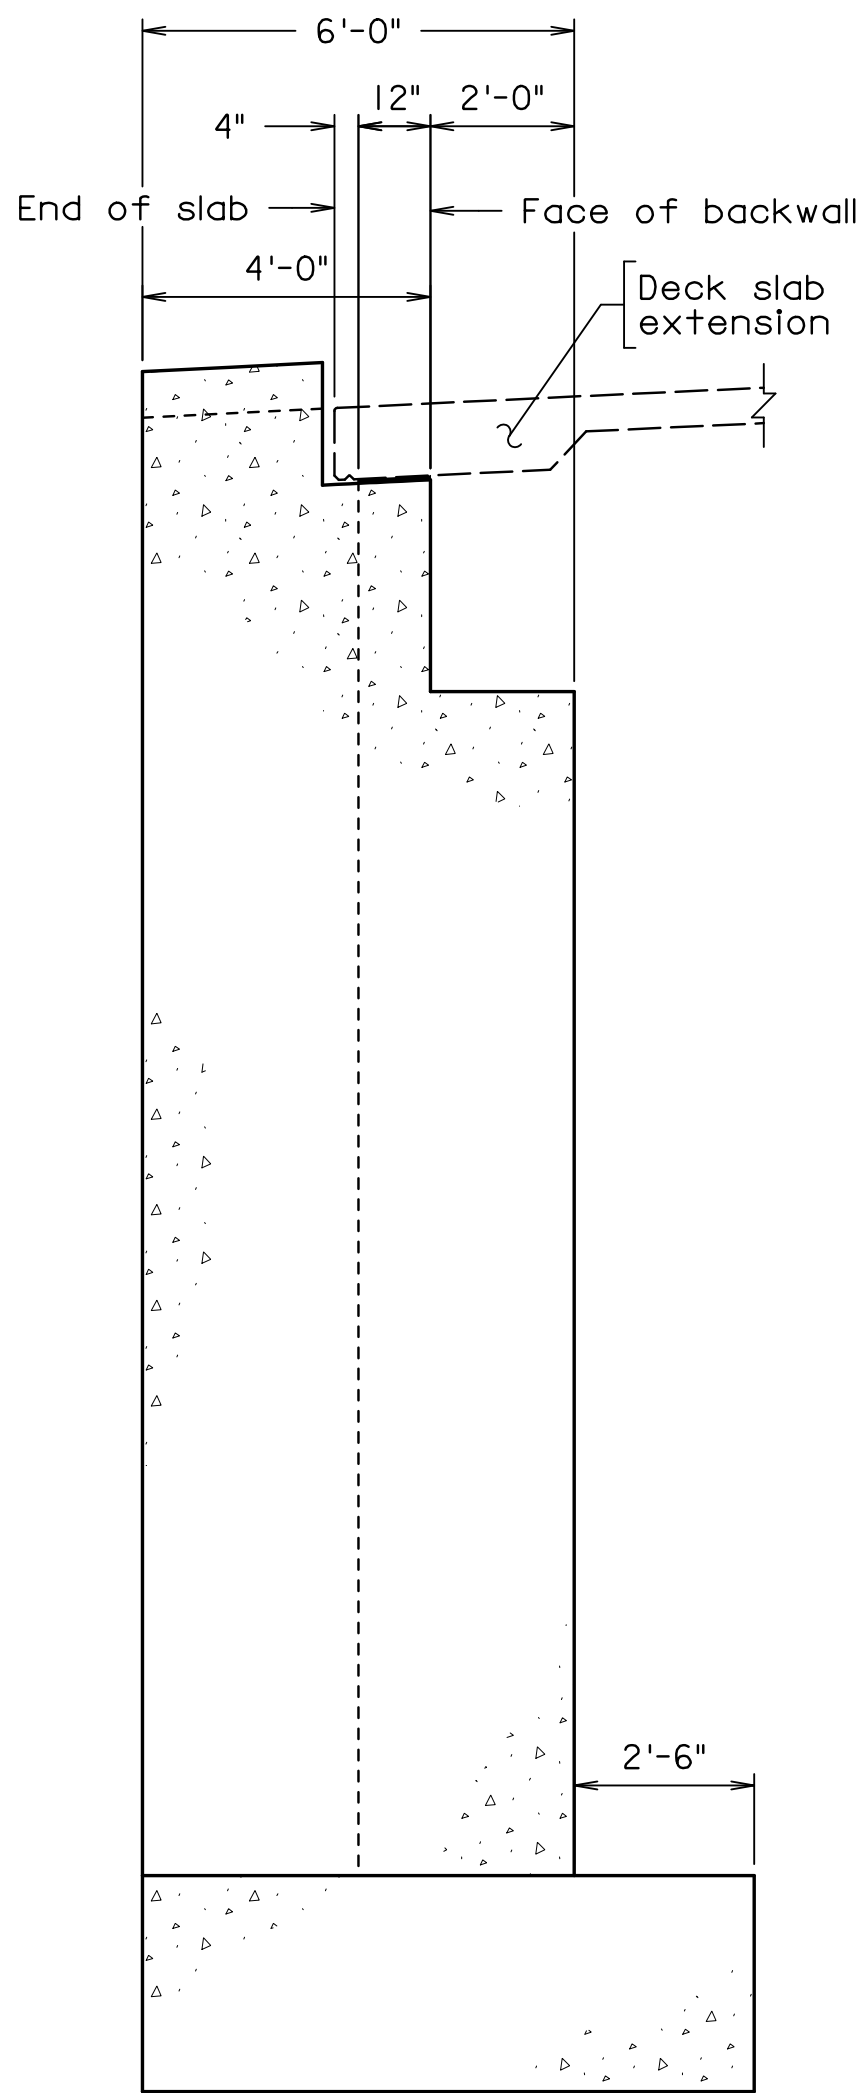
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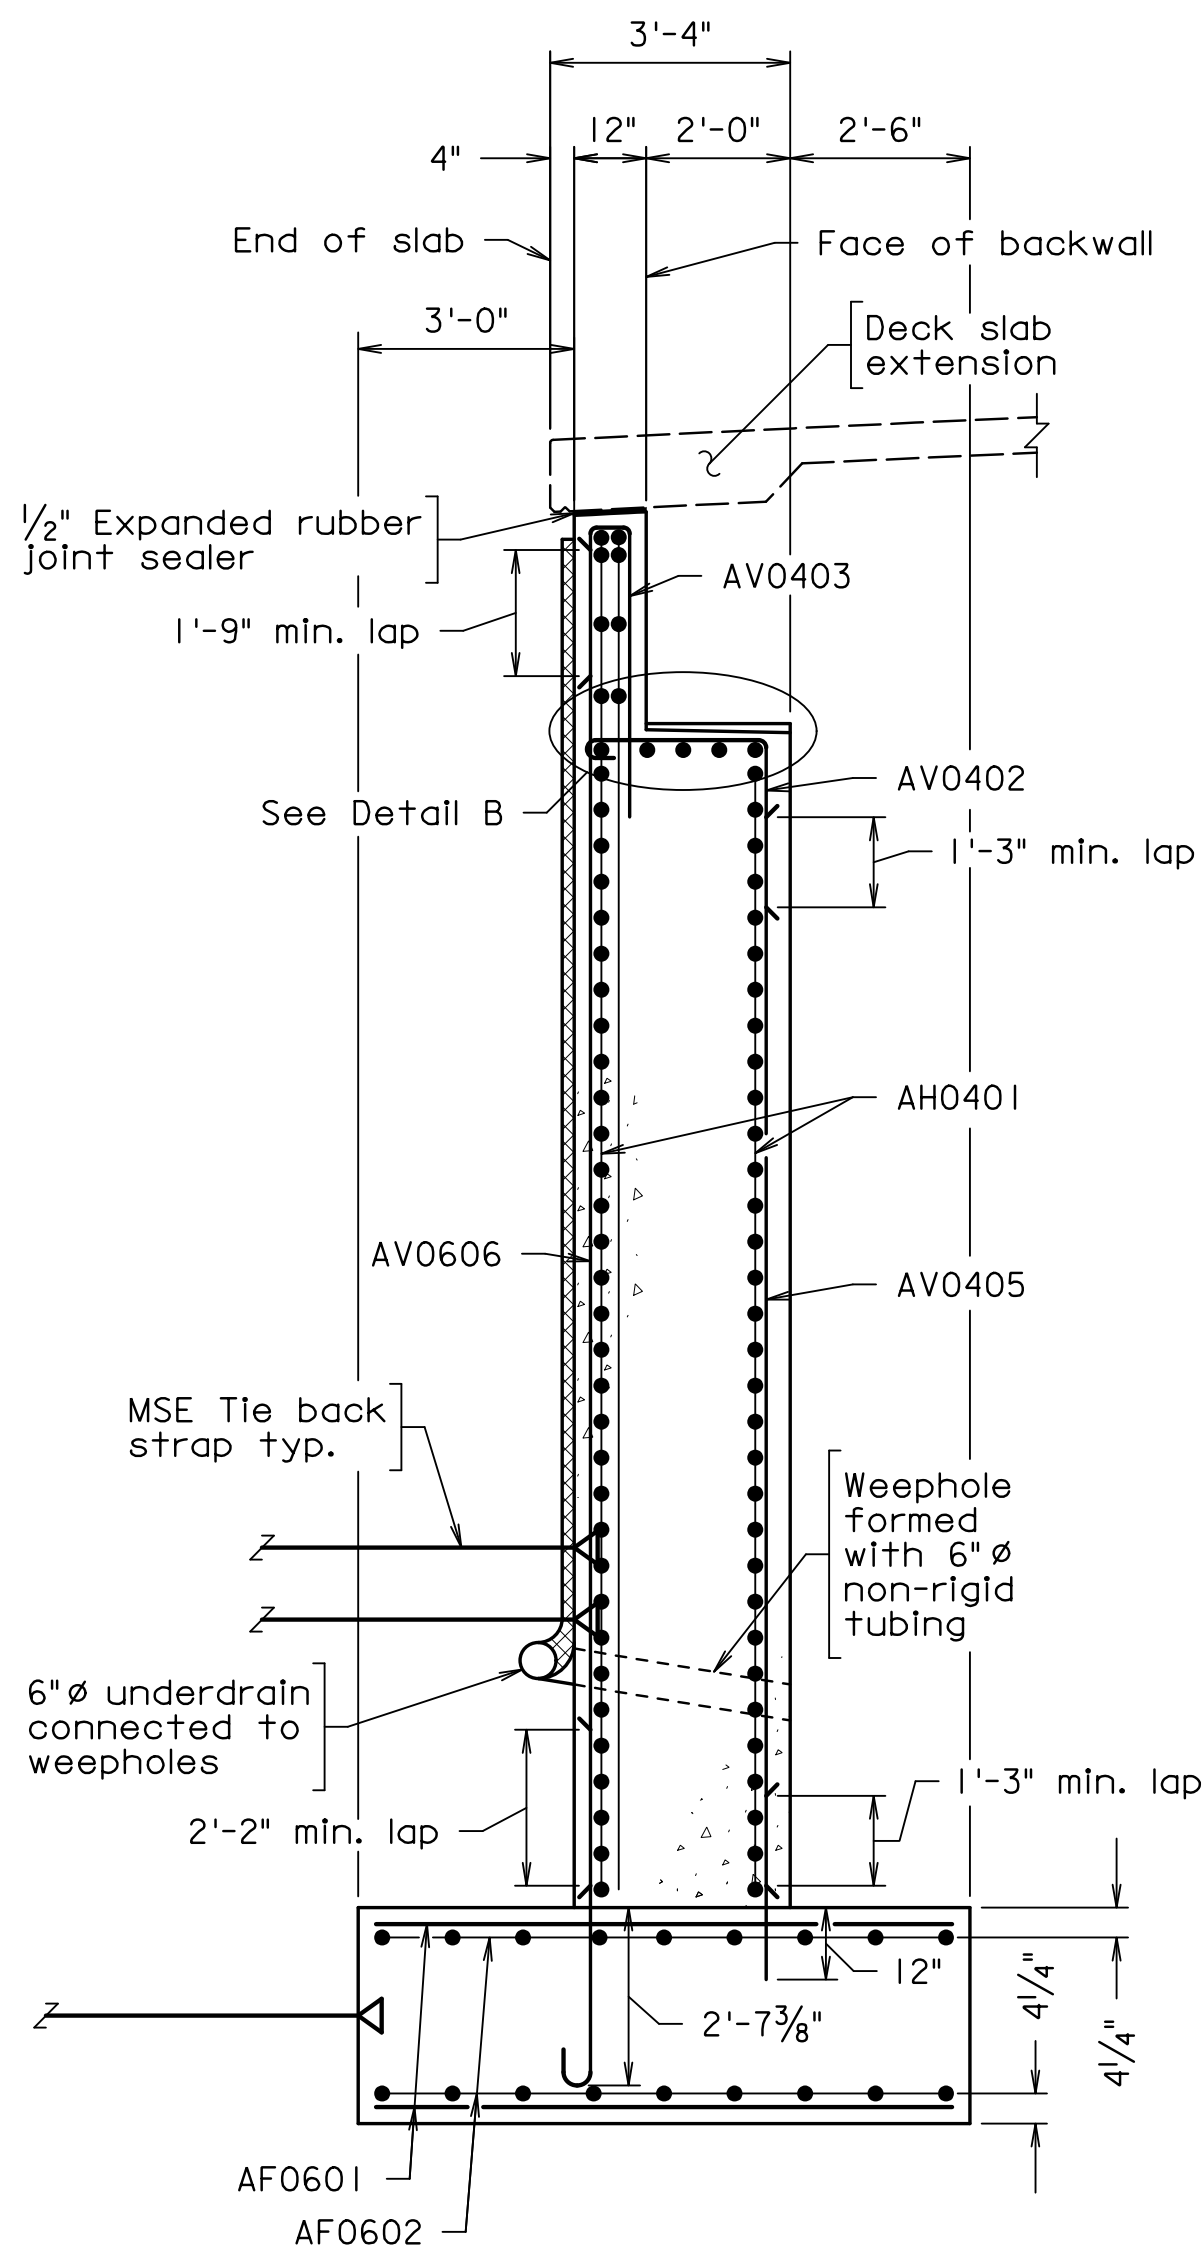
ELEVATION  
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TOP OF BACKWALL ELEVATIONS  
Scale: 3/8" = 1'-0"



SECTION K-K  
Scale: 3/8" = 1'-0"



SECTION L-L  
Scale: 3/8" = 1'-0"

Notes:

Tie strip length and spacing to be provided by MSE Wall fabricator to resist a design lateral force of 2.2 kips per linear foot of abutment for Tie Strip Line 1 and 2.4 kips per linear foot of abutment for Tie Strip Line 2. Tie strip lines shall be located 1'-9" and 4'-9" above bottom of footing (+/- 3") for Tie Strip Lines 1 and 2 respectively.

Top of backwall below deck slab extension shall be finished to match local grade profile.

For Footing plan, see sheet 6(7).

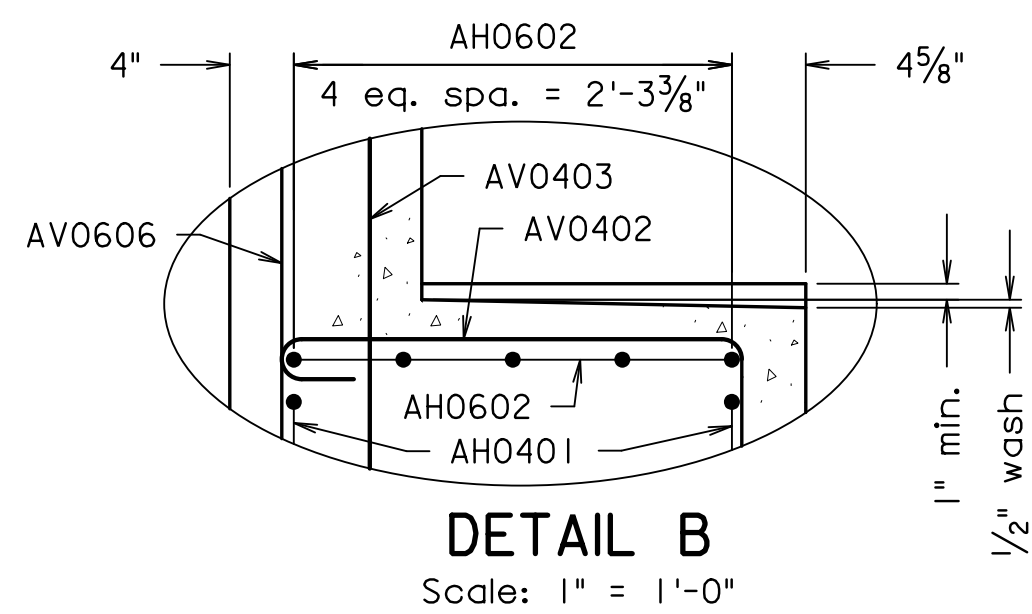
For wingwall details, see sheet 6(7).

A 1" preformed joint filler shall be placed vertically between deck slab extension and wingwall.


The 1/2" expanded rubber joint filler shall extend the full length of the deck slab extension.

The cost of preformed and expanded rubber joint fillers shall be incidental to Class A3 concrete.

For architectural treatment, see sheet 6(15).



DETAIL B  
Scale: 1" = 1'-0"

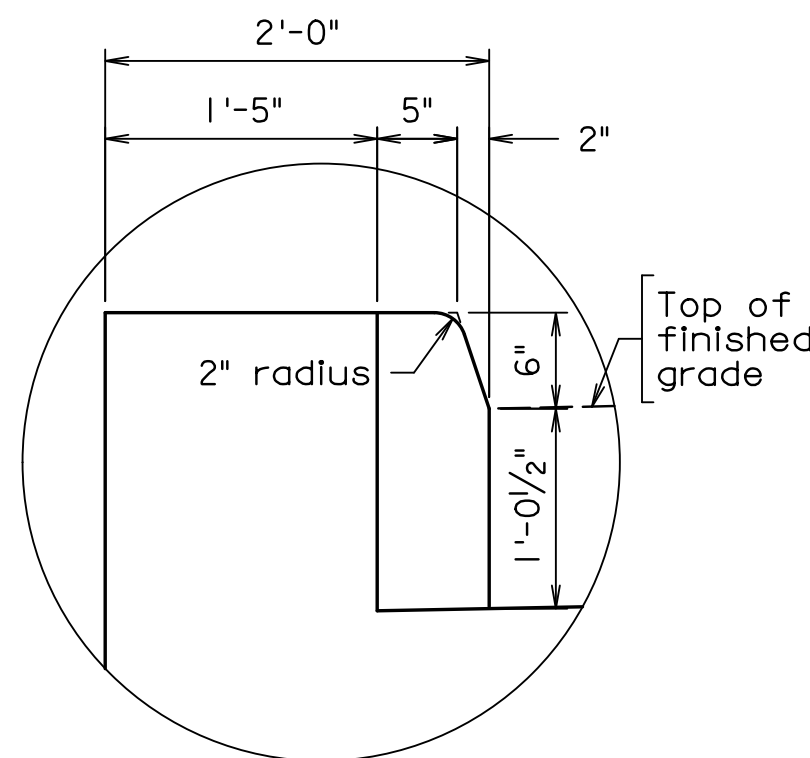

DETAIL B  
Scale: 1" = 1'-0"

PREFINAL PLANS

EMERGENCY POLICE - FIRE - RESCUE 911									
FAIRFAX COUNTY, VIRGINIA									
DEPARTMENT OF PUBLIC WORKS AND ENVIRONMENTAL SERVICES									
12000 GOVERNMENT CENTER PARKWAY, SUITE 449 FAIRFAX, VA., 22035-0052									
R E V i S i O N S						OFFICE OF CAPITAL FACILITIES 703-324-5800			
						WIEHLE AVENUE (RTE 828) AT W&OD TRAIL			
						ABUTMENT B PLAN & ELEVATION			
						PROJECT NO: 1400102-2013			
						PLAN NO. XXX-XX	DESIGNED: JRM DRAFTED: CRR CHECKED: TAB		SHEET 6(6)
						APPROVED BY THE TRANSPORTATION DESIGN DIVISION			
WHITMAN REQUARDT & ASSOCIATES RICHMOND, VA STRUCTURAL ENGINEER									

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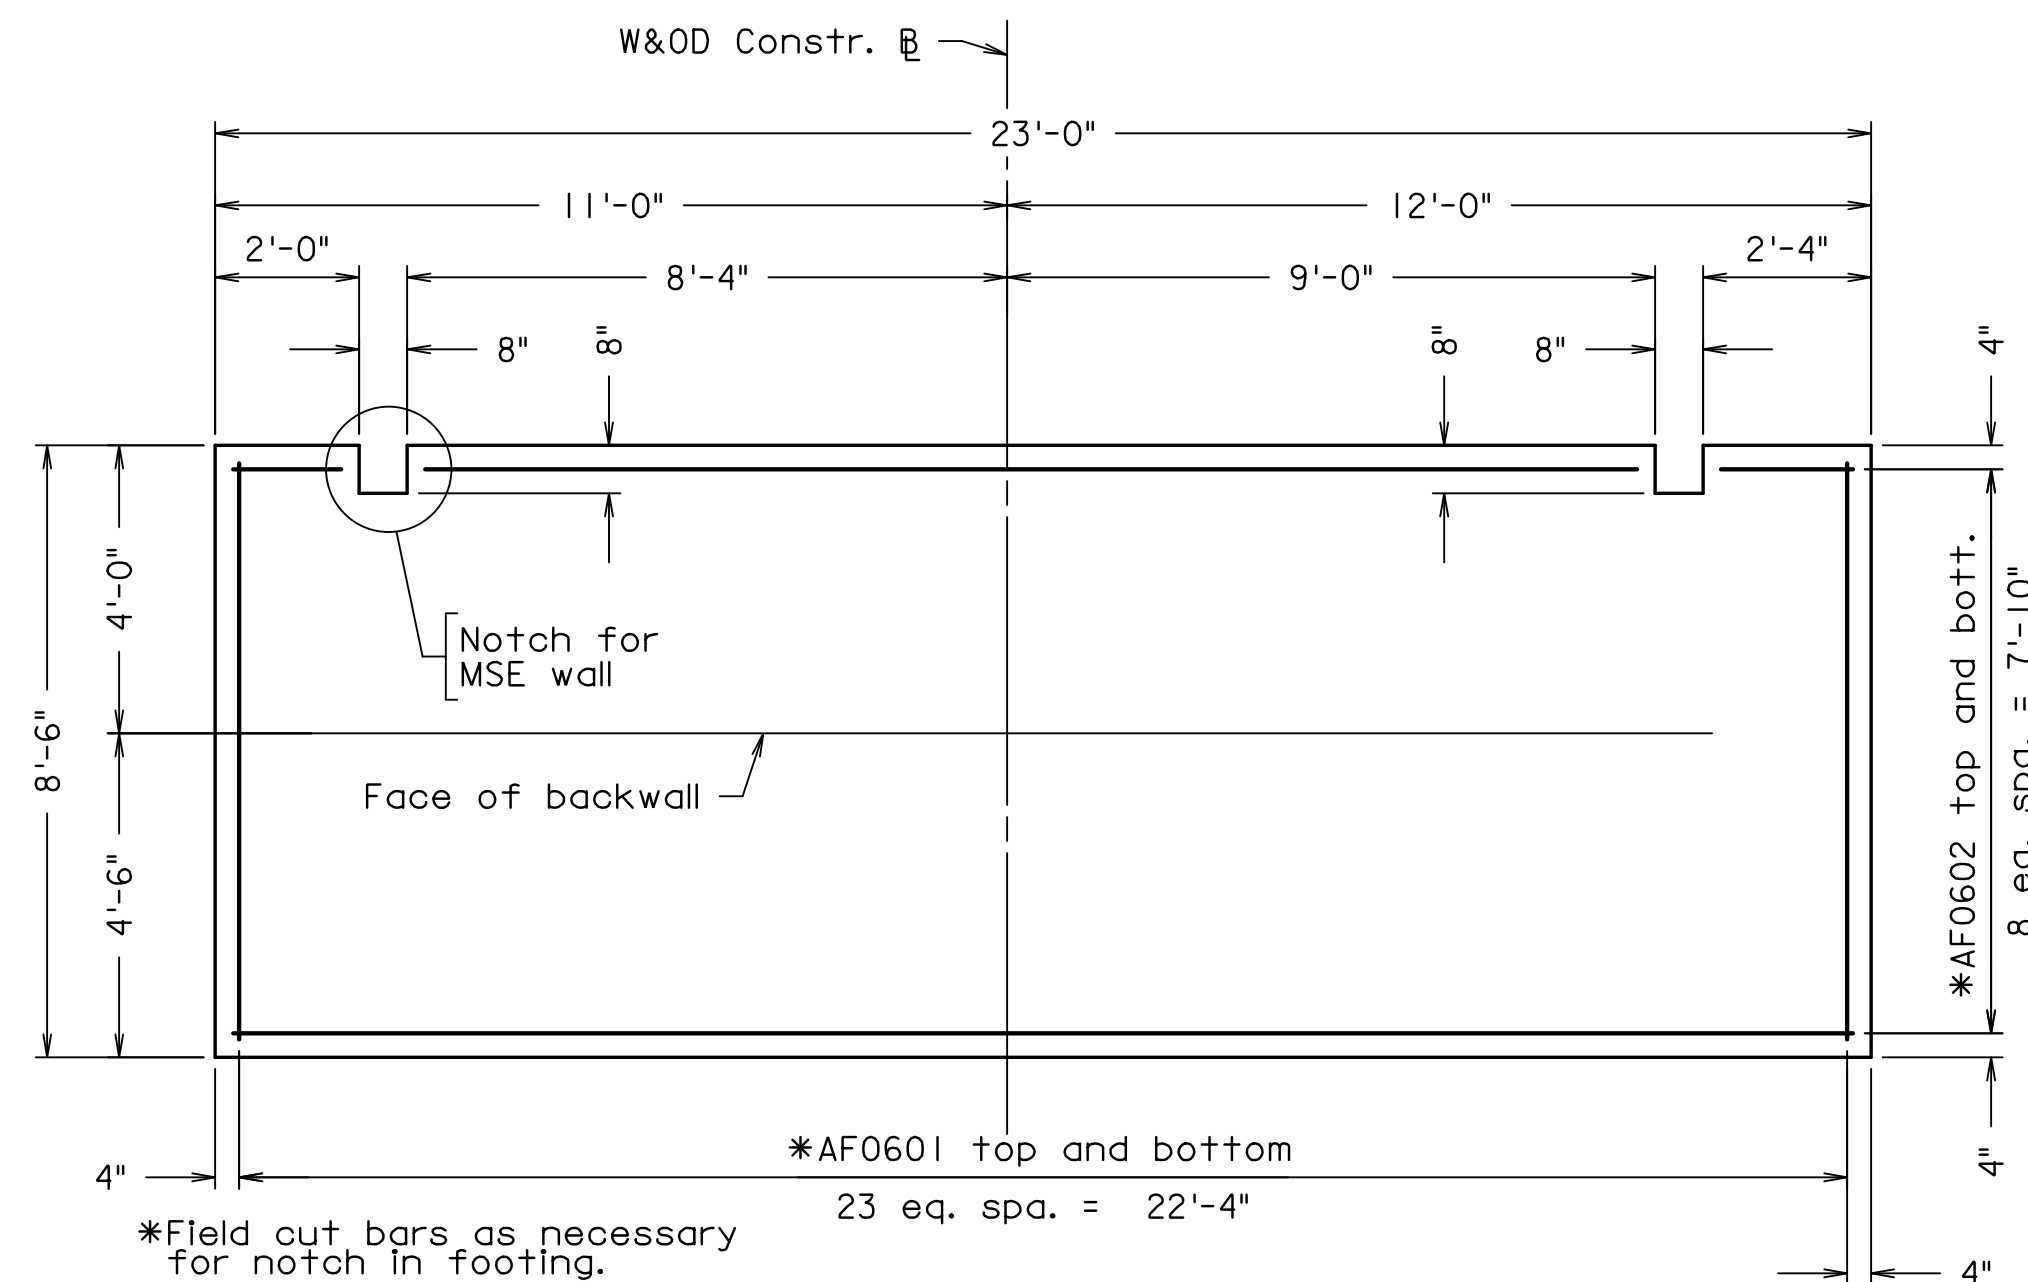
PROJECT MANAGER, SCOTT RUFFNER, P.E. (703) 877-5736-----  
SURVEYED BY, DATE FAIRFAX COUNTY-----  
DESIGN BY WHITMAN, REQUARDT & ASSOCIATES, LLP (703) 293-9717-----  
SUBSURFACE UTILITY BY, DATE SO DEEP, INC. (703) 361-6005 December 23, 2014-----

STATE	FEDERAL AID		STATE	
	ROUTE	PROJECT	ROUTE	PROJECT
VA.	—	—	828	0828-029-248, B-601


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For abutment notes, see sheet 6(6).


For Substructure Layout, see sheet 6(3).



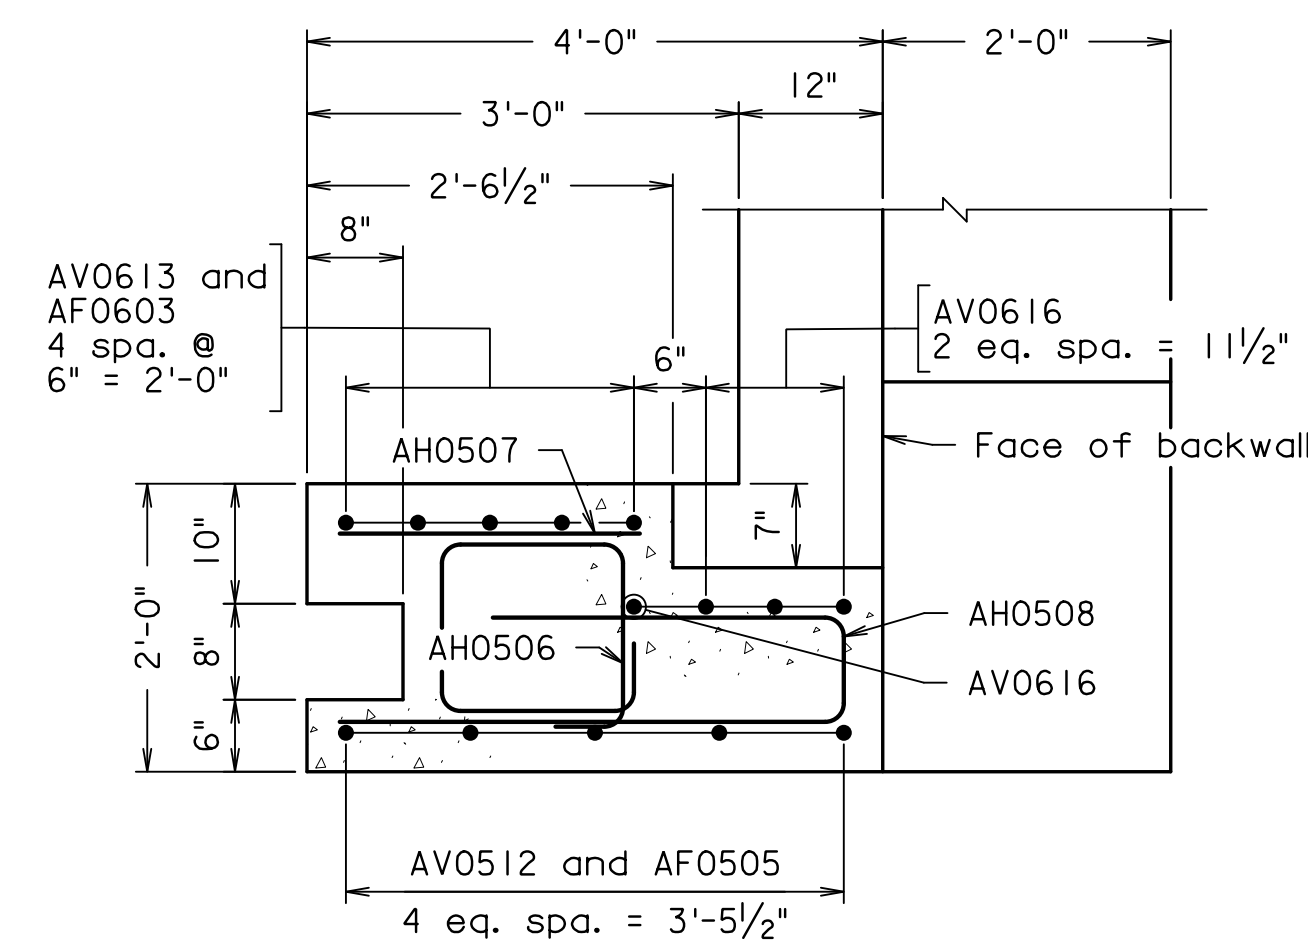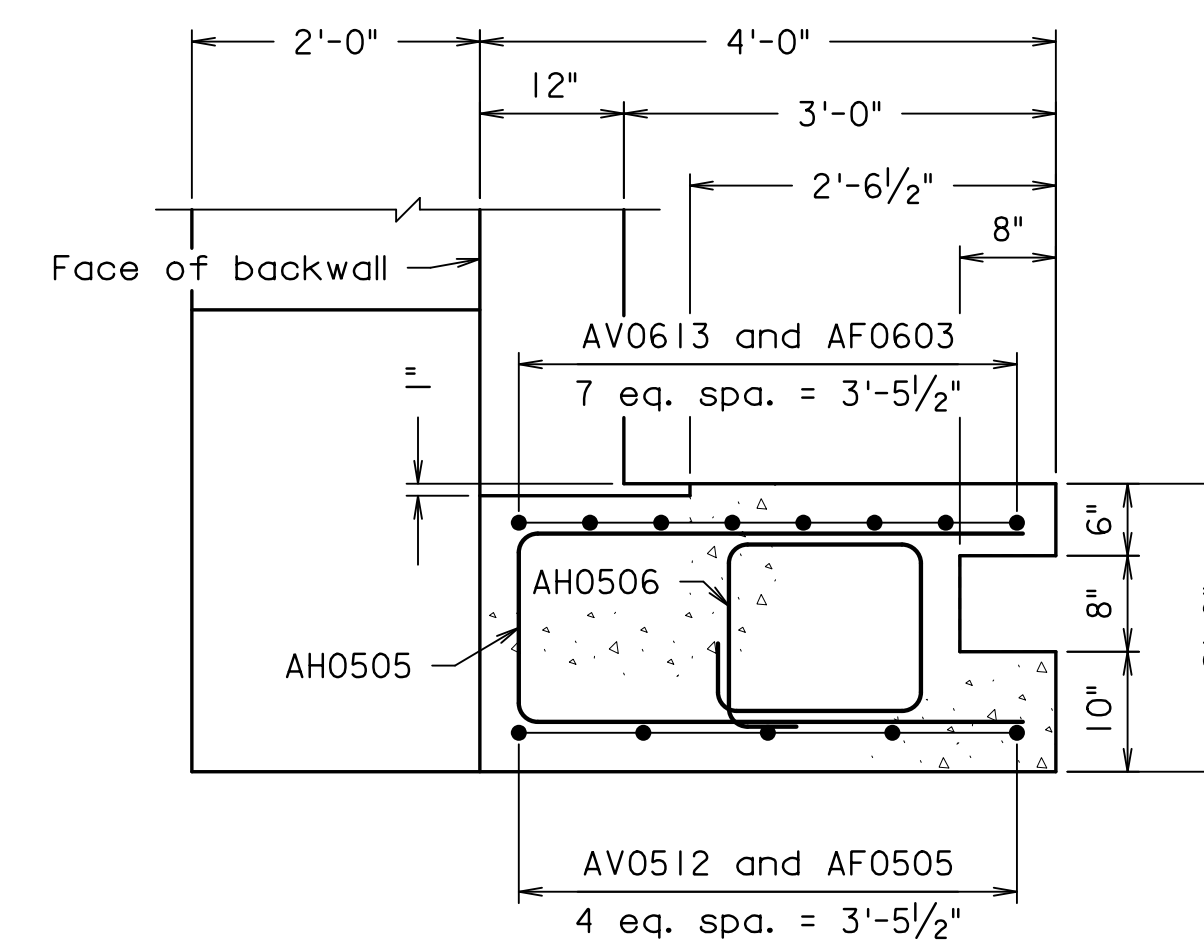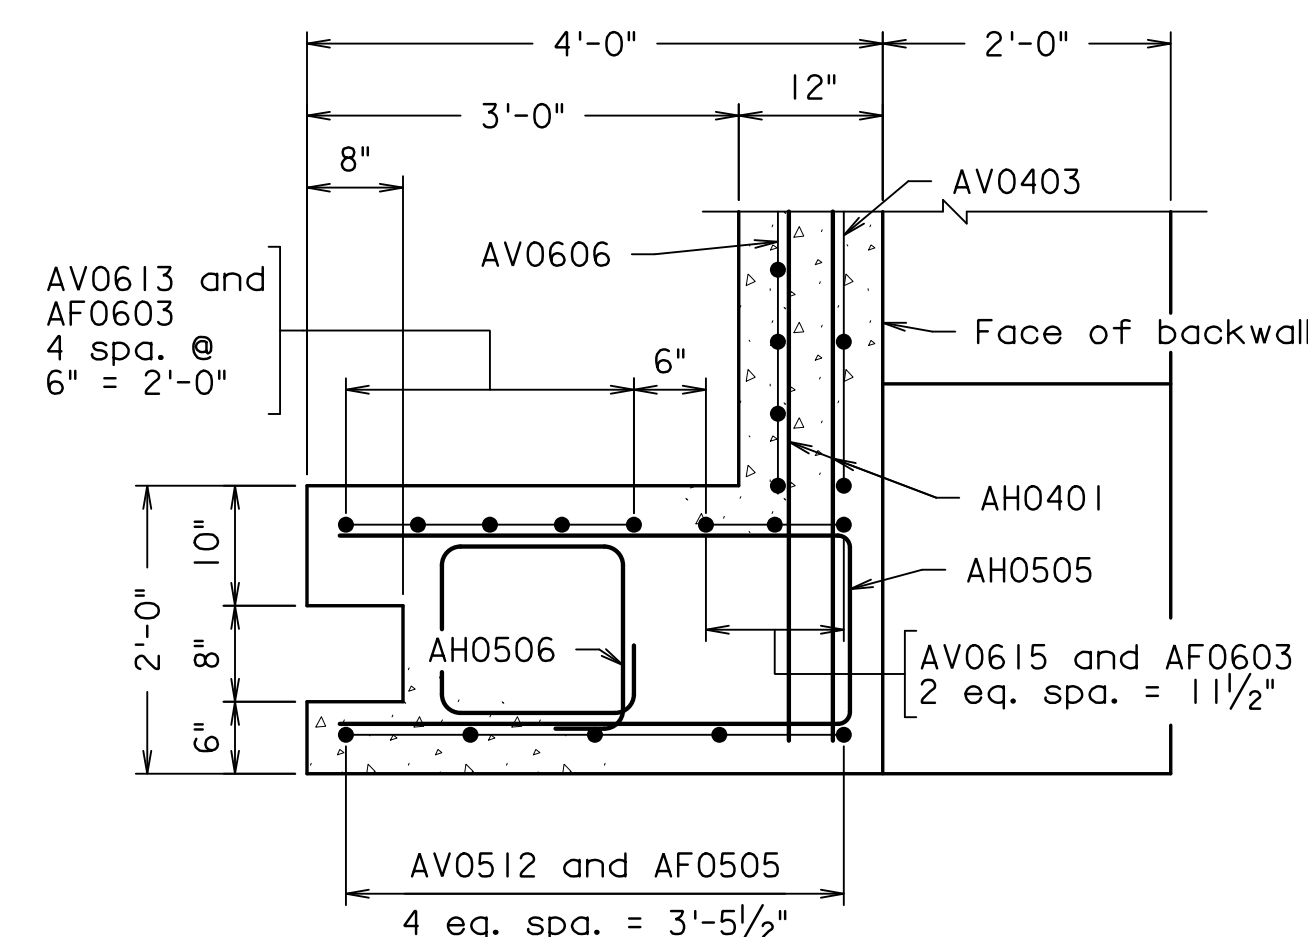
FOOTING PLAN



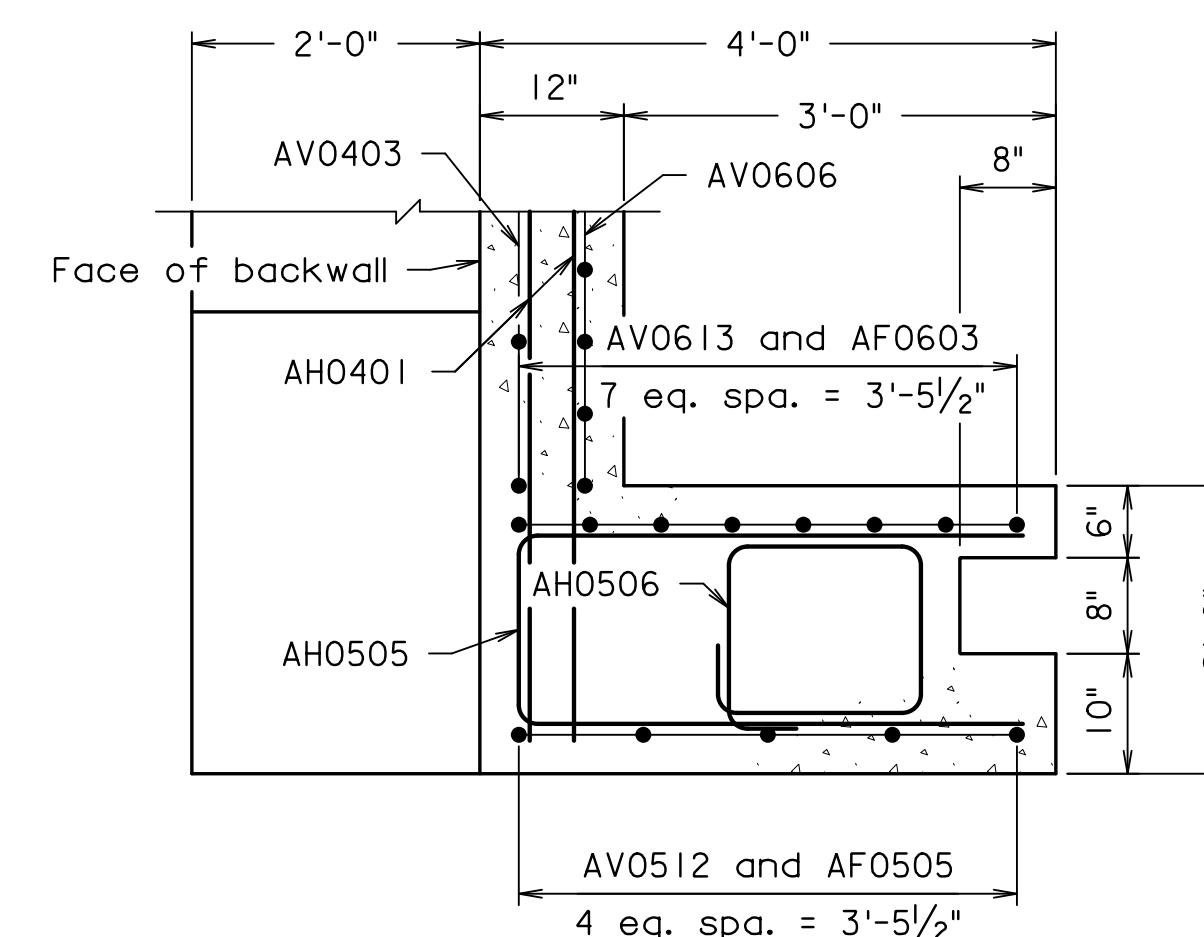
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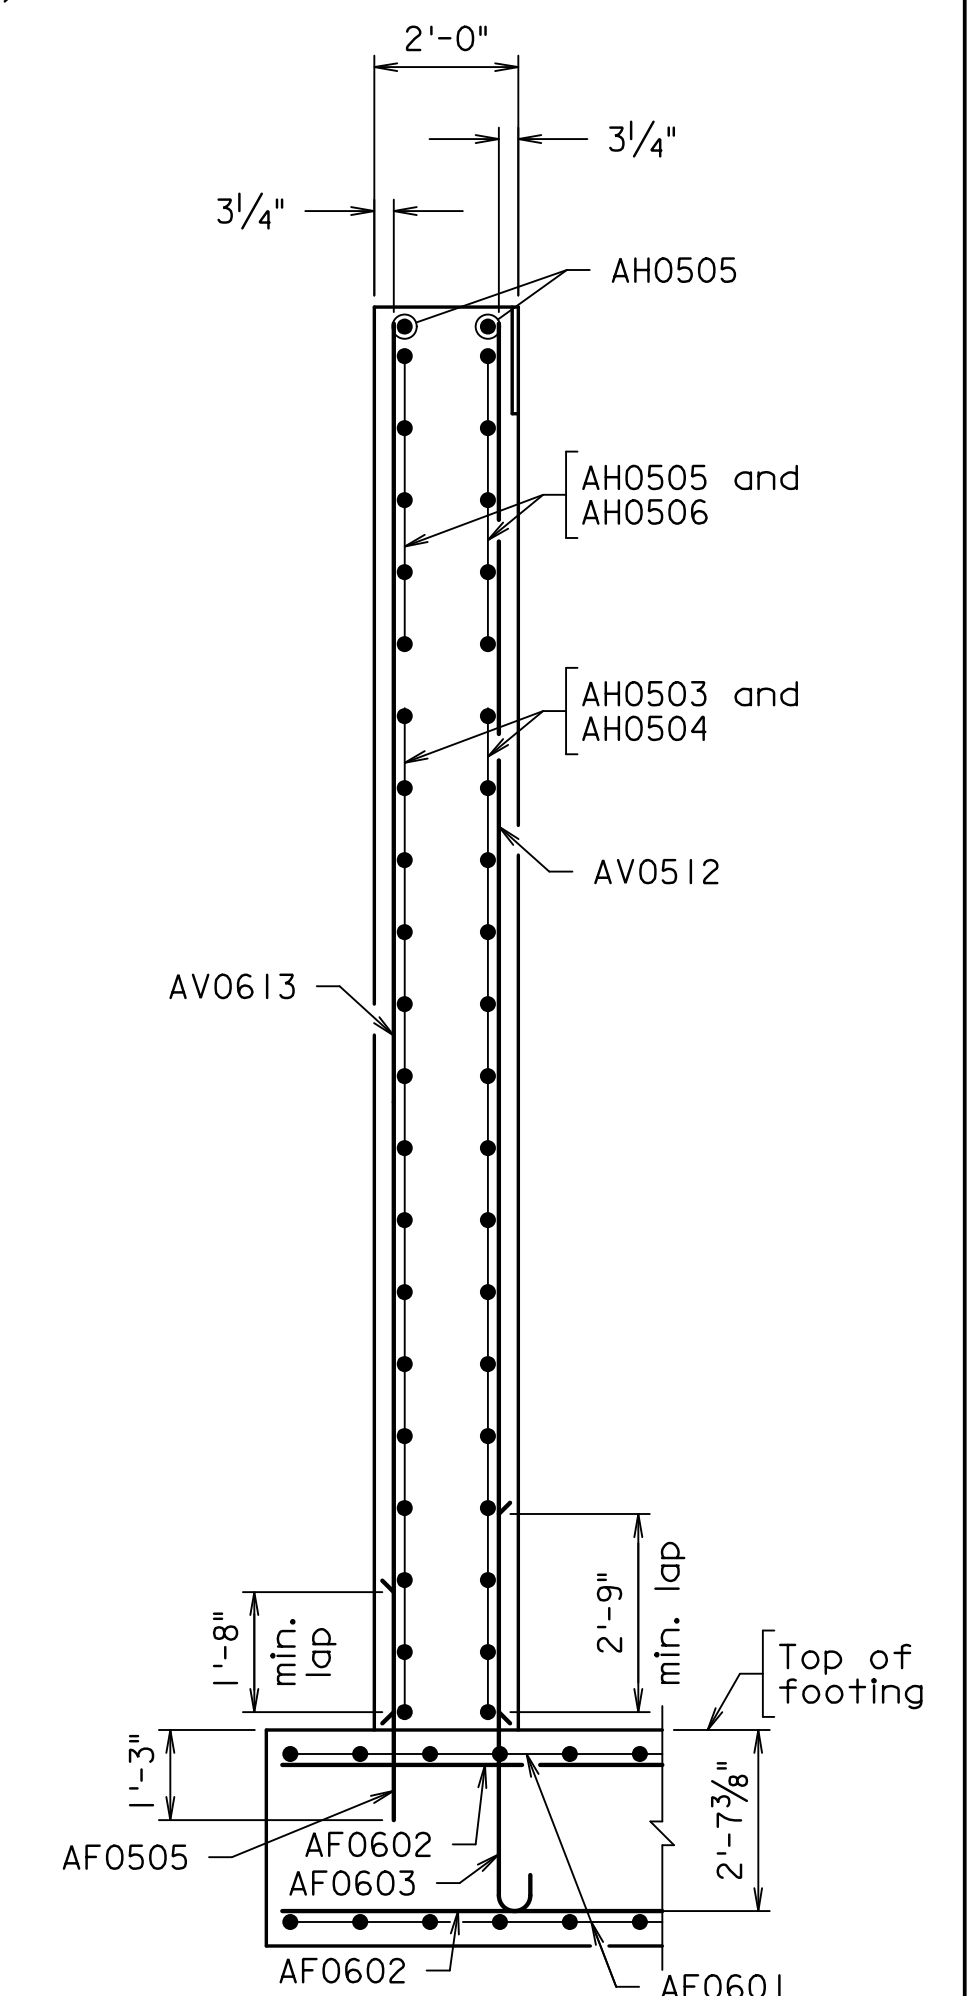
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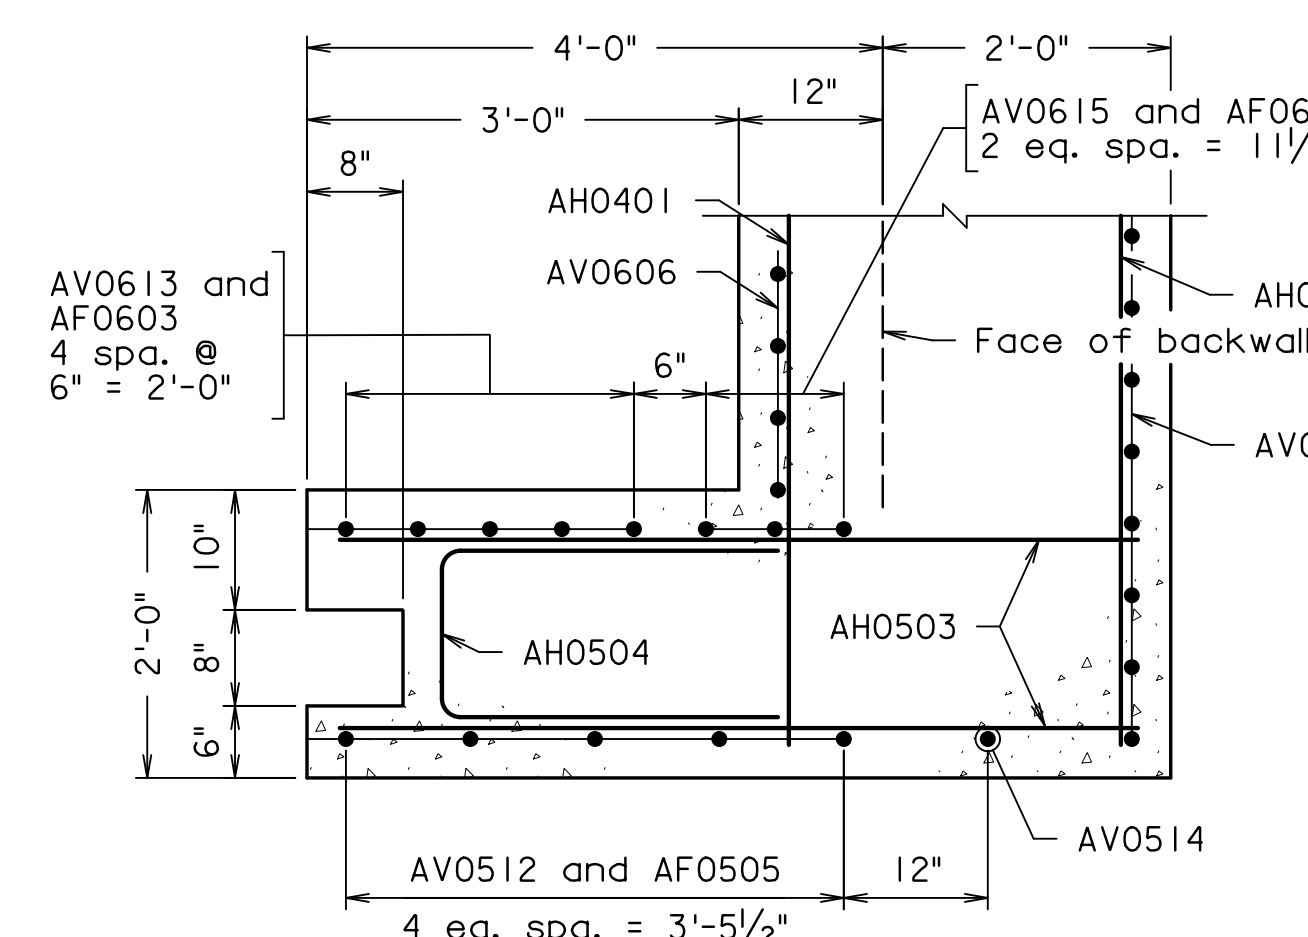
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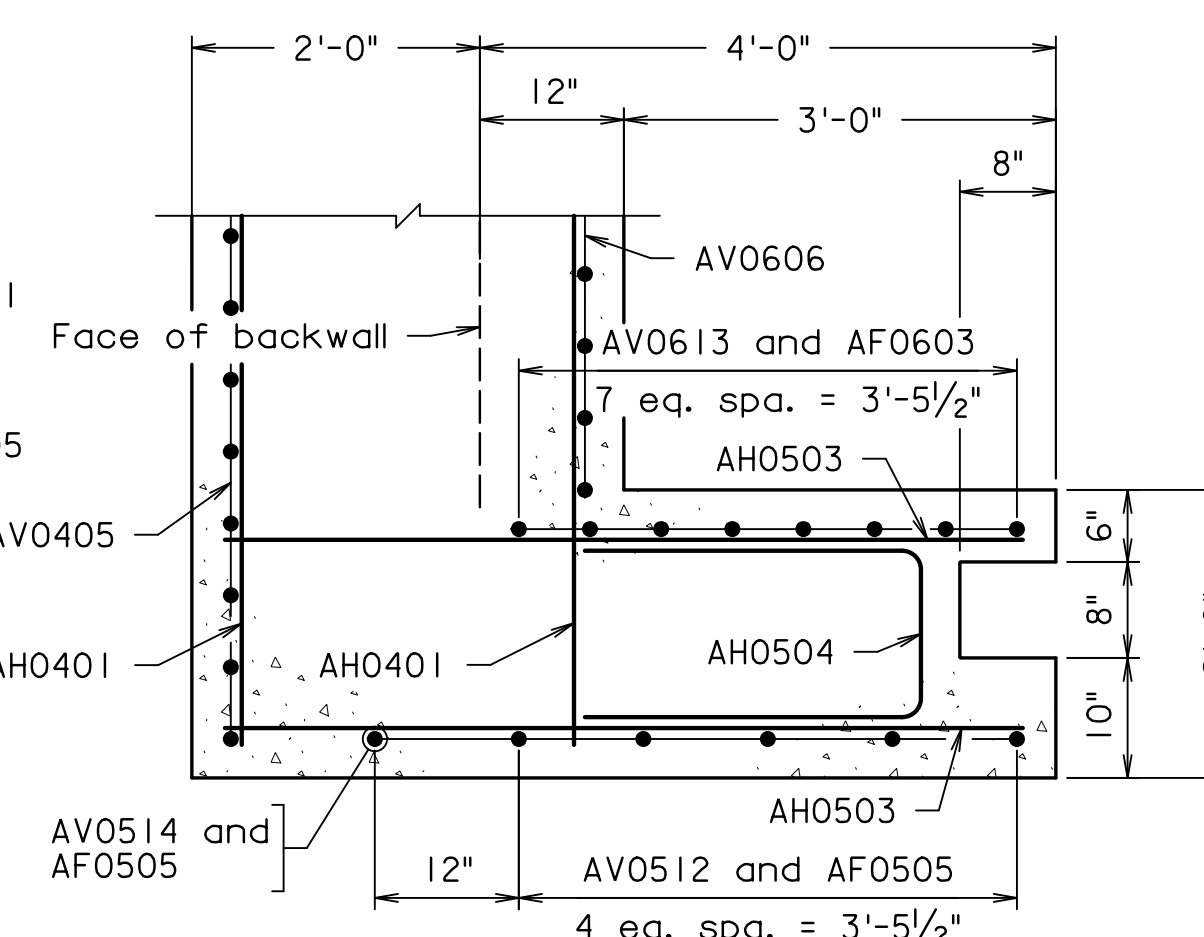
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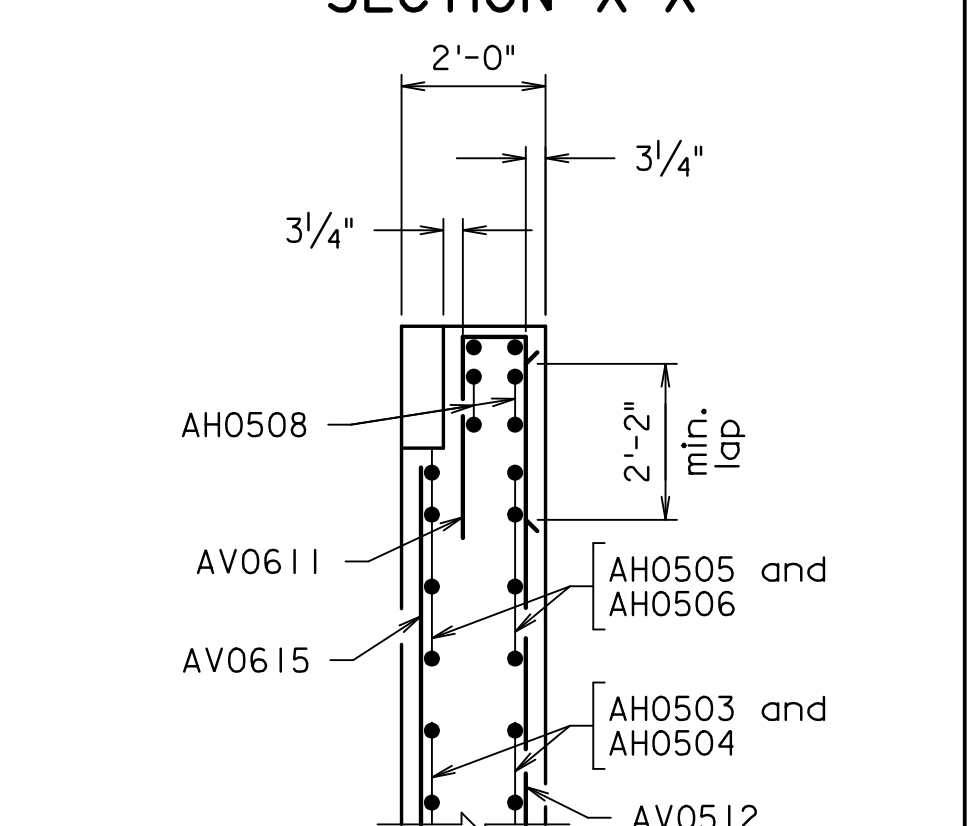
SECTION X-X



SECTION M-M



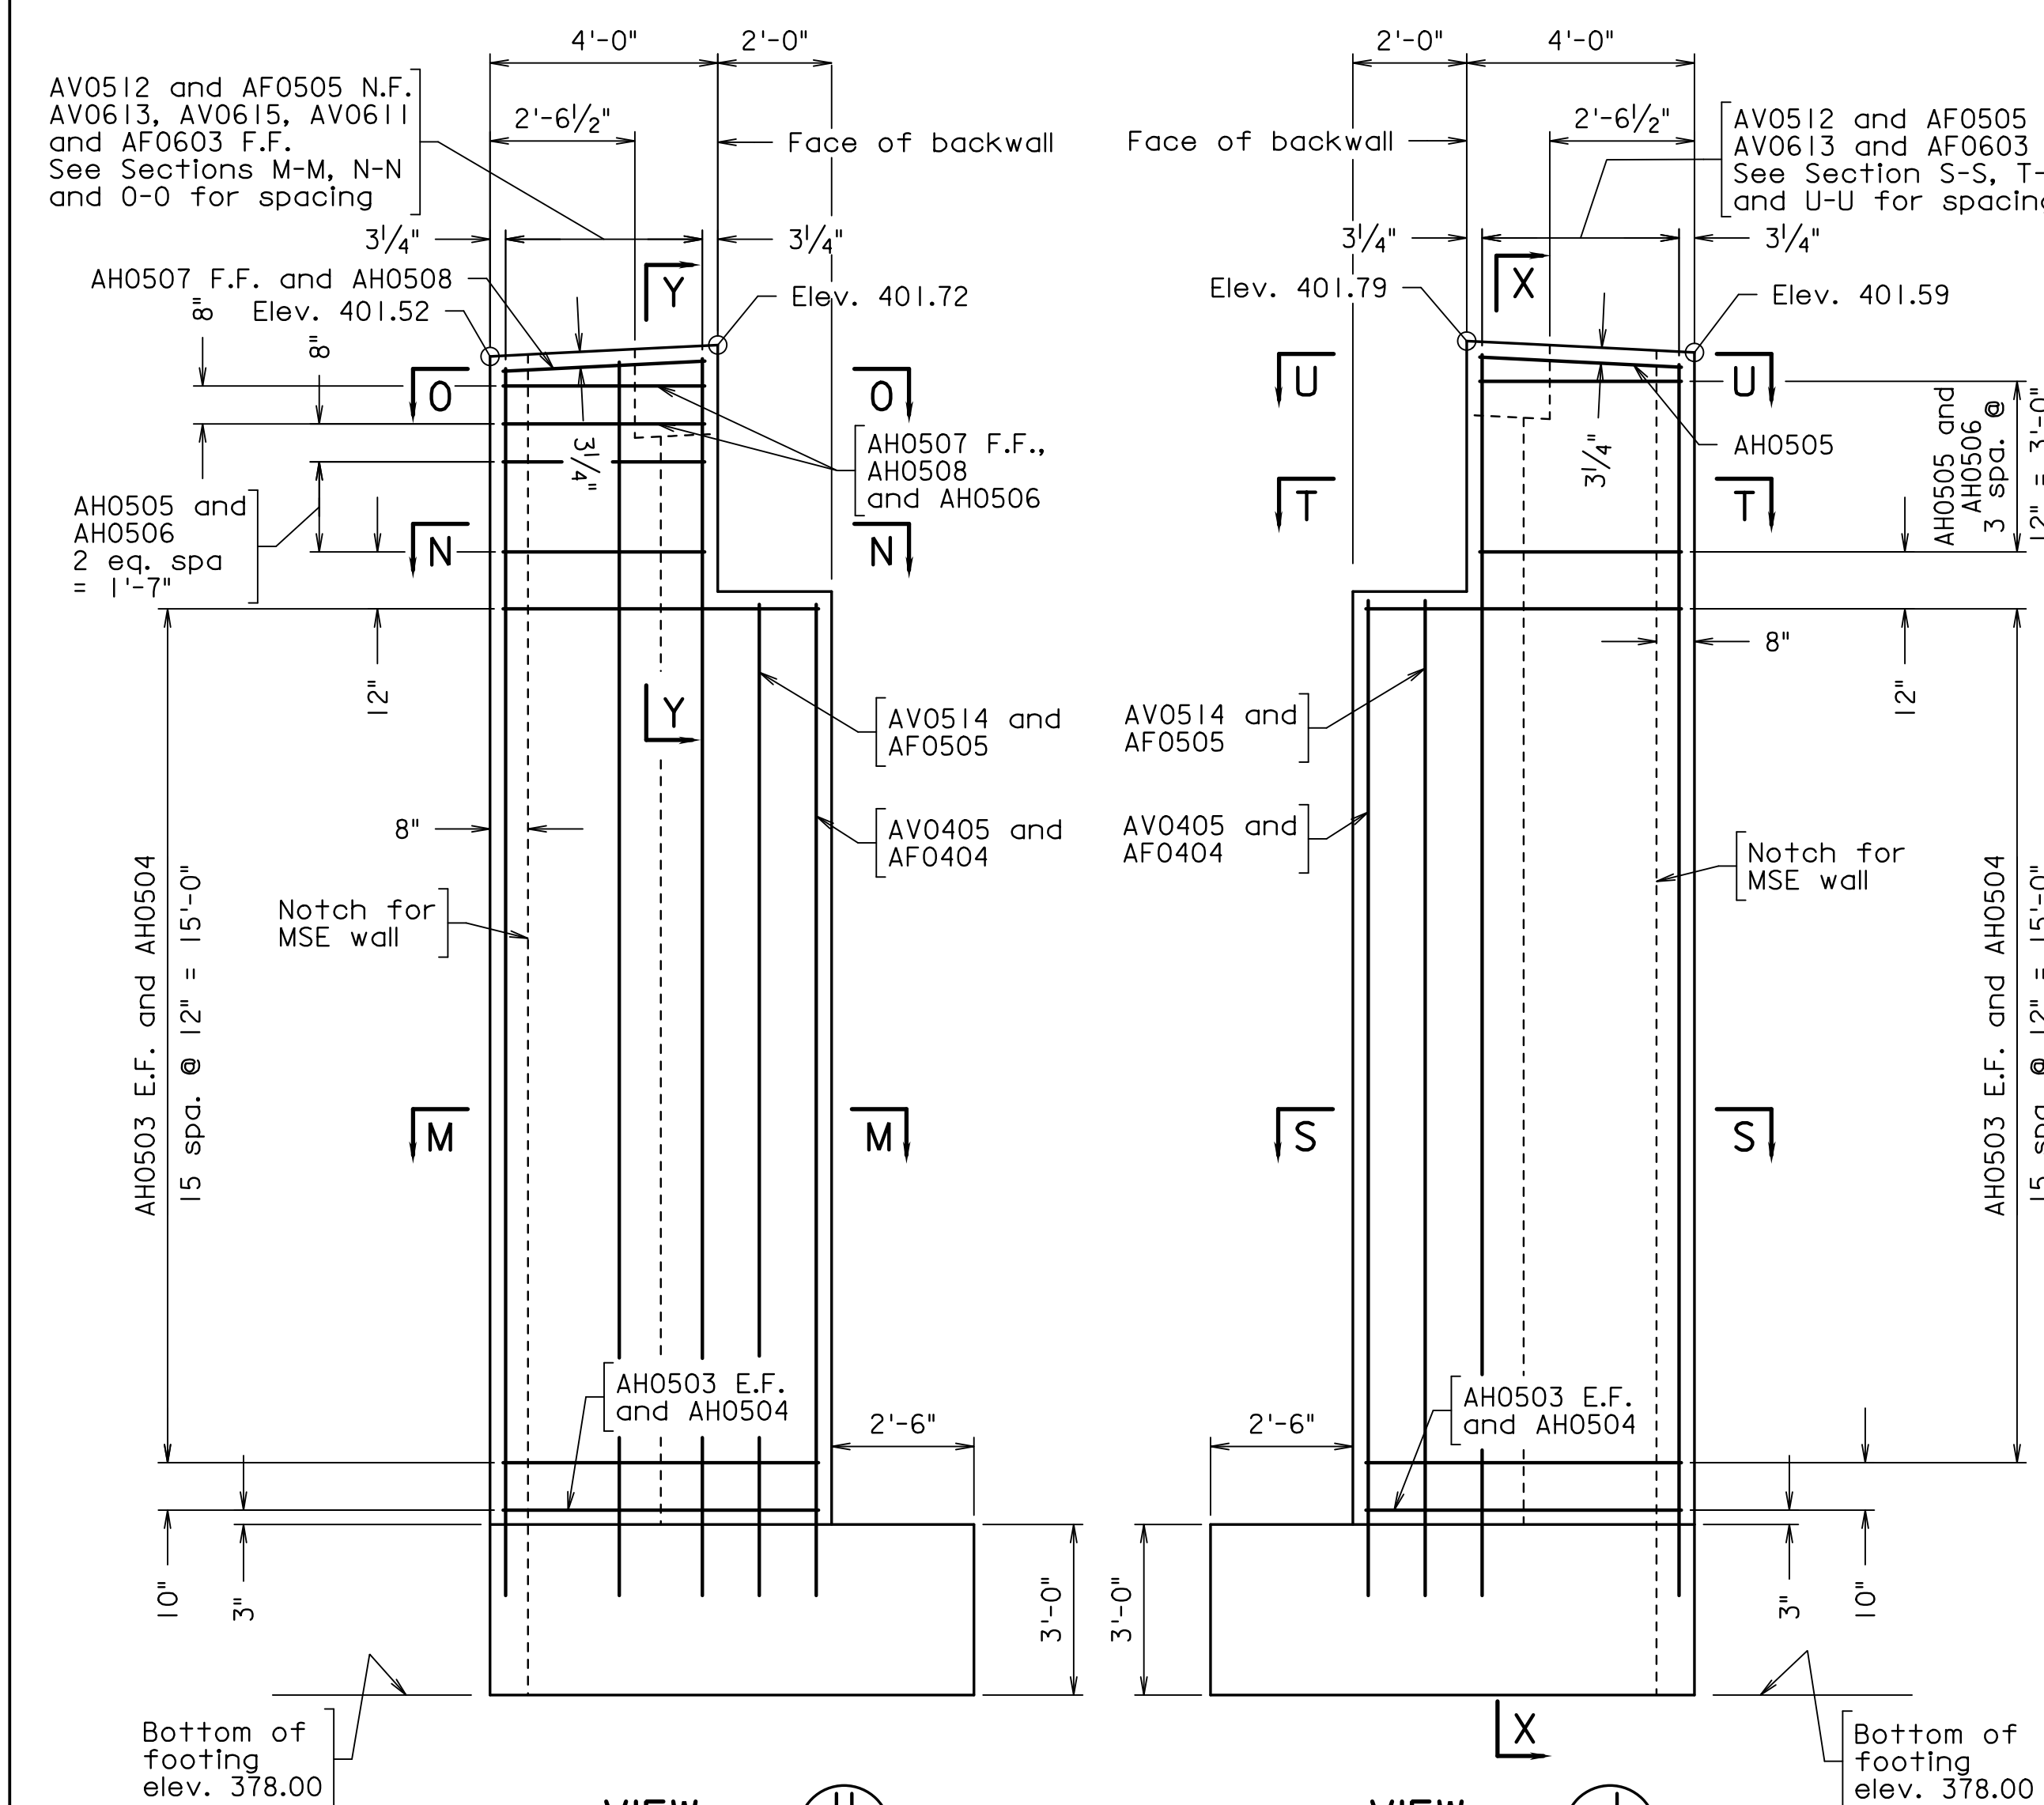
SECTION S-S



SECTION Y-Y

For additional details see Section X-X.

PREFINAL PLANS



VIEW

Scale:  $\frac{3}{8}" = 1'-0"$

VIEW

Scale:  $\frac{3}{8}" = 1'-0"$

		EMERGENCY POLICE - FIRE - RESCUE 911						
		FAIRFAX COUNTY, VIRGINIA DEPARTMENT OF PUBLIC WORKS AND ENVIRONMENTAL SERVICES 12000 GOVERNMENT CENTER PARKWAY, SUITE 449 FAIRFAX, VA., 22035-0052						
R E V I S I O N						OFFICE OF CAPITAL FACILITIES 703-324-5800		
						WIEHLE AVENUE (RTE 828) AT W&OD TRAIL		
						ABUTMENT B FOOTING PLAN & DETAILS		
						PROJECT NO: 1400102-2013		
						PLAN NO. XXX-XX	DESIGNED: JRM DRAFTED: CRR CHECKED: TAB	SHEET 6(7)
WHITMAN REQUARDT & ASSOCIATES RICHMOND, VA STRUCTURAL ENGINEER		△#	DESCRIPTION	BY	APPROVED	DATE	APPROVED BY THE TRANSPORTATION DESIGN DIVISION	

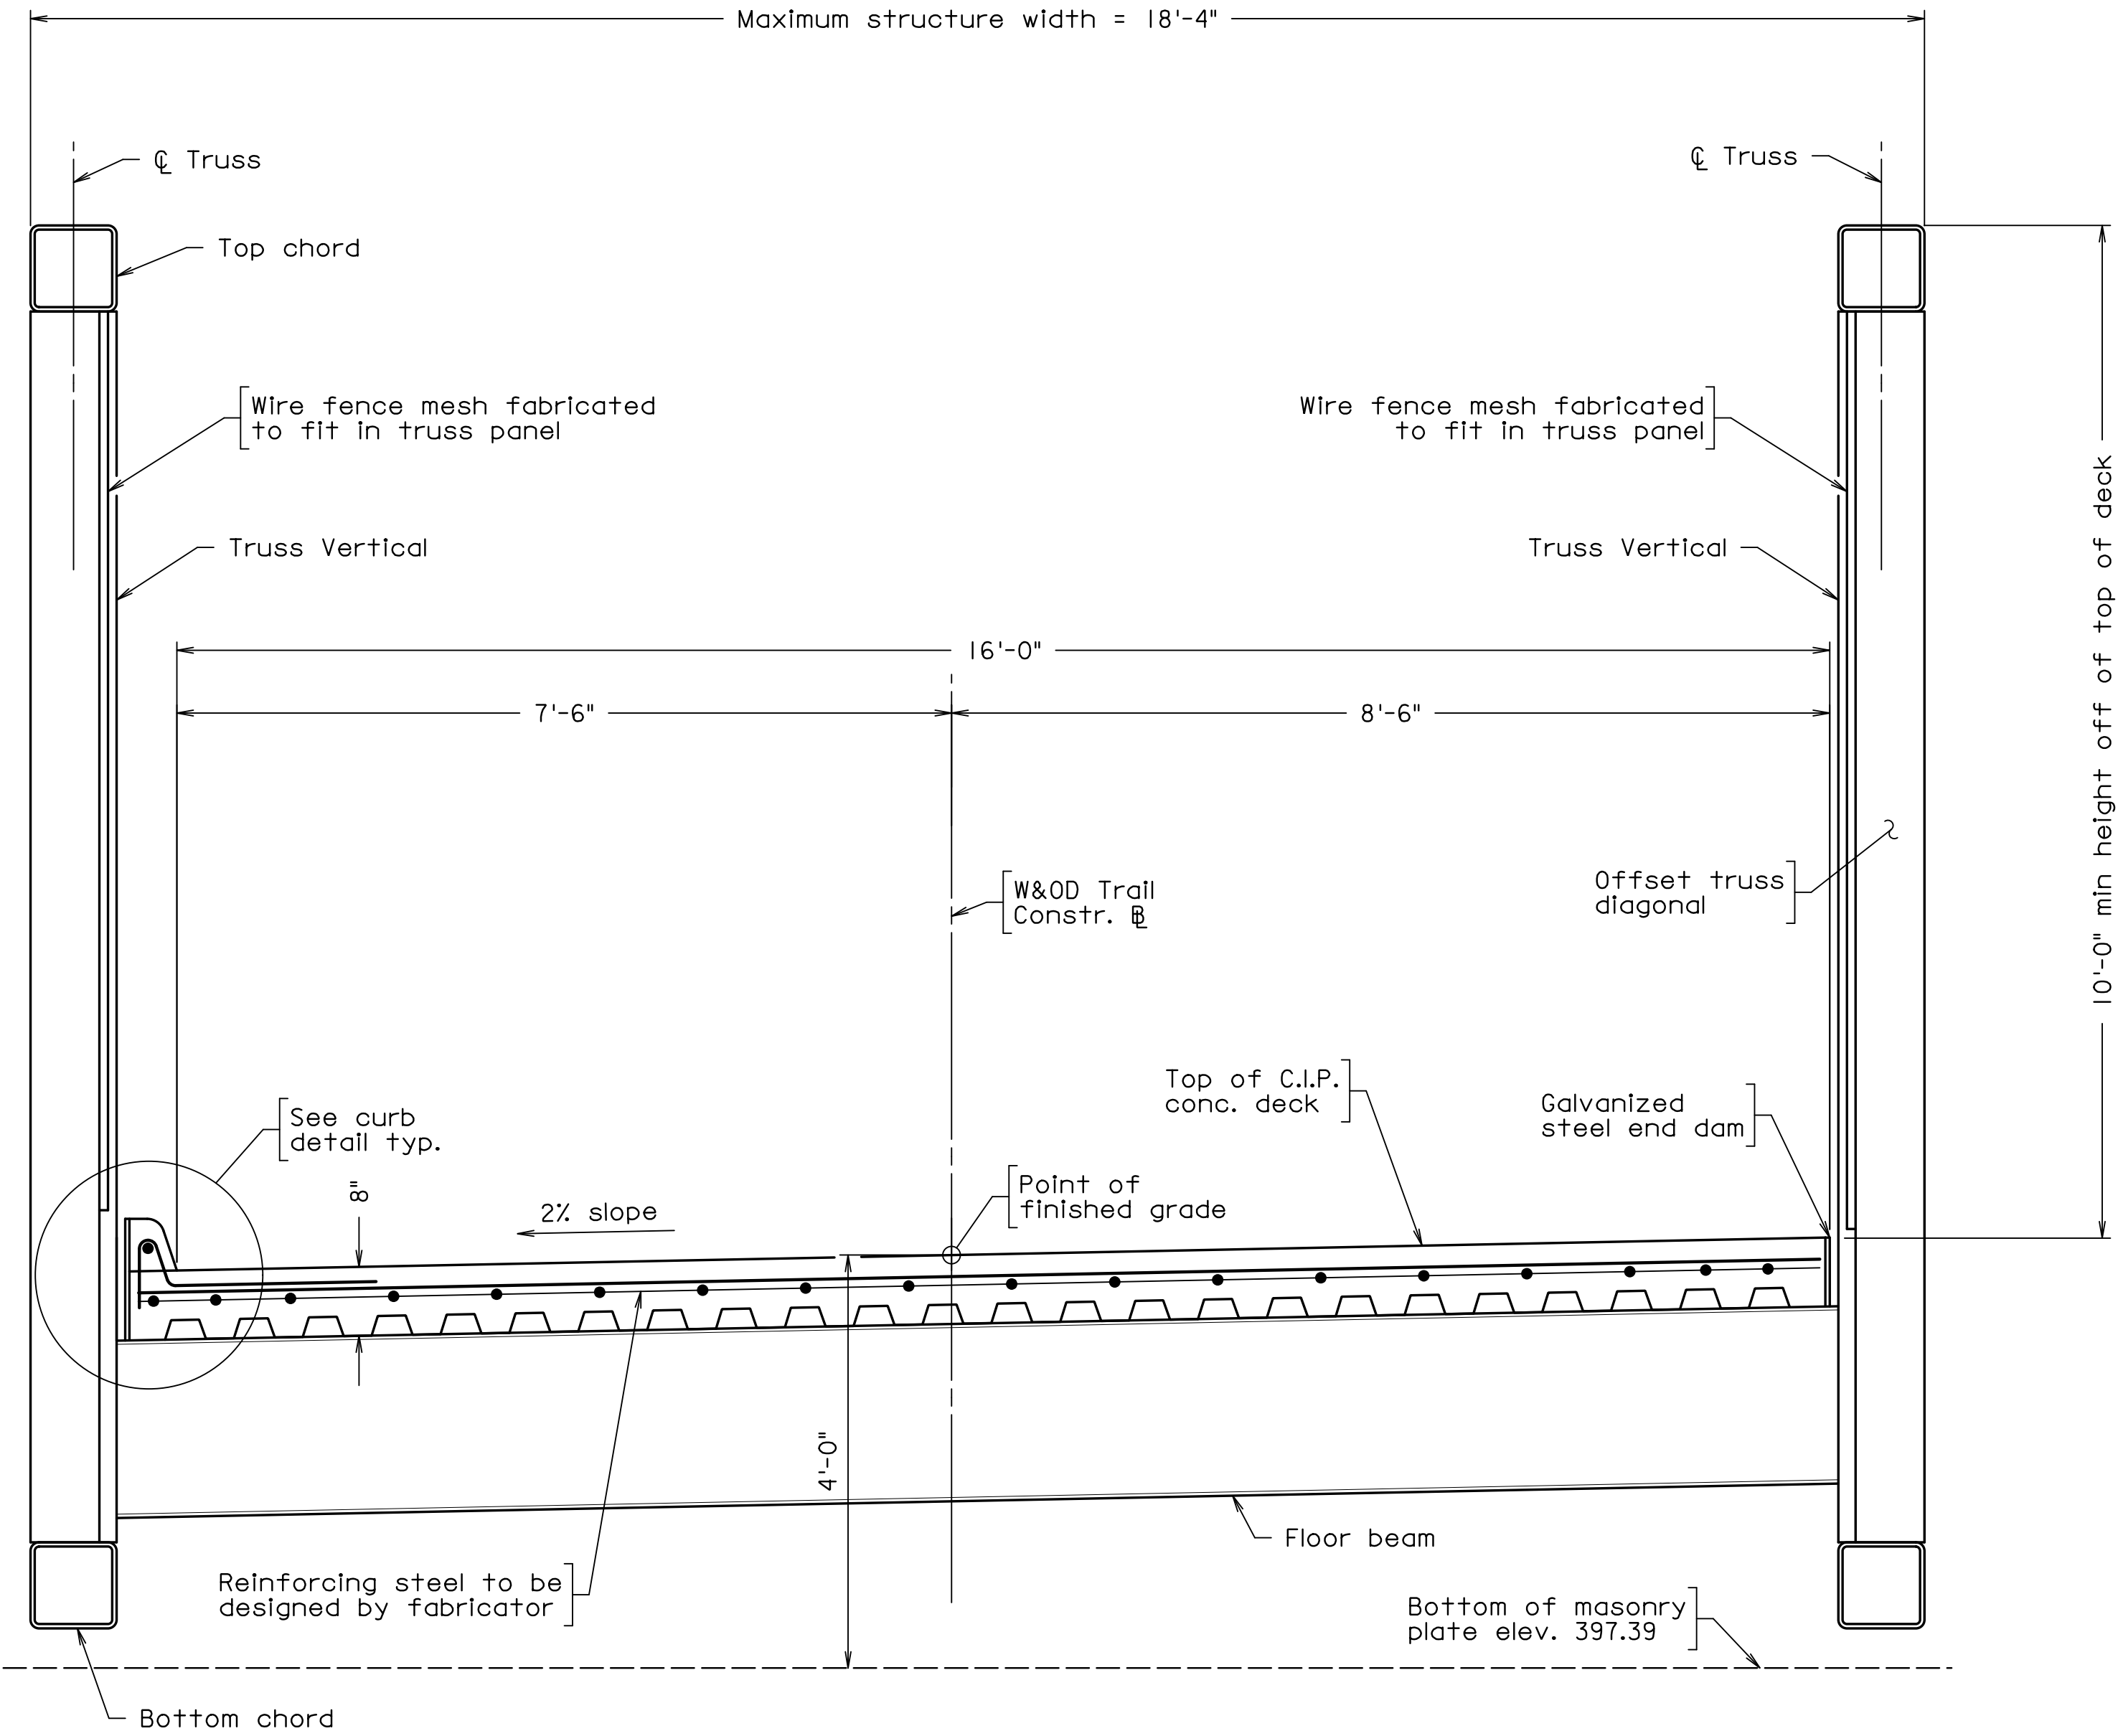
FUND #	500-C5000
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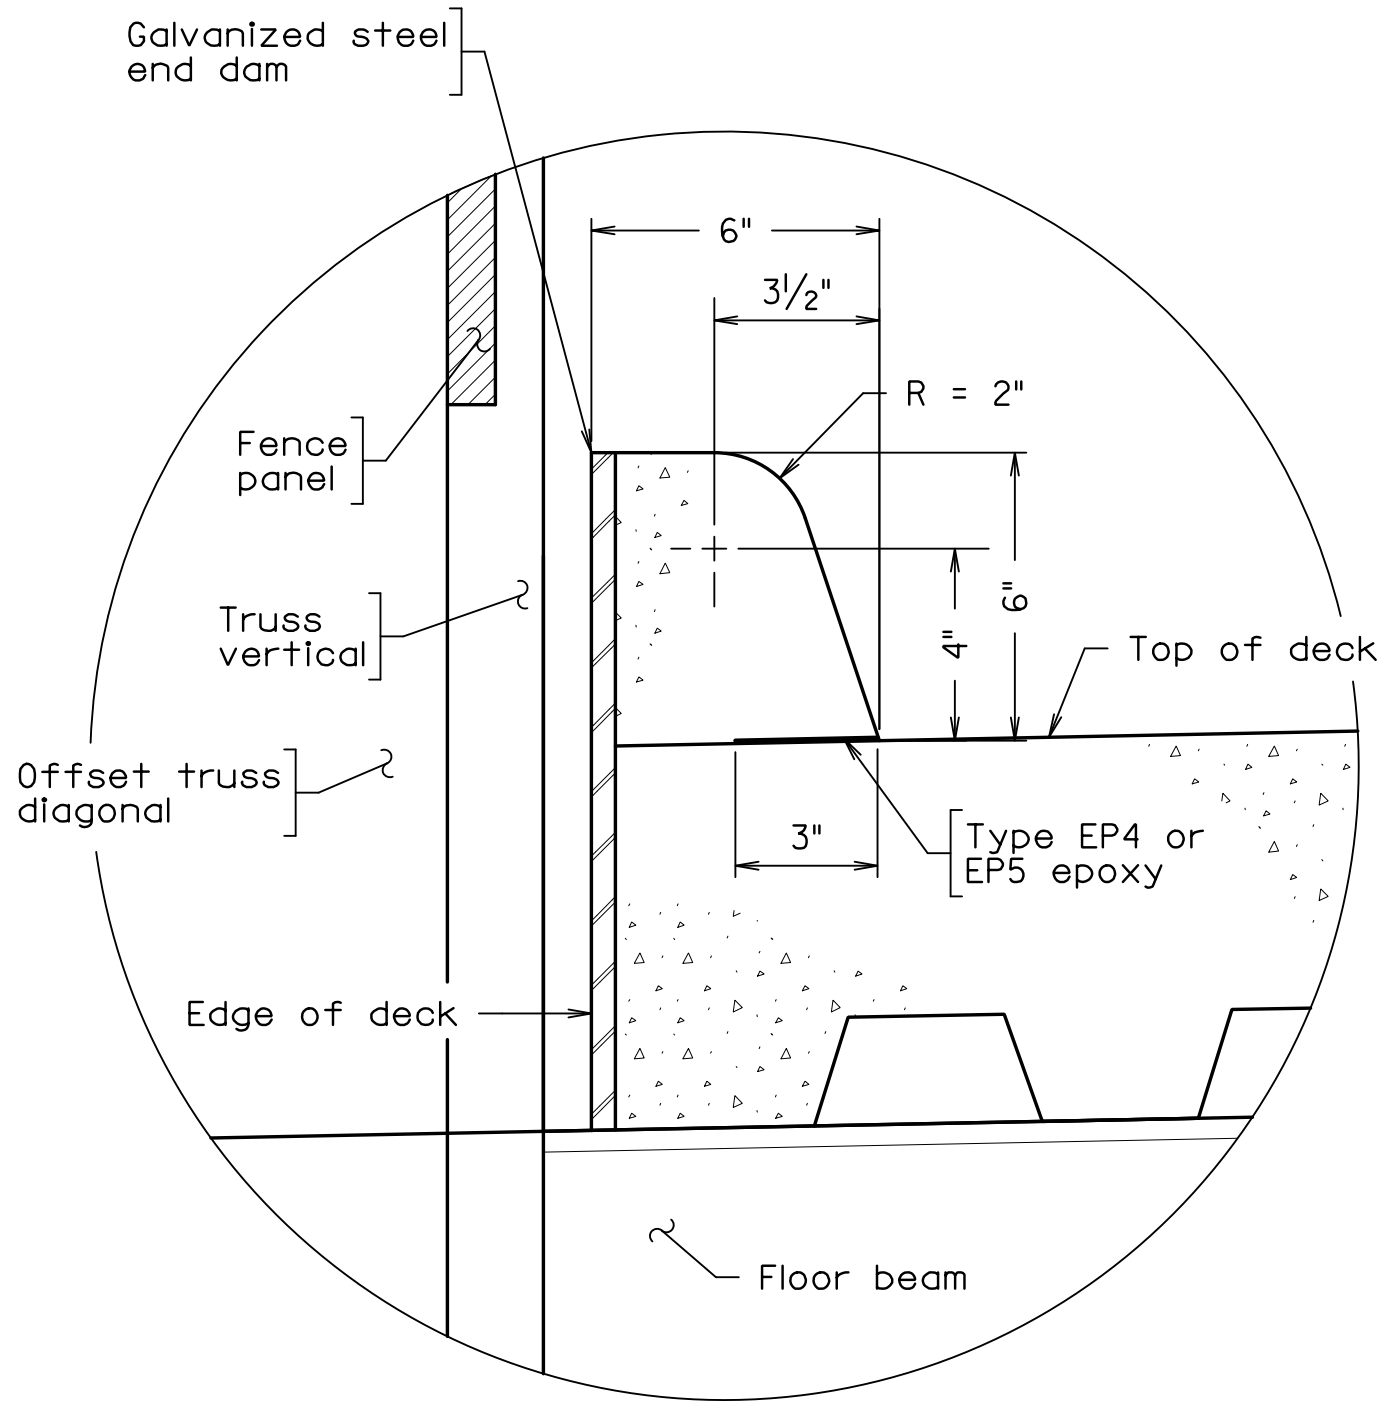


PROJECT MANAGER: SCOTT BUFFNER, P.E. (703) 877-5236  
SURVEYED BY, DATE: FAIRFAX COUNTY  
DESIGN BY: WHITMAN, REQUARDT & ASSOCIATES, LLP (703) 293-9717  
SUBSURFACE UTILITY BY, DATE: SO DEEP, INC. (703) 361-6005 December 23, 2014

STATE	FEDERAL AID		STATE	
	ROUTE	PROJECT	ROUTE	PROJECT
VA.	—	—	828	0828-029-248, B-601



TYPICAL SECTION  
Scale: 3/4" = 1'-0"



CURB DETAIL  
Scale: 3" = 1'-0"

Notes:  
Deck reinforcing steel to be designed by prefabricated steel truss fabricator.  
For Truss Details, see sheets 6(10)  
For Deck Elevations, see sheet 6(11)  
For Deck Slab Plan and Details, see sheet 6(12)  
For wire mesh fence panel details. see sheet 6(14).

PREFINAL PLANS

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FAIRFAX COUNTY, VIRGINIA					
DEPARTMENT OF PUBLIC WORKS AND ENVIRONMENTAL SERVICES					
12000 GOVERNMENT CENTER PARKWAY, SUITE 449 FAIRFAX, VA., 22035-0052					
R E V I S I O N S					OFFICE OF CAPITAL FACILITIES 703-324-5800
					WIEHLE AVENUE (RTE 828) AT W&OD TRAIL
					TRANSVERSE SECTION
					PROJECT NO: 1400102-2013
					PLAN NO. XXX-XX
S	Δ#	DESCRIPTION	BY	APPROVED	DATE
	APPROVED BY THE TRANSPORTATION DESIGN DIVISION				
					DESIGNED: JRM DRAFTED: CRR CHECKED: TAB
					SHEET 6(8)

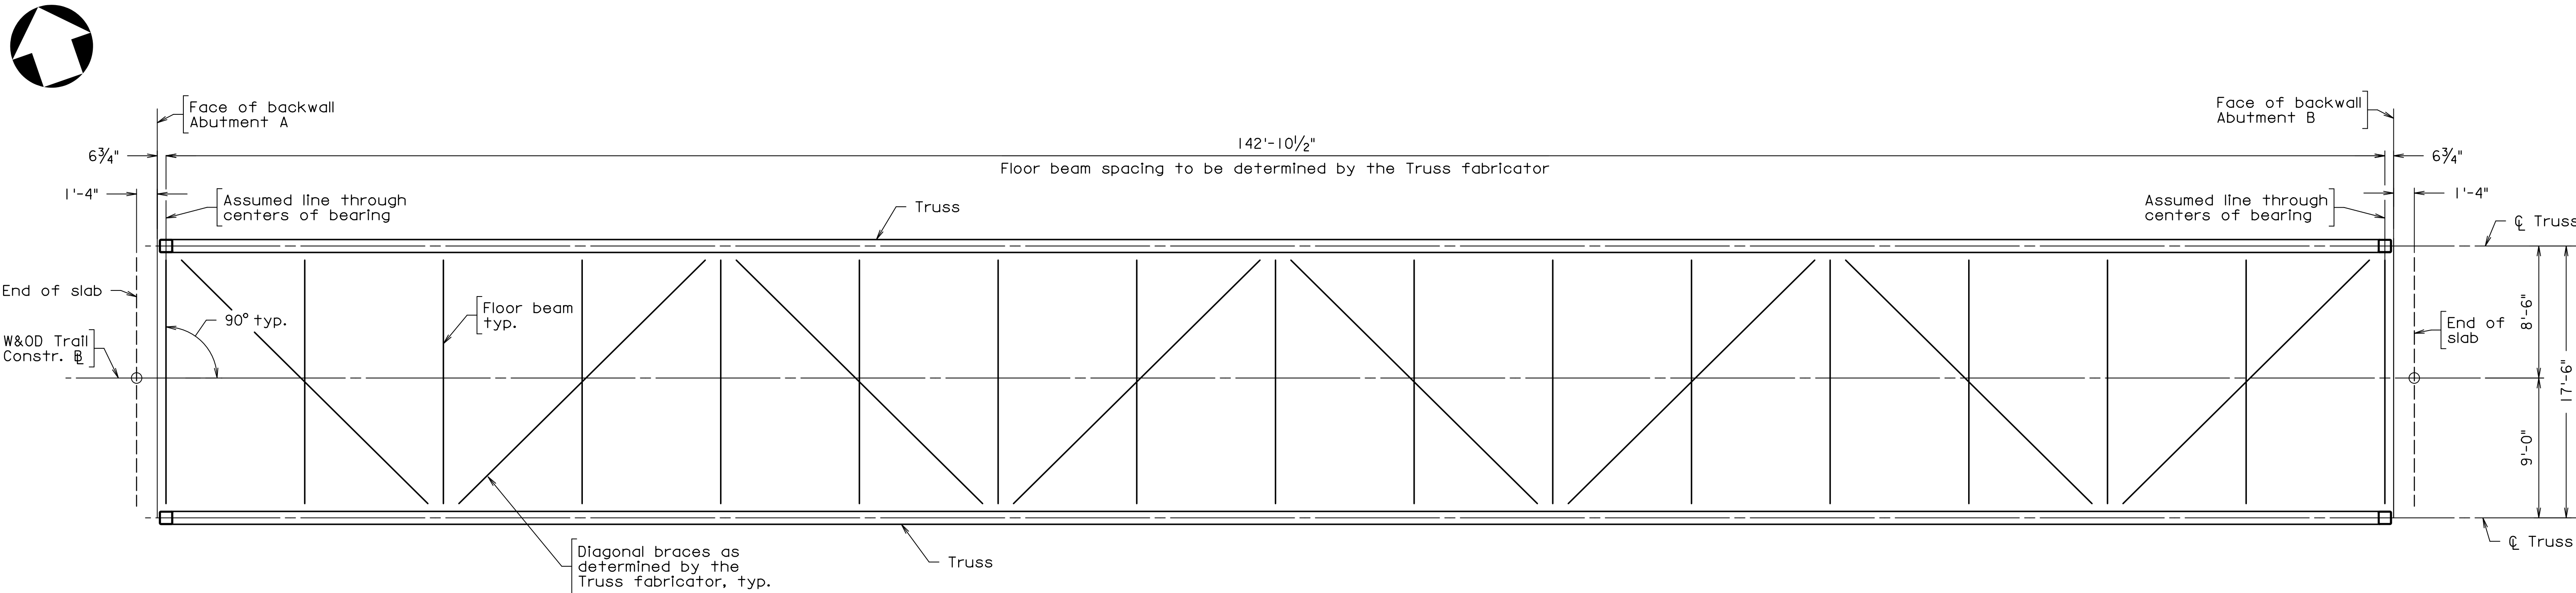
FUND # 500-C5000

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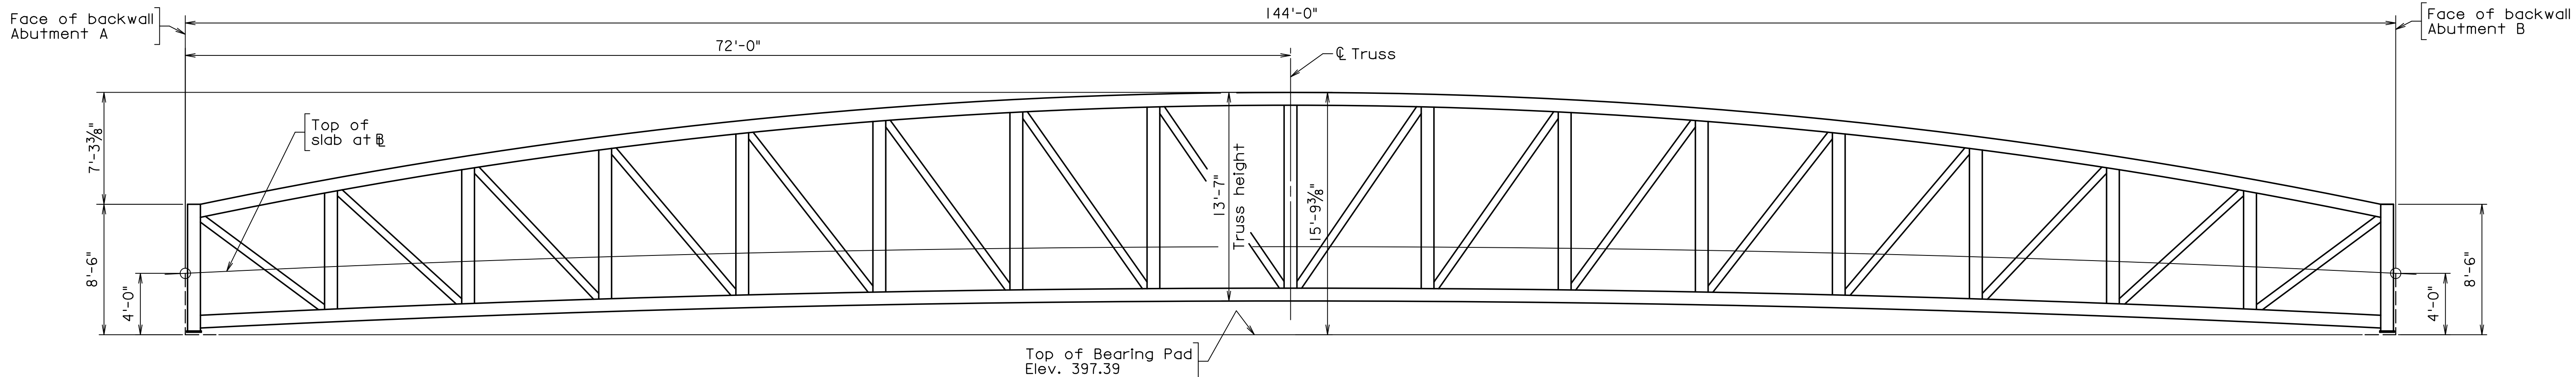


PROJECT MANAGER: SCOTT BUFFNER, P.E., (703) 877-5236  
SURVEYED BY, DATE: FAIRFAX COUNTY  
DESIGN BY: WHITMAN, REQUARDT & ASSOCIATES, LLP, (703) 293-9717  
SUBSURFACE UTILITY BY, DATE: SO DEEP, INC., (703) 361-6005, December 23, 2014

STATE	ROUTE	FEDERAL AID	ROUTE	STATE
		PROJECT		PROJECT
VA.	—	—	828	0828-029-248, B-601



FRAMING PLAN  
Scale: 3/16" = 1'-0"



CONCEPTUAL TRUSS ELEVATION

Scale: 3/16" = 1'-0"

Dimensions shown include the additional camber rise of 1.25% of bridge length

Notes:

Truss fabricator shall provide necessary details and drawings for the superstructure. These details shall include camber diagram and dead load deflection diagram. Other details included shall be those that require any necessary modifications to the substructure.

The bridge shall have a vertical camber dimension at mid-span equal to 100% of the full dead load deflection including the cast-in-place concrete deck plus 1.25% of the full length of the bridge from end of slab to end of slab.

Framing Plan shown is for concept only and used to layout and design the abutments. Truss Elevation shown is to provide the general proportions desired for aesthetics. Contractor shall coordinate any changes with the Engineer and Owner.

For transverse section, see sheet 6(8).

For additional details and requirements for the prefabricated steel truss, see sheet 6(10) and the special provisions.

PREFINAL PLANS

EMERGENCY POLICE - FIRE - RESCUE 911					
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OFFICE OF CAPITAL FACILITIES 703-324-5800					
WIEHLE AVENUE (RTE 828) AT W&OD TRAIL					
FRAMING PLAN					
PROJECT NO: 1400102-2013					
PLAN NO. XXX-XX		DESIGNED: JRM DRAFTED: CRR CHECKED: TAB		SHEET 6(9)	
APPROVED BY THE TRANSPORTATION DESIGN DIVISION					

WHITMAN REQUARDT & ASSOCIATES  
RICHMOND, VA  
STRUCTURAL ENGINEER

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Δ# DESCRIPTION BY APPROVED DATE

FUND # 500-C5000

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PROJECT MANAGER: SCOTT L. BUFFNER, P.E., (703) 287-5236  
SURVEYED BY, DATE: FAIRFAX COUNTY  
DESIGN BY: WHITMAN, REQUARDT & ASSOCIATES, LLP, (703) 293-9717  
SUBSURFACE UTILITY BY, DATE: SO DEEP, INC. (703) 361-6005, December 23, 2014

STATE	FEDERAL AID		STATE	
	ROUTE	PROJECT	ROUTE	PROJECT
VA.	---	---	828	0828-029-248, B-601

### TRUSS SUPERSTRUCTURE REQUIREMENTS:

One simple span, 142'-10 1/2" (measured from centerline of bearing to centerline of bearing), 146'-8" (measured from end of slab to end of slab), with a clear trail width of 16'-0" face of curb to edge of deck.

Price bid shall include design, fabrication, delivery, construction and all materials, labor, tools, equipment and incidentals necessary to complete the work.

The Contractor shall arrange to have a representative of the prefabricated truss superstructure supplier at the bridge site during erection to provide technical assistance in planning and erecting the superstructure. Cost of the representative shall be included in the bid price for Prefabricated Steel Truss Superstructure.

### STRUCTURAL STEEL:

The shop drawings shall note the material specification and grade for all structural steel and hardware.

All truss members, including gusset and splice plates, floor beams, stringers and any other components designated as main load carrying members subject to calculated tension or stress reversal shall meet the Zone 2 Charpy V Notch Impact strength requirements as specified in Section 226 of the Specifications. Design/Shop drawings shall clearly define those members or components requiring CVN testing.

Design/Shop drawings shall clearly define those members or components considered fracture critical by the AASHTO Guide Specifications for Fracture Critical Non-Redundant Steel Bridge Members.

Manufacturer shall design all connections for welded tubular steel members in accordance with Chapter K of the Specifications and Commentary of the AISC Steel Construction Manual, 13th Edition (with latest revisions) and all other applicable codes and standards.

Field splices of the truss and floor beam connections shall be made using high strength bolts and shall be designed as a slip-critical connection with a Class B surface. Splice design shall be designed for oversized holes but be detailed for standard holes in accordance with VDOT ILM-S&B-80.5.

All fasteners, unless otherwise noted, shall be 7/8" diameter high strength bolts, ASTM A325 galvanized with ASTM A563 Grade DH nut and one ASTM F436 washer per bolt and manufactured in accordance with Section 226 of the Specifications.

Fasteners shall be installed and tightened in accordance with the VDOT Specifications. Immediately prior to erection, all faying surfaces of high strength bolted connections shall be roughened by hand wire brushing. Power wire brushing is not allowed.

Steel trusses shall be fabricated in such a way as to provide a low chord profile that follows the profile grade line when subjected to final dead loads.

Design shop drawings shall provide complete details and dimensions of the bearing assembly to ensure proper size and elevation of bearing seats have been established.

### PAINTING AND SURFACE PREPARATION:

All structural steel within 5'-0" of face of backwall shall be painted to match weathering steel color. Bearing plates and hardware shall be galvanized.

Finish paint color shall be brown, 595-20059.

Paint material shall be in accordance with VDOT Specifications Section 231. Painting shall be in accordance with VDOT Specifications Section 411. Any damage prior to delivery to the bridge site shall be replaced or repaired at the fabricator's expense and at no additional cost to the Department.

The fabricator shall submit an original and two copies of the coating applicator's notarized Certificate of Compliance that the prepared painted coating surfaces meets or exceeds the requirements for successful painting of the surface.

All paint that has been chipped or damaged during handling or welding shall be power brushed and painted with two coats of paint meeting the requirements of Section 411 of the Specifications. Spray cans shall not be used.

### WELDING AND NON-DESTRUCTIVE TESTING:

All fabrication, welding, non-destructive testing and visual inspection shall be in accordance with the requirements of the ANSI/AASHTO/AWS Bridge Welding Code D1.5. Welding shall be accomplished using electrodes and procedures acceptable to the Engineer. Field welds will not be permitted without prior approval from the Engineer.

### BRIDGE DECK:

Bridge deck shall be 6" min. concrete. Permanent stay-in-place forms and edge dams may be used. The end of the deck slab extension at Abutments A and B shall incorporate a drip groove detail as shown on sheet 6(12).

Bridge deck shall be finished to a Class 7, Sidewalk Finish, in accordance with the VDOT specifications.

Deck reinforcing design, including curb and slab extension, shall be the responsibility of the Contractor and shall be in accordance with AASHTO LRFD Bridge Design Specification, 7th Edition, 2014; VDOT Modifications; and ILM-S&B-80.5. Contractor shall submit deck slab design calculations and shop drawings for approval prior to construction. It is the Contractor's responsibility to coordinate curb and deck reinforcement, and curb reinforcement shall be included in deck reinforcing shop drawings. Reinforcing bars shall be Corrosion Resistant Reinforcing (CRR) Class I.

Control and expansion joints shall be designed and detailed by the Contractor to meet the requirements of the VDOT Structure and Bridge Design Manual and the VDOT specifications.

The Contractor shall submit design calculations and shop drawings for a proposed stay-in-place form system for deck slab extensions at each end of the truss.

For additional deck details, see sheet 6(12).

### PEDESTRIAN FENCE:

For wire mesh fence panel details, see sheets 6(14).

### ANCHOR BOLTS:

Contractor shall be responsible for the design of bearing anchor bolts in accordance with AASHTO LRFD Bridge Design Specifications, 7th Edition, 2014; and VDOT modifications for the bridge superstructure and bearings supplied. Contractor shall submit anchor bolt design calculations and shop drawings for approval prior to construction.

Anchor bolts shall conform to ASTM F1554 Grade 55, and be galvanized.

Superstructure related loads used to design the substructure elements are shown in the table below. The loads shown are unfactored.

UNFACTORED DESIGN LOADS	Max. Truss Bearing Shoe Reaction
	Kip
Dead load (DC) *	97
Future Wearing Surface - 20 psf (DW)	12
Pedestrian Live - 90 psf (PL)	53
H10 Vehicle Live (LL)	20
Wind on structure (WS) - Vertical	± 26
Wind on structure - Overturning 20 psf (WS) - Vertical	-41
Wind on structure (WS) - Lateral	17
Friction Longitudinal - Thermal, etc. (FR)	17

Positive values for vertical loads are downward.  
Lateral and longitudinal loads are reversible.

\* Includes truss, concrete deck, concrete curb, construction load (20 psf), and pedestrian fence.

#### SECTION AT FLOORBEAM

Section near midspan

#### SECTION AT ABUTMENT B

Section at Abutment A  
similar, opposite hand.

#### TRANSVERSE SECTION

Scale: 1/2" = 1'-0"

View is looking upstation. Deck reinforcing not shown

### STEEL SUPERSTRUCTURE:

These plans and associated Special Provisions are for a fully engineered clear span steel superstructure and shall be regarded as the minimum standards for design and construction.

The prefabricated steel truss superstructure shall be a welded/bolted weathering steel truss bridge and shall be designed by the Contractor. Floor beam and stringer connections shall be bolted. Welding of lateral bracing to the flooring system shall not be permitted. Lower chord members shall allow for free drainage and be configured as to not capture debris.

The superstructure shall be designed for 90 psf pedestrian loading and H-10 vehicle loading in accordance with AASHTO LRFD Bridge Design Specification, 7th Edition, 2014; and VDOT modifications; and AASHTO LRFD Guide Specifications for Design of Pedestrian Bridges, 2nd Edition, 2009. All design calculations shall be according to Load and Resistance Factor Design. Design loading allowances for construction tolerances are given in VDOT Modifications to AASHTO (ILM-S&B-80.5).

Superstructure design calculations, shop fabrication drawings and detailed field erection and installation procedures shall be approved by the Engineer prior to fabrication and erection. Design calculations, shop drawings and field erection and installation procedures shall be accomplished under the hand and seal of a Professional Engineer registered to practice in the Commonwealth of Virginia.

The Contractor is advised that substructure details shown in these plans are based on an assumed superstructure. The Contractor shall be responsible for determining the substructure modifications (both structural and geometric) required for the superstructure they propose. Plans reflecting any additional modifications shall be sealed by a Professional Engineer holding a valid license to practice engineering in the Commonwealth of Virginia and shall be submitted to the Engineer for approval prior to commencement of work at no additional cost to the County.

A low chord elevation based on Transverse Section, this sheet, was used in the vertical clearance calculations. The calculations were based on the assumed superstructure and any modifications to the low chord elevation shall be submitted to the Engineer for review and approval.

#### PREFINAL PLANS

EMERGENCY POLICE - FIRE - RESCUE 911				
FAIRFAX COUNTY, VIRGINIA				
DEPARTMENT OF PUBLIC WORKS AND ENVIRONMENTAL SERVICES				
12000 GOVERNMENT CENTER PARKWAY, SUITE 449 FAIRFAX, VA., 22035-0052				
R E V I S I O N S				
OFFICE OF CAPITAL FACILITIES 703-324-5800				
WIEHLE AVENUE (RTE 828) AT W&OD TRAIL				
PREFABRICATED STEEL TRUSS DETAILS				
PROJECT NO: 1400102-2013				
PLAN NO. XXX-XX		DESIGNED: JRM DRAFTED: CRR CHECKED: TAB		SHEET 6(10)
APPROVED BY THE TRANSPORTATION DESIGN DIVISION				
FUND # 500-C5000				

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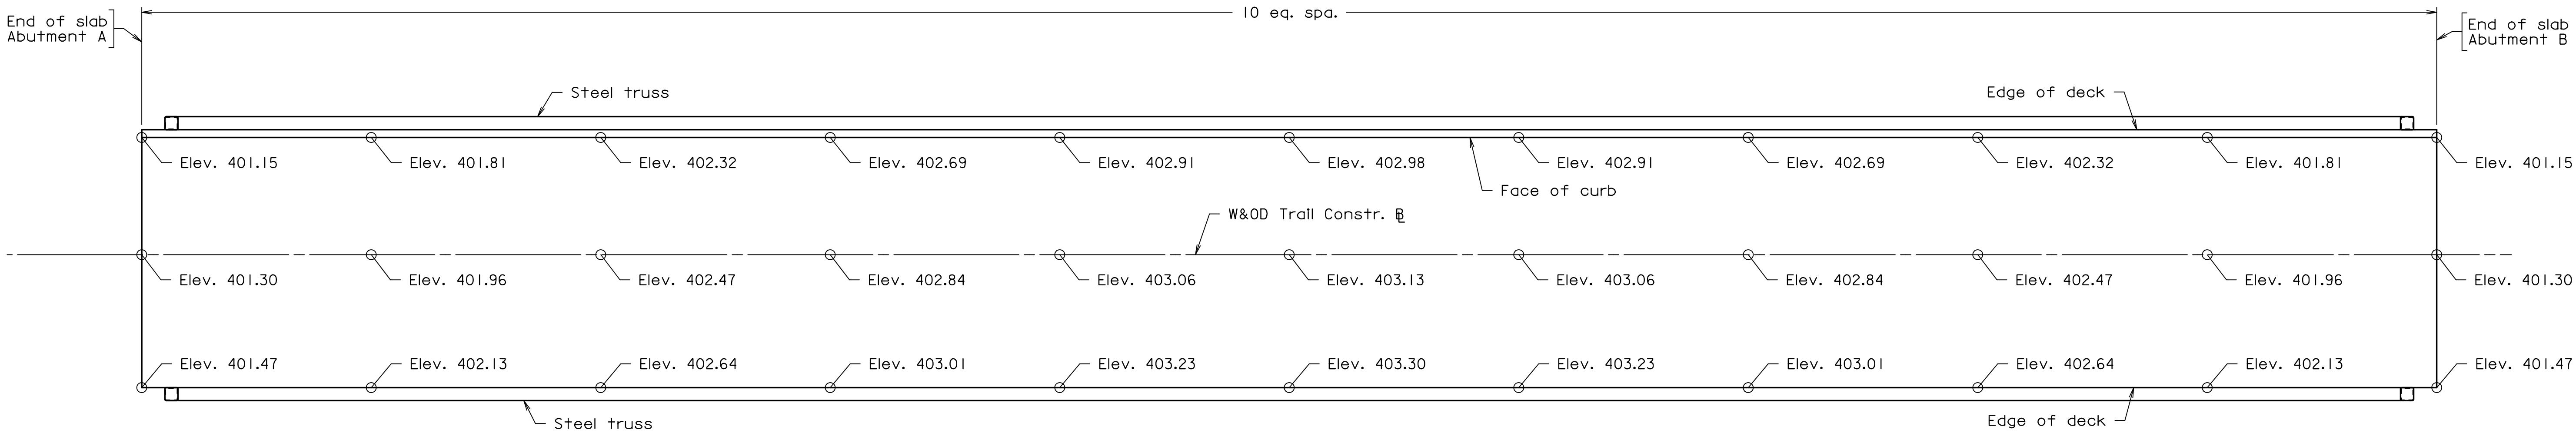
PROJECT MANAGER: SCOTT, BUFFNER, P.E., (703) 877-5136  
SURVEYED BY, DATE: FAIRFAX COUNTY  
DESIGN BY: WHITMAN, REQUARDT & ASSOCIATES, LLP, (703) 293-9717  
SUBSURFACE UTILITY BY, DATE: SO, DEEP, INC., (703) 361-6005, December 23, 2014

STATE	FEDERAL AID		STATE	
	ROUTE	PROJECT	ROUTE	PROJECT
VA.	—	—	828	0828-029-248, B-601

Notes:

Deck slab elevations are on finished grade at face of curb and edge of deck. Those shown on W&OD Trail Constr. are at point of finished grade denoted on Transverse section.

Points along the face of curb and edge of deck are aligned perpendicular to W&OD Trail Constr. unless otherwise shown. Straight line interpolations for intermediate elevations on top of finished roadway may be made in any direction between any two adjacent points.



DECK SLAB ELEVATIONS  
Scale: 3/16" = 1'-0"

PREFINAL PLANS

EMERGENCY POLICE - FIRE - RESCUE 911

FAIRFAX COUNTY, VIRGINIA  
DEPARTMENT OF PUBLIC WORKS AND ENVIRONMENTAL SERVICES  
12000 GOVERNMENT CENTER PARKWAY, SUITE 449 FAIRFAX, VA., 22035-0052

OFFICE OF CAPITAL FACILITIES  
703-324-5800

WIEHLE AVENUE (RTE 828) AT W&OD TRAIL

DECK SLAB ELEVATIONS

PROJECT NO: 1400102-2013

PLAN NO. XXX-XX	DESIGNED: JRM DRAFTED: CRR CHECKED: TAB	SHEET 6(11)
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APPROVED BY THE TRANSPORTATION DESIGN DIVISION

FUND # 500-C5000

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PROJECT MANAGER: SCOTT, BUFFNER, P.E., (703) 877-5236  
SURVEYED BY, DATE: FAIRFAX COUNTY  
DESIGN BY: WHITMAN, REQUARDT & ASSOCIATES, LLP, (703) 293-9717  
SUBSURFACE UTILITY BY, DATE: SO DEEP, INC., (703) 361-6005, December 23, 2014


STATE	FEDERAL AID		STATE	
	ROUTE	PROJECT	ROUTE	PROJECT
VA.	—	—	828	0828-029-248, B-601

Notes:


For prefabricated truss details and cast-in-place deck slab design requirements, see sheet 6(10).

Deck reinforcing to be designed by prefabricated steel truss fabricator.

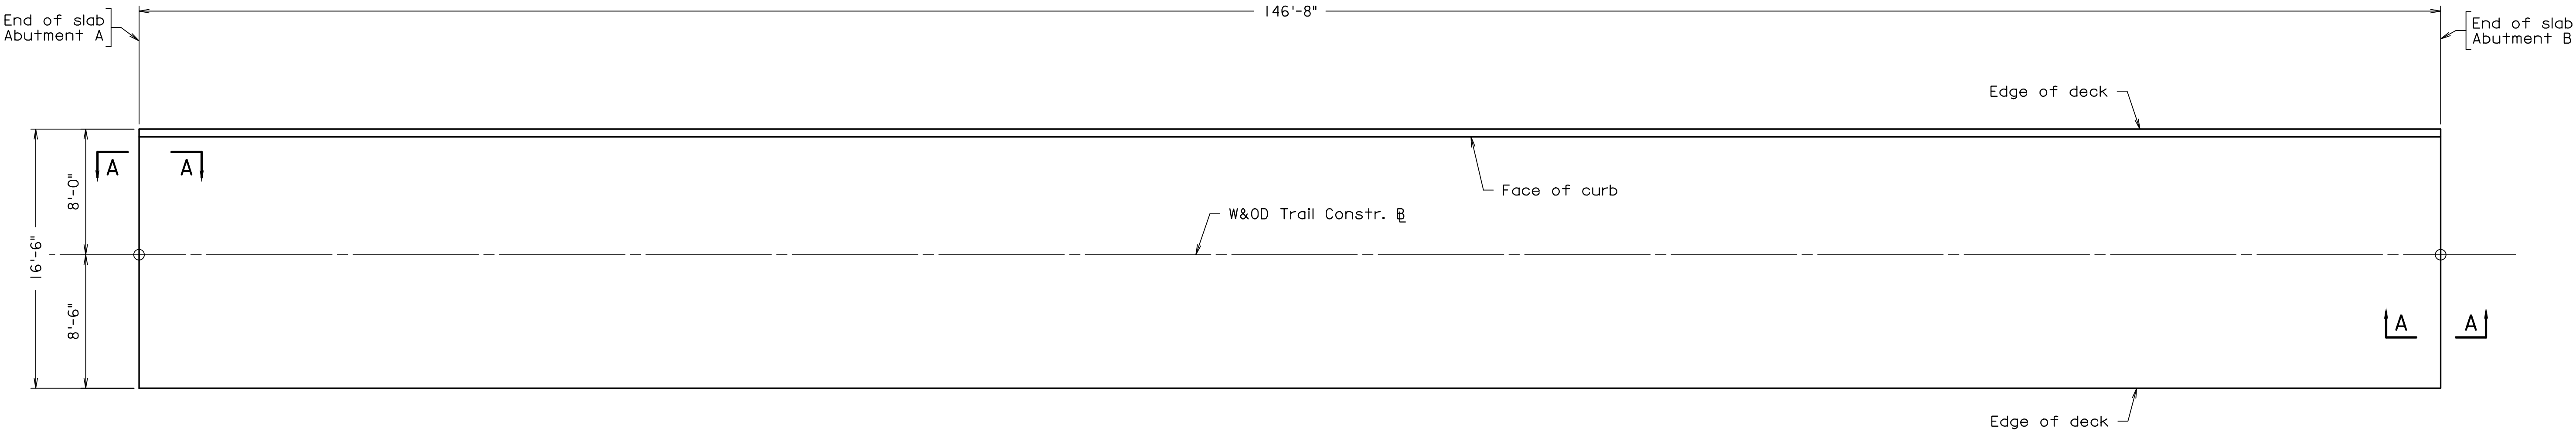
Deck slab concrete placement schedule shall be provided by prefabricated steel truss fabricator and submitted for review by the engineer. If the deck is cast in one pour, the concrete shall be maintained in a plastic state throughout the entire placement operation.



DECK SLAB PLAN  
Scale: 3/16" = 1'-0"

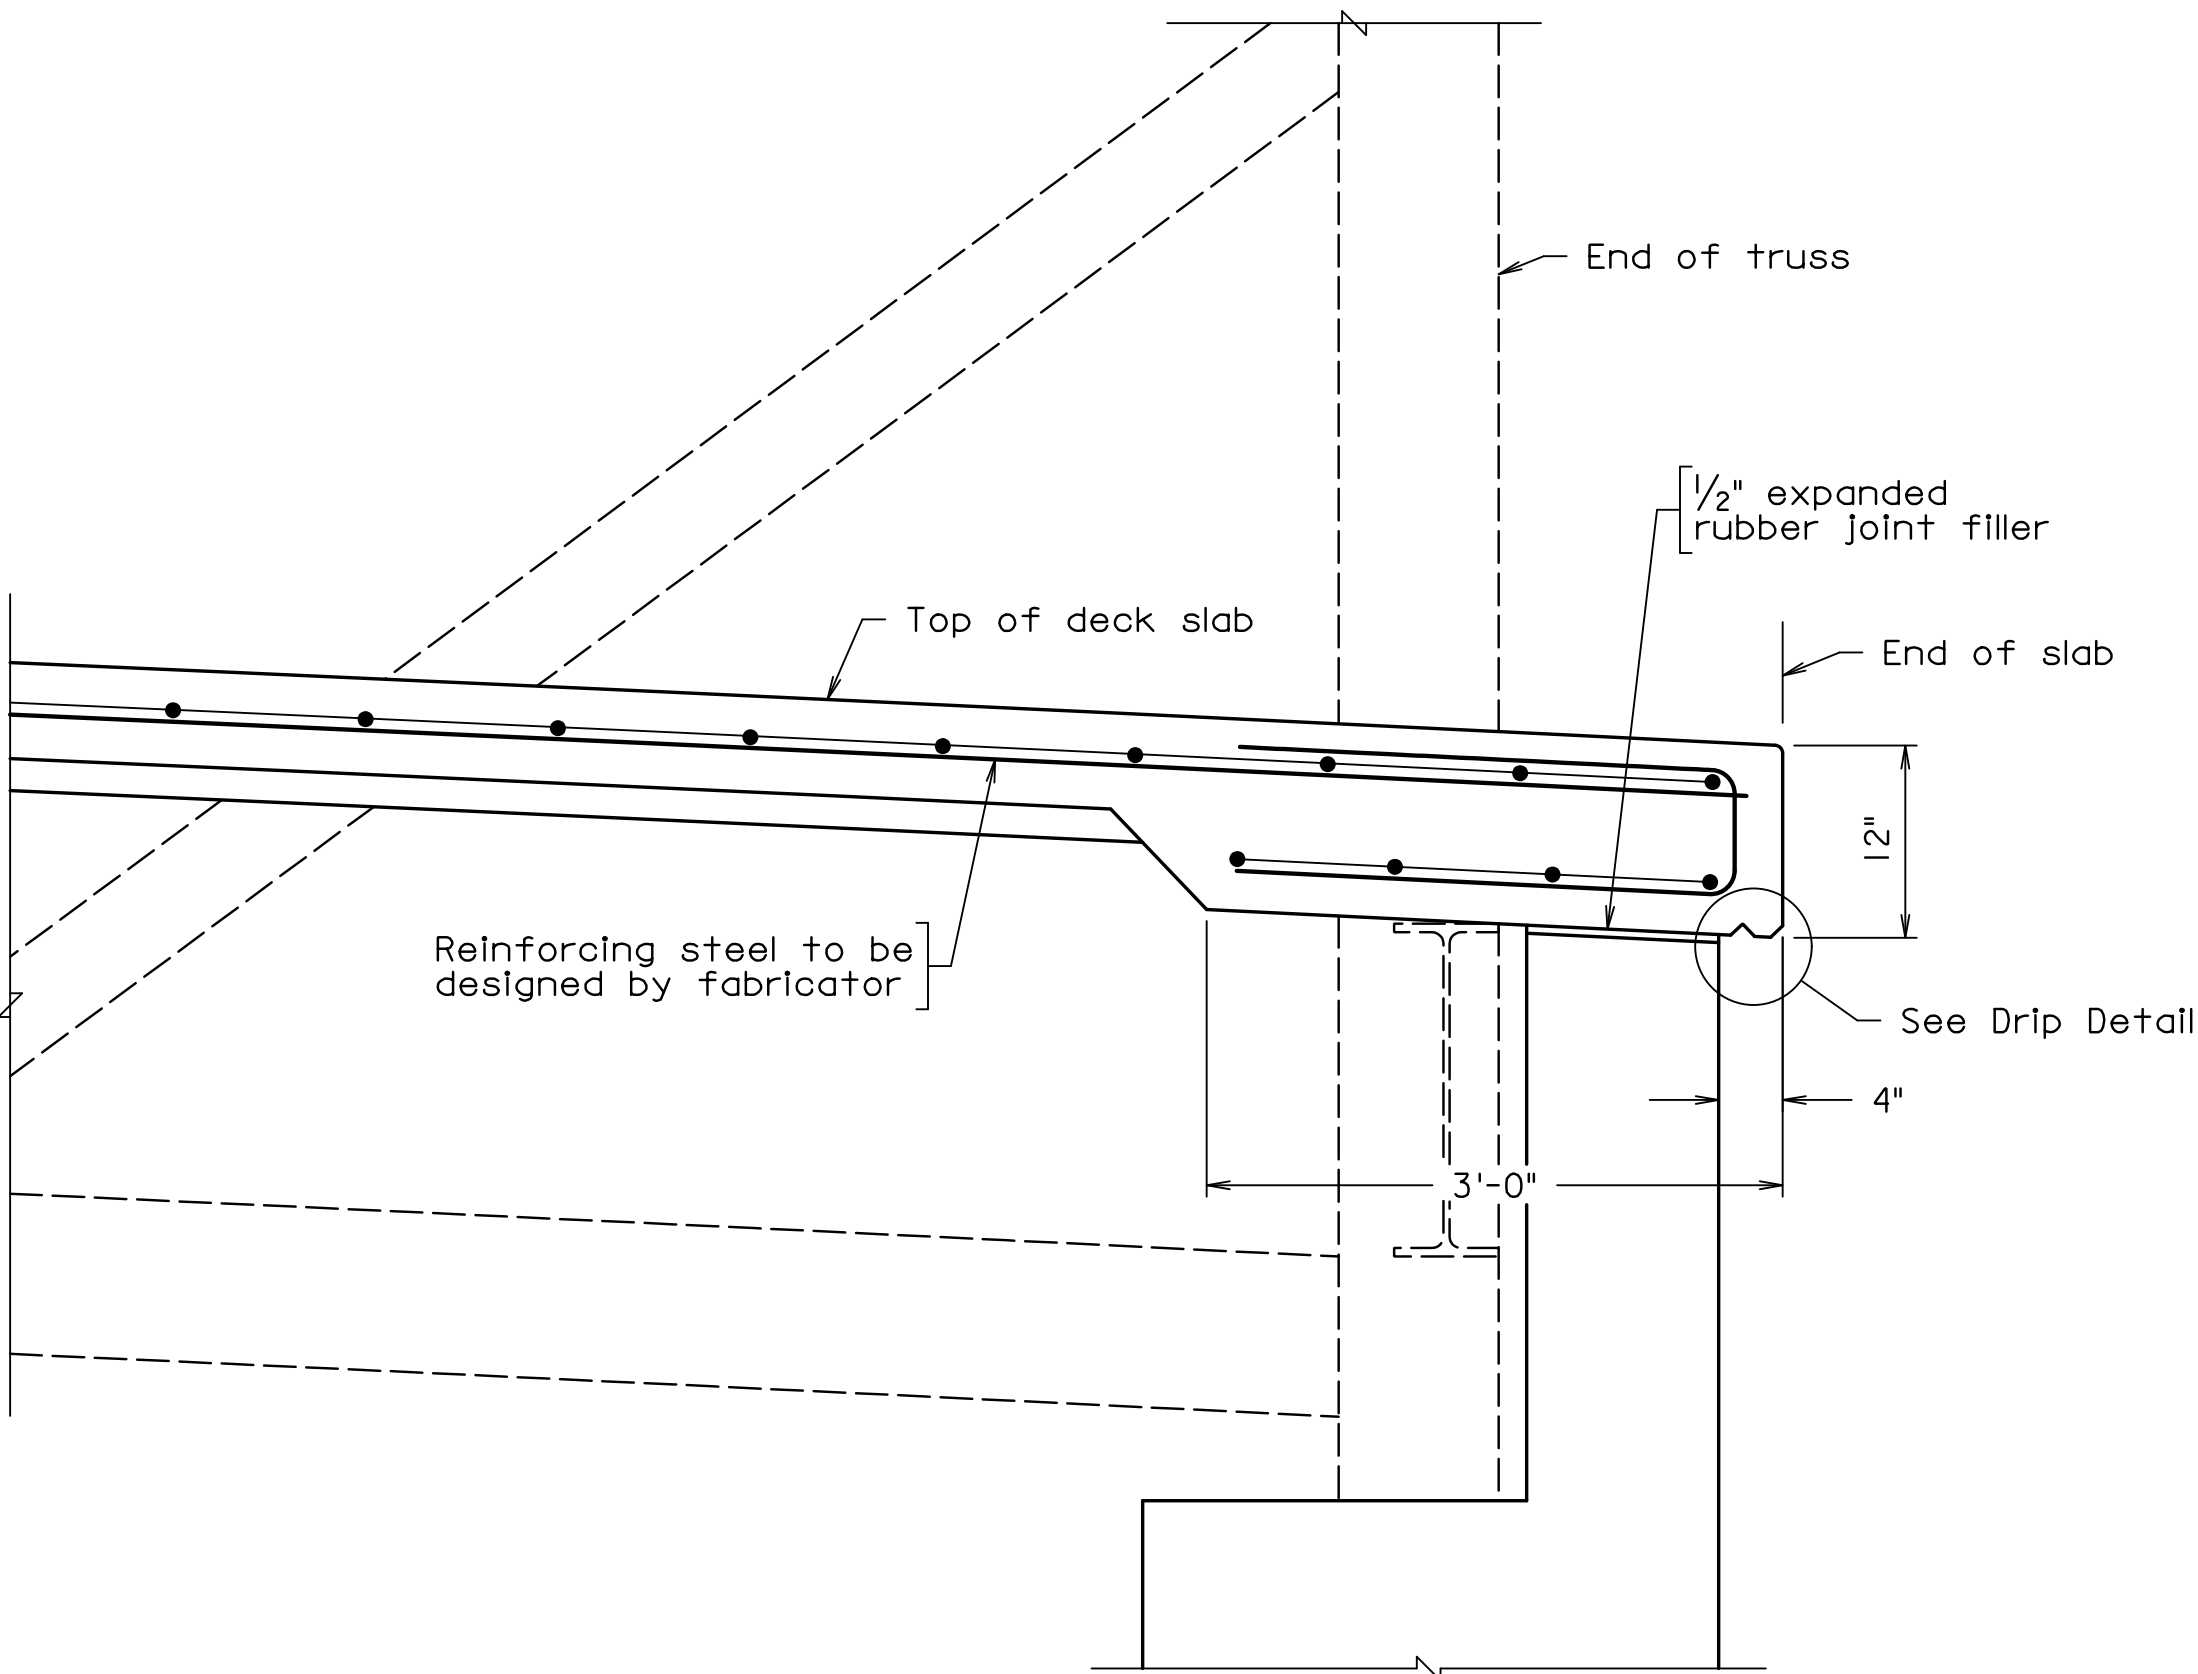

SECTION A-A  
Scale: 1" = 1'-0"

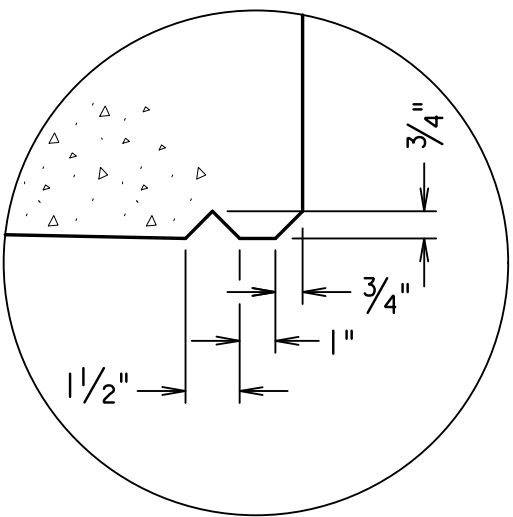

DRIP DETAIL  
Not to scale

PREFINAL PLANS


EMERGENCY POLICE - FIRE - RESCUE 911								
FAIRFAX COUNTY, VIRGINIA								
DEPARTMENT OF PUBLIC WORKS AND ENVIRONMENTAL SERVICES								
12000 GOVERNMENT CENTER PARKWAY, SUITE 449 FAIRFAX, VA., 22035-0052								
R  E  V  I  S  O  N  S						OFFICE OF CAPITAL FACILITIES 703-324-5800		
						WIEHLE AVENUE (RTE 828) AT W&OD TRAIL		
						DECK SLAB PLAN AND DETAILS		
						PROJECT NO: 1400102-2013		
						PLAN NO. XXX-XX	DESIGNED: JRM DRAFTED: CRR CHECKED: TAB	SHEET 6(12)
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WHITMAN REQUARDT & ASSOCIATES RICHMOND, VA STRUCTURAL ENGINEER								
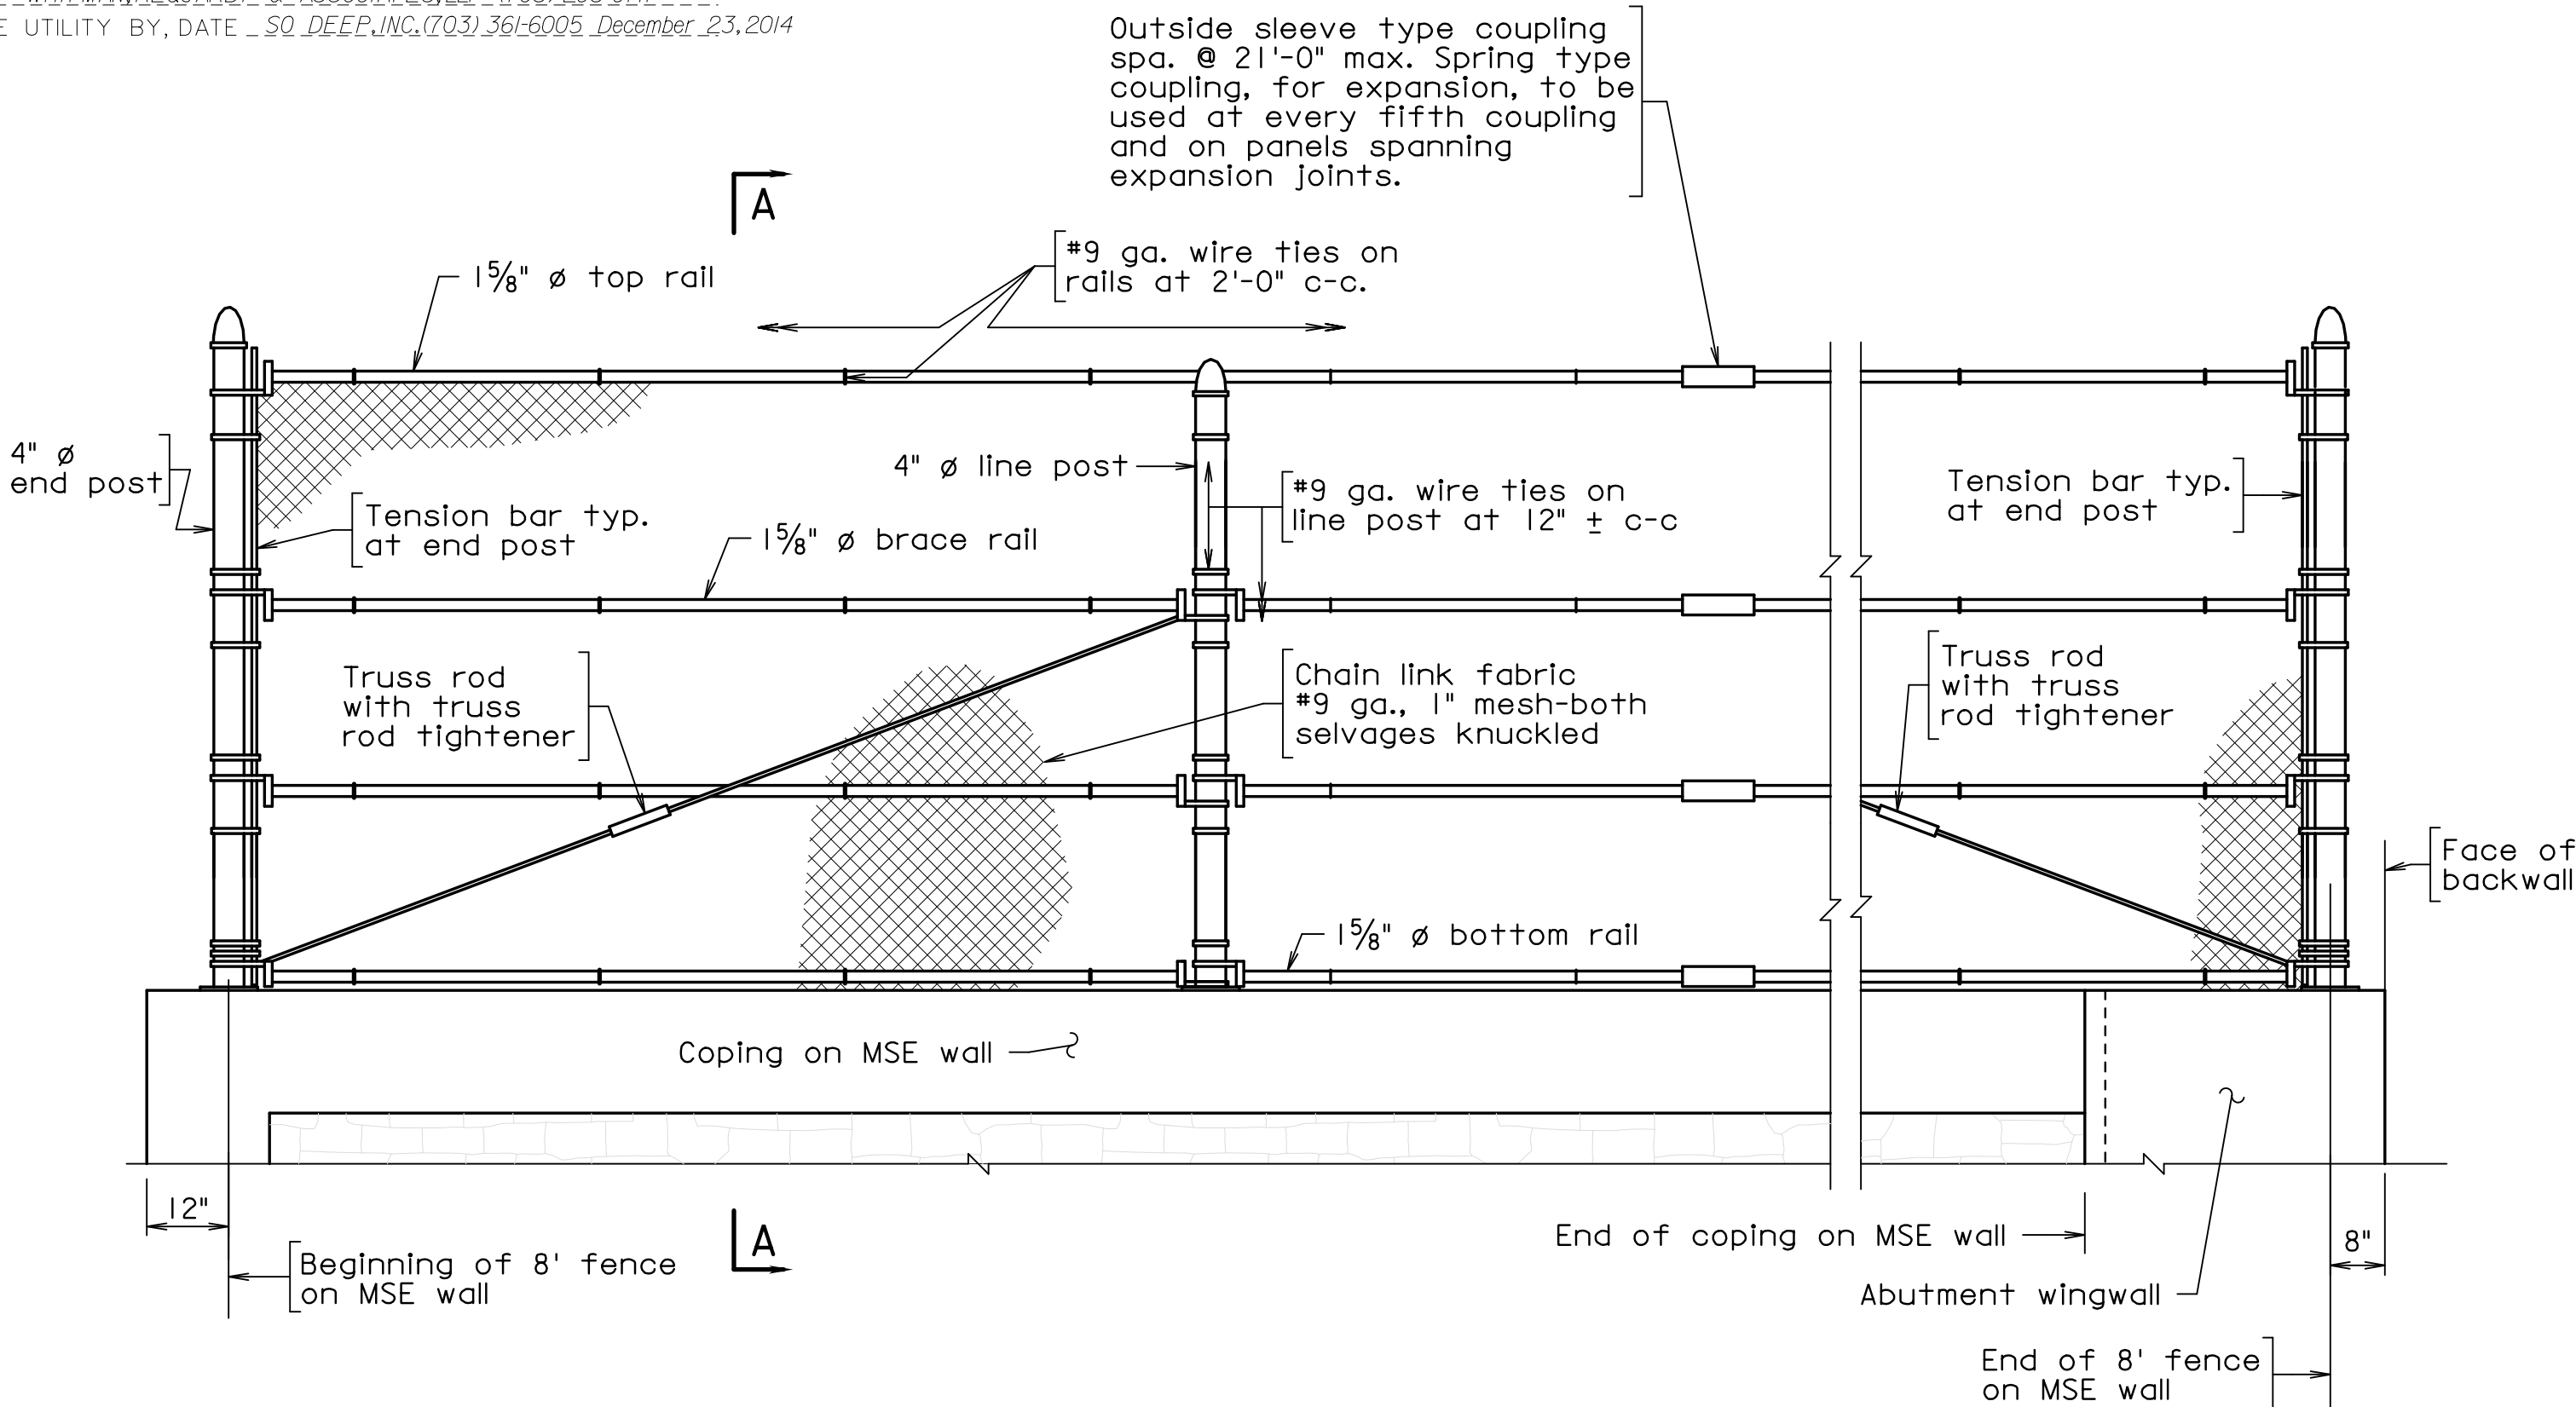
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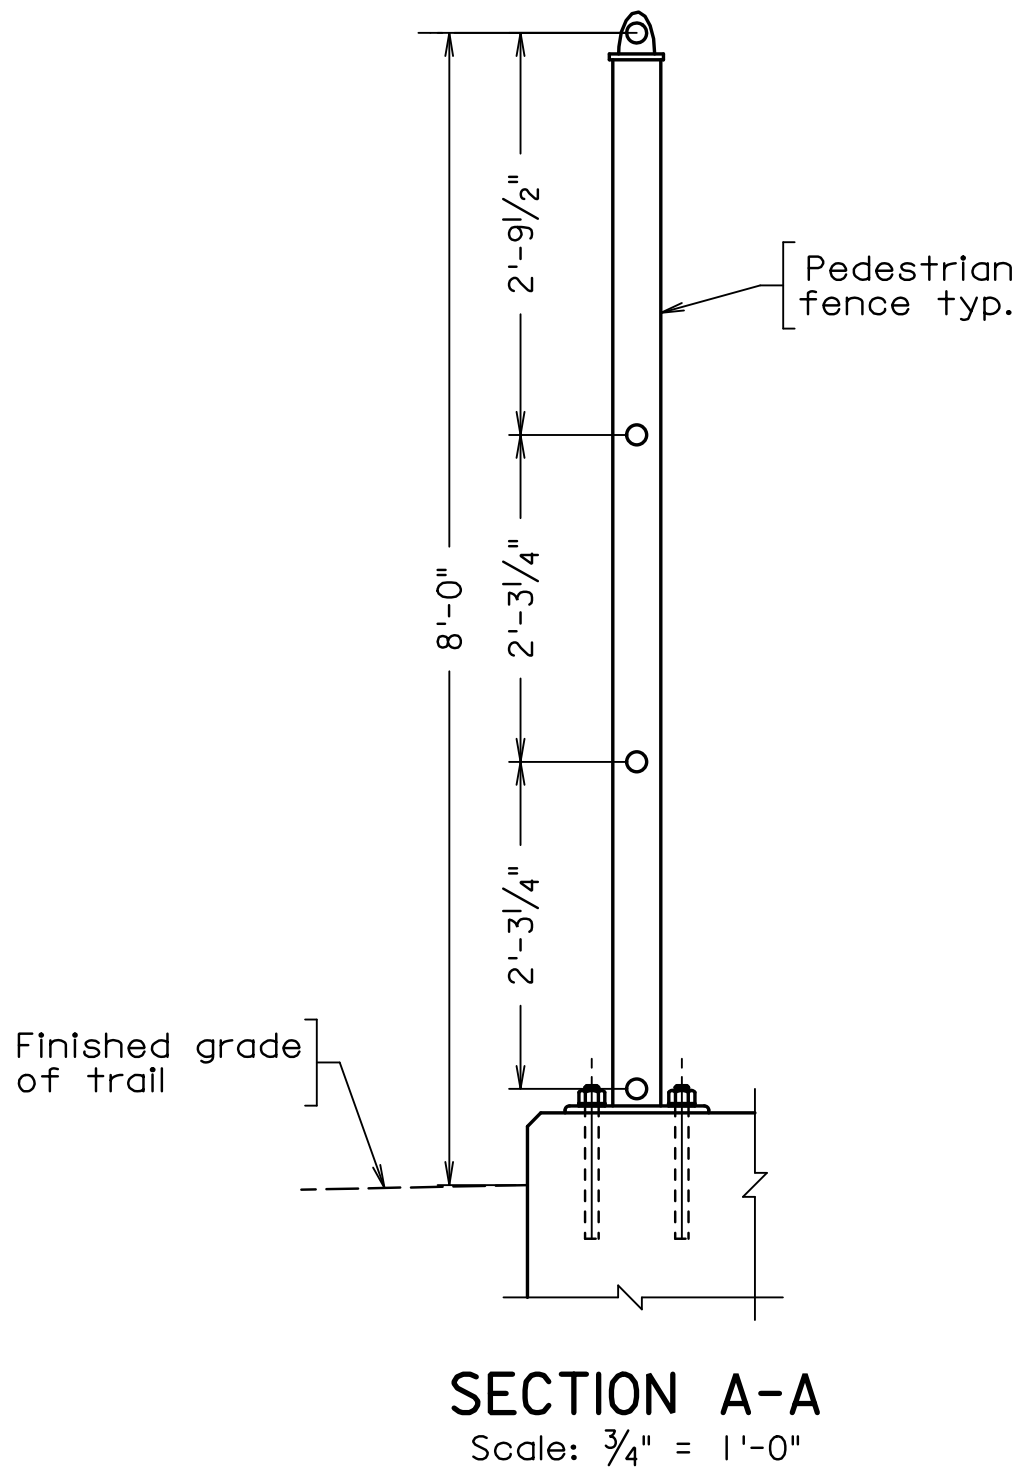


PROJECT MANAGER: SCOTT, BUFFNER, P.E. (703) 877-5236  
SURVEYED BY, DATE: FAIRFAX COUNTY  
DESIGN BY: WHITMAN, REQUARDT & ASSOCIATES, LLP (703) 293-9717  
SUBSURFACE UTILITY BY, DATE: SO DEEP, INC. (703) 361-6005 December 23, 2014

STATE	ROUTE	FEDERAL AID	ROUTE	STATE
		PROJECT		PROJECT
VA.	—	—	828	0828-029-248, B-601



ELEVATION OF 8 FOOT FENCE ON SUBSTRUCTURE  
Not to scale



Notes:

Posts shall be set vertical. Rails shall be set parallel to the top of base of railing.

Spacing of posts to be equally spaced. Maximum spacing of posts shall not exceed 10'-0".

Chain link fabric shall be placed on inside of posts and rails.

Chain link fabric, posts, rails, bolts excluding threads, and other associated hardware shall be black vinyl coated.

Bolt threads shall not be galvanized or coated.

Ends of wire ties shall be turned to outside of fence to prevent injury to pedestrians.

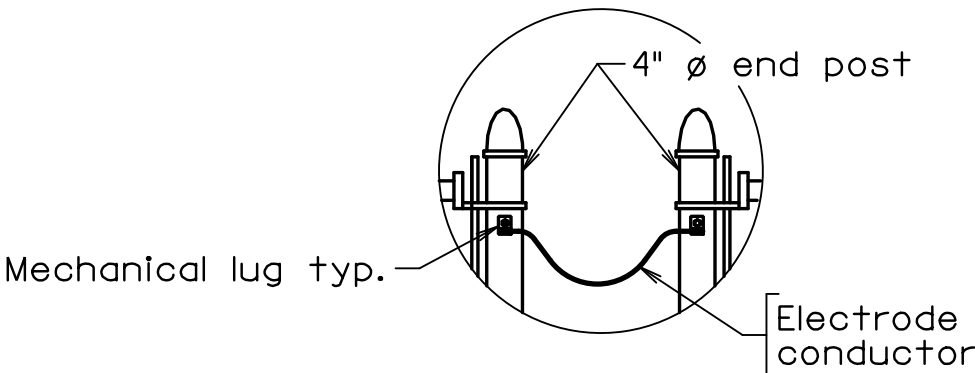
All bolts shall be high strength (ASTM A325).

All welded or seamless steel galvanized pipe shall conform to ASTM F1083, Schedule 40.


Fence framing (posts and railing) shall be grounded in accordance with Section 507.

Contractor to provide design details of post to concrete coping connection for review.


For details of the Wire Mesh Fence Panels, see sheet 6(14).



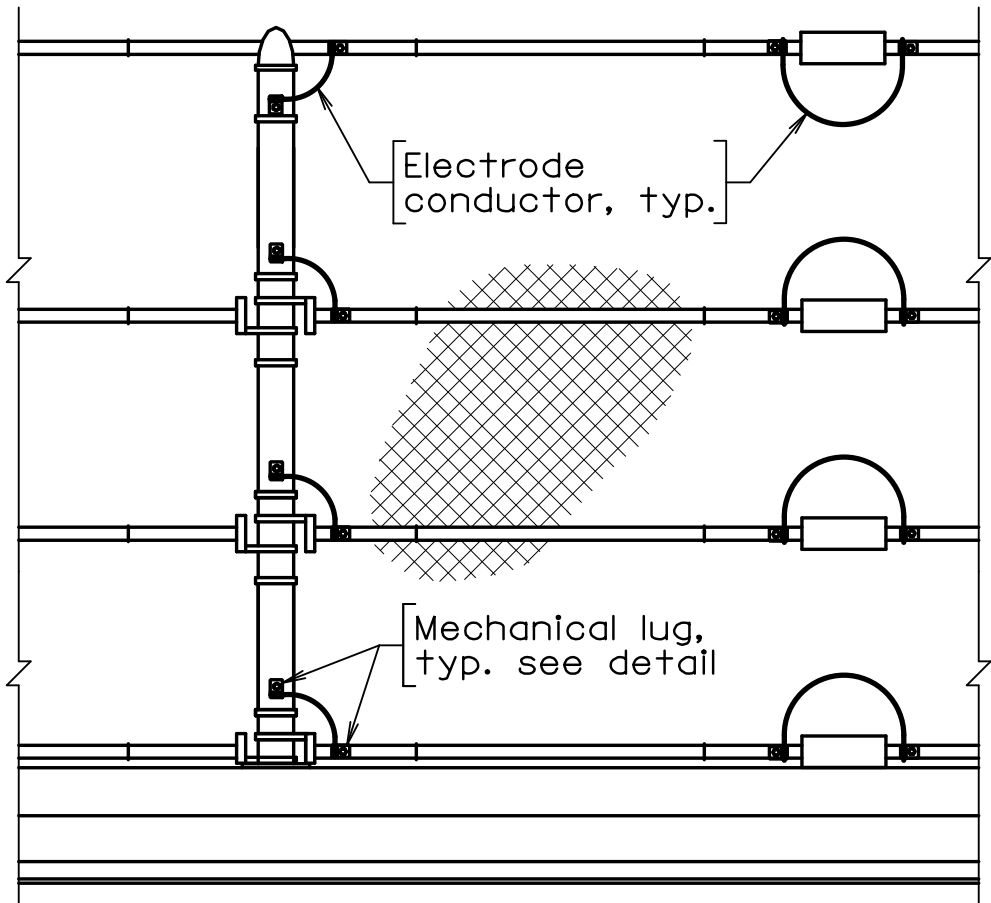
ELECTRICAL CONTINUITY  
(On Open Joint)  
Not to scale



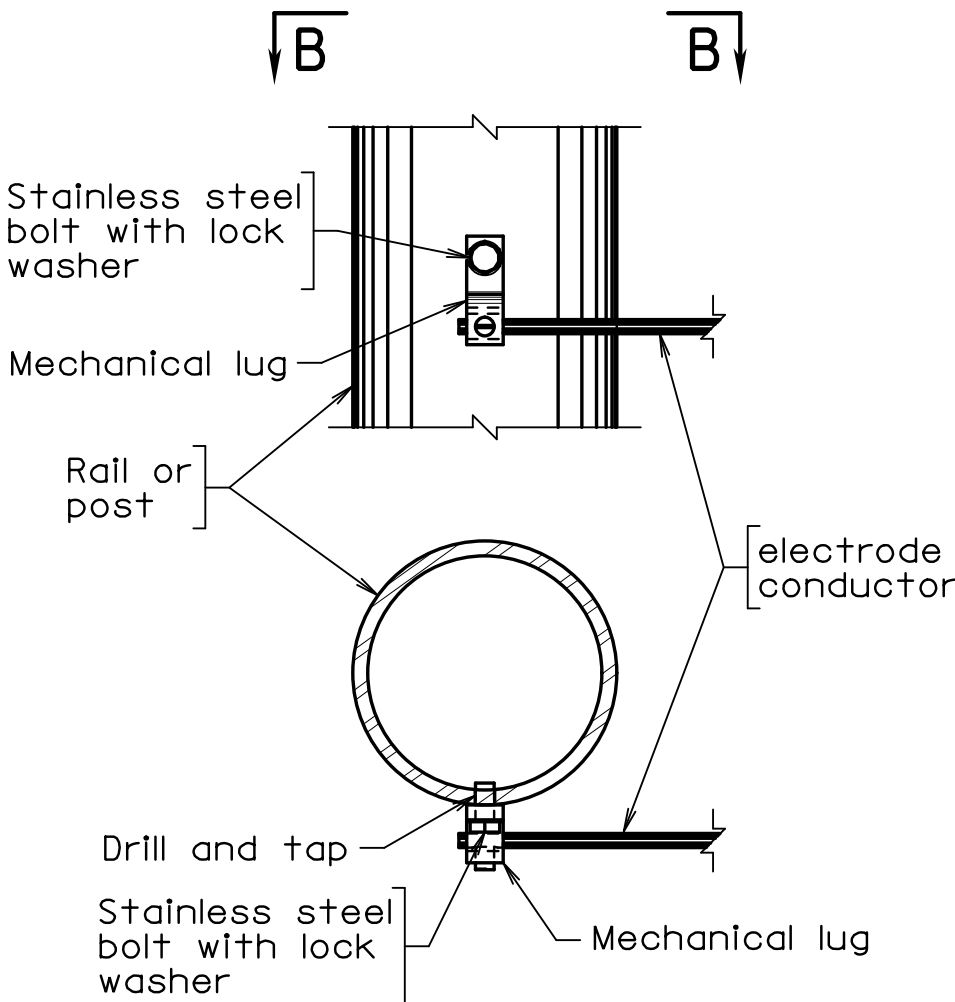
ELECTRICAL CONTINUITY  
FOR VINYL COATED STEEL PEDESTRIAN FENCE  
(Installed on the non-traffic side of the fence)  
Not to scale



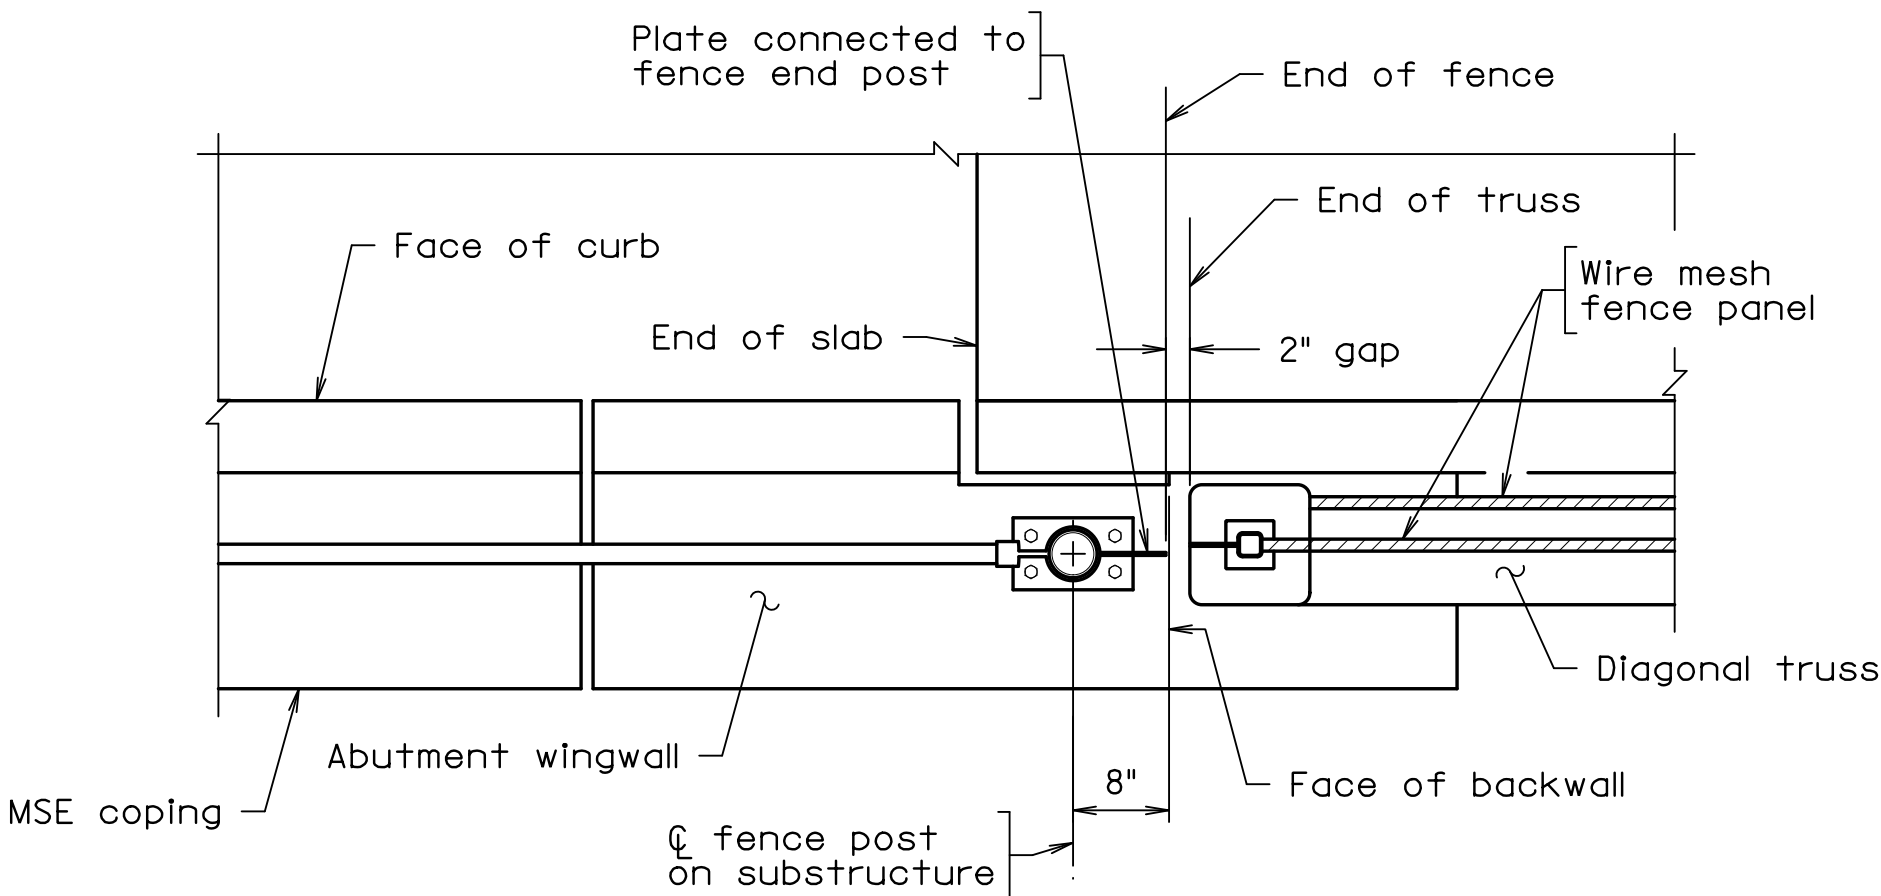SECTION B-B  
MECHANICAL LUG DETAIL  
Not to scale



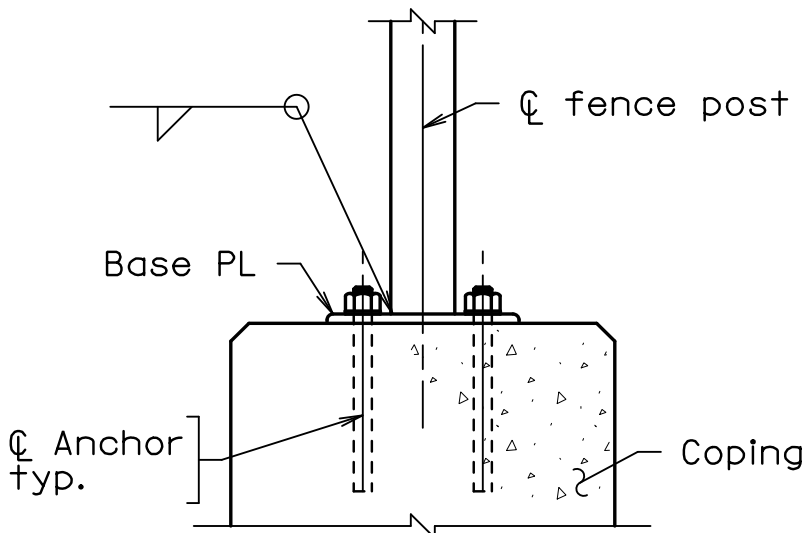FENCE CONTINUITY PLAN  
Abut. B shown, Abut. A opposite hand  
Scale: 3/8" = 1'-0"



FENCE CONNECTION  
Scale: 1 1/2" = 1'-0"

Scale as noted.

PREFINAL PLANS

EMERGENCY POLICE - FIRE - RESCUE 911								
FAIRFAX COUNTY, VIRGINIA								
DEPARTMENT OF PUBLIC WORKS AND ENVIRONMENTAL SERVICES								
12000 GOVERNMENT CENTER PARKWAY, SUITE 449 FAIRFAX, VA., 22035-0052								
R E V I S I O N S						OFFICE OF CAPITAL FACILITIES 703-324-5800		
						WIEHLE AVENUE (RTE 828) AT W&OD TRAIL PEDESTRIAN FENCE DETAILS - 8 FT. FENCE		
						PROJECT NO: 1400102-2013		
						PLAN NO.	DESIGNED: JRM	SHEET  6(13)
						XXX-XX	DRAFTED: CRR	
							CHECKED: TAB	
						APPROVED BY THE TRANSPORTATION DESIGN DIVISION		

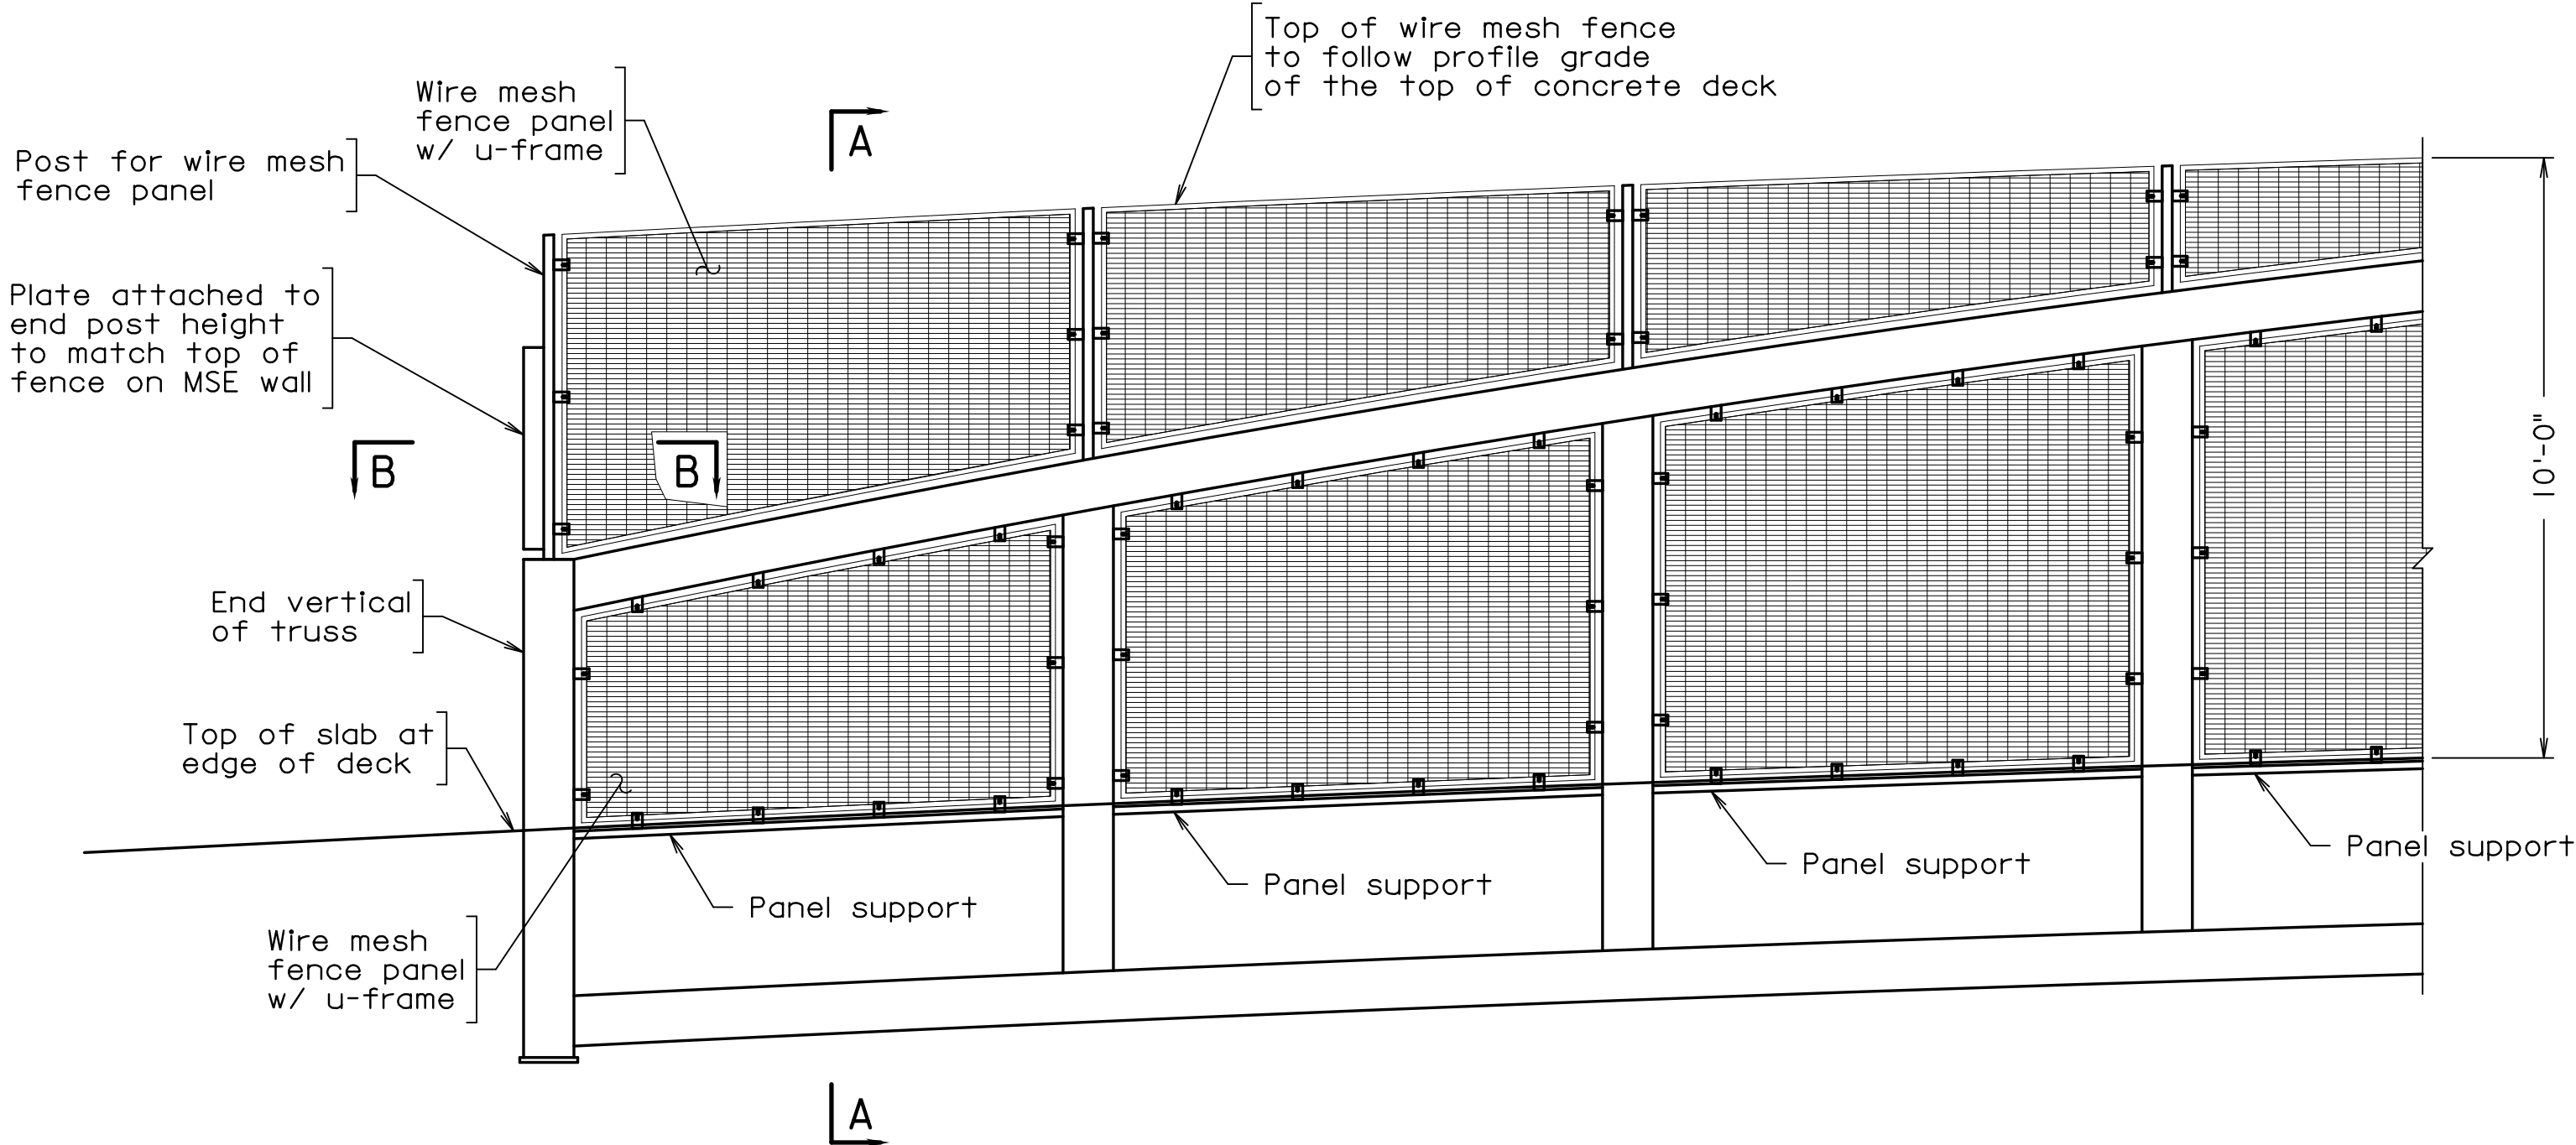
WHITMAN REQUARDT & ASSOCIATES RICHMOND, VA STRUCTURAL ENGINEER	△#	DESCRIPTION	BY	APPROVED	DATE
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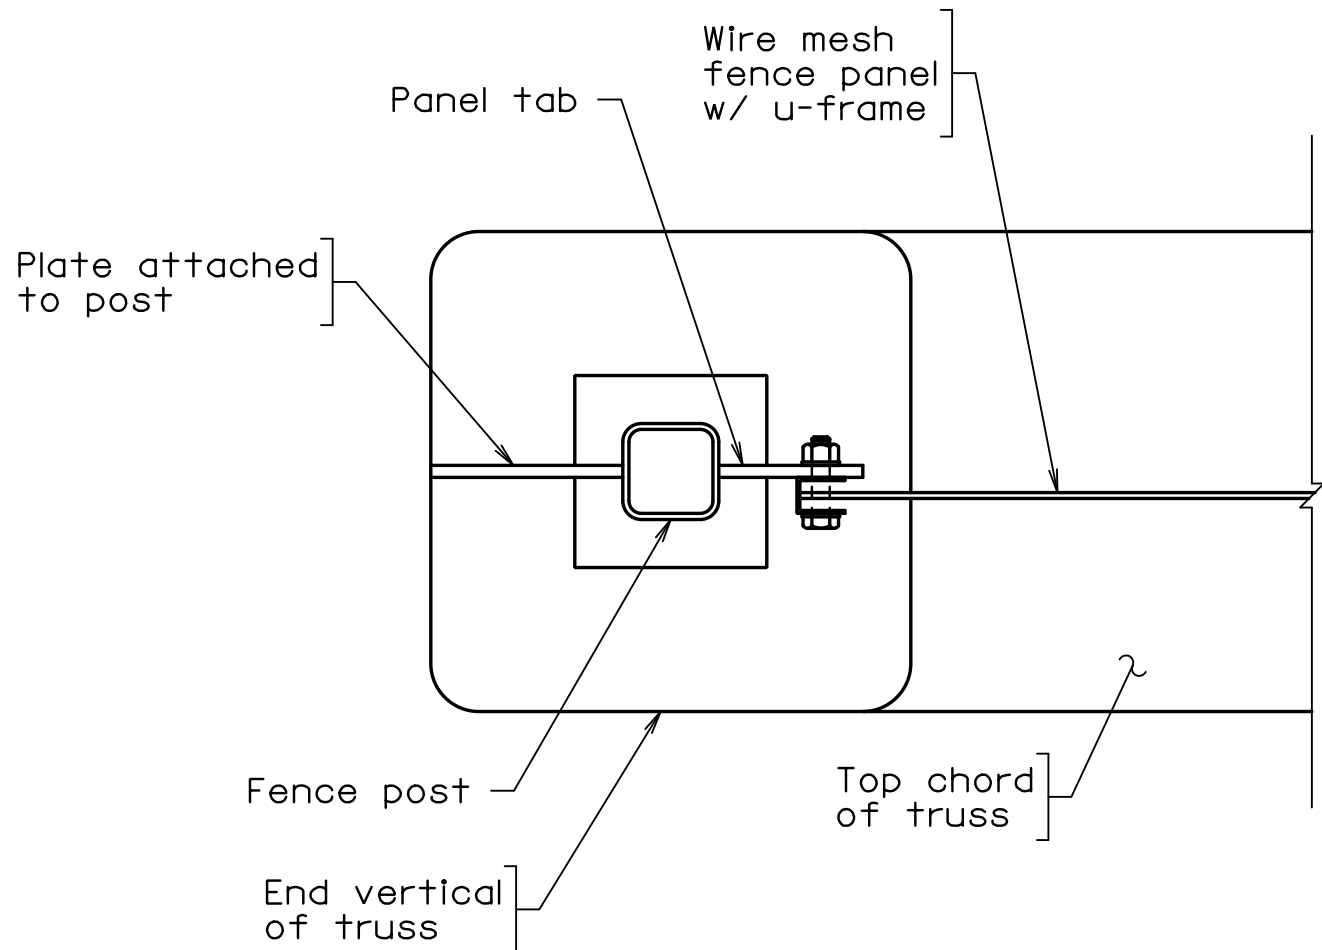


PROJECT MANAGER: SCOTT, BUFFNER, P.E., (703) 287-5236  
SURVEYED BY, DATE: FAIRFAX COUNTY  
DESIGN BY: WHITMAN, REQUARDT & ASSOCIATES, LLP, (703) 293-9717  
SUBSURFACE UTILITY BY, DATE: SO DEEP, INC., (703) 361-6005, December 23, 2014


STATE	FEDERAL AID		STATE	
	ROUTE	PROJECT	ROUTE	PROJECT
VA.	—	—	828	0828-029-248, B-601



ELEVATION  
Scale: 3/8" = 1'-0"  
Truss diagonals not shown for clarity.



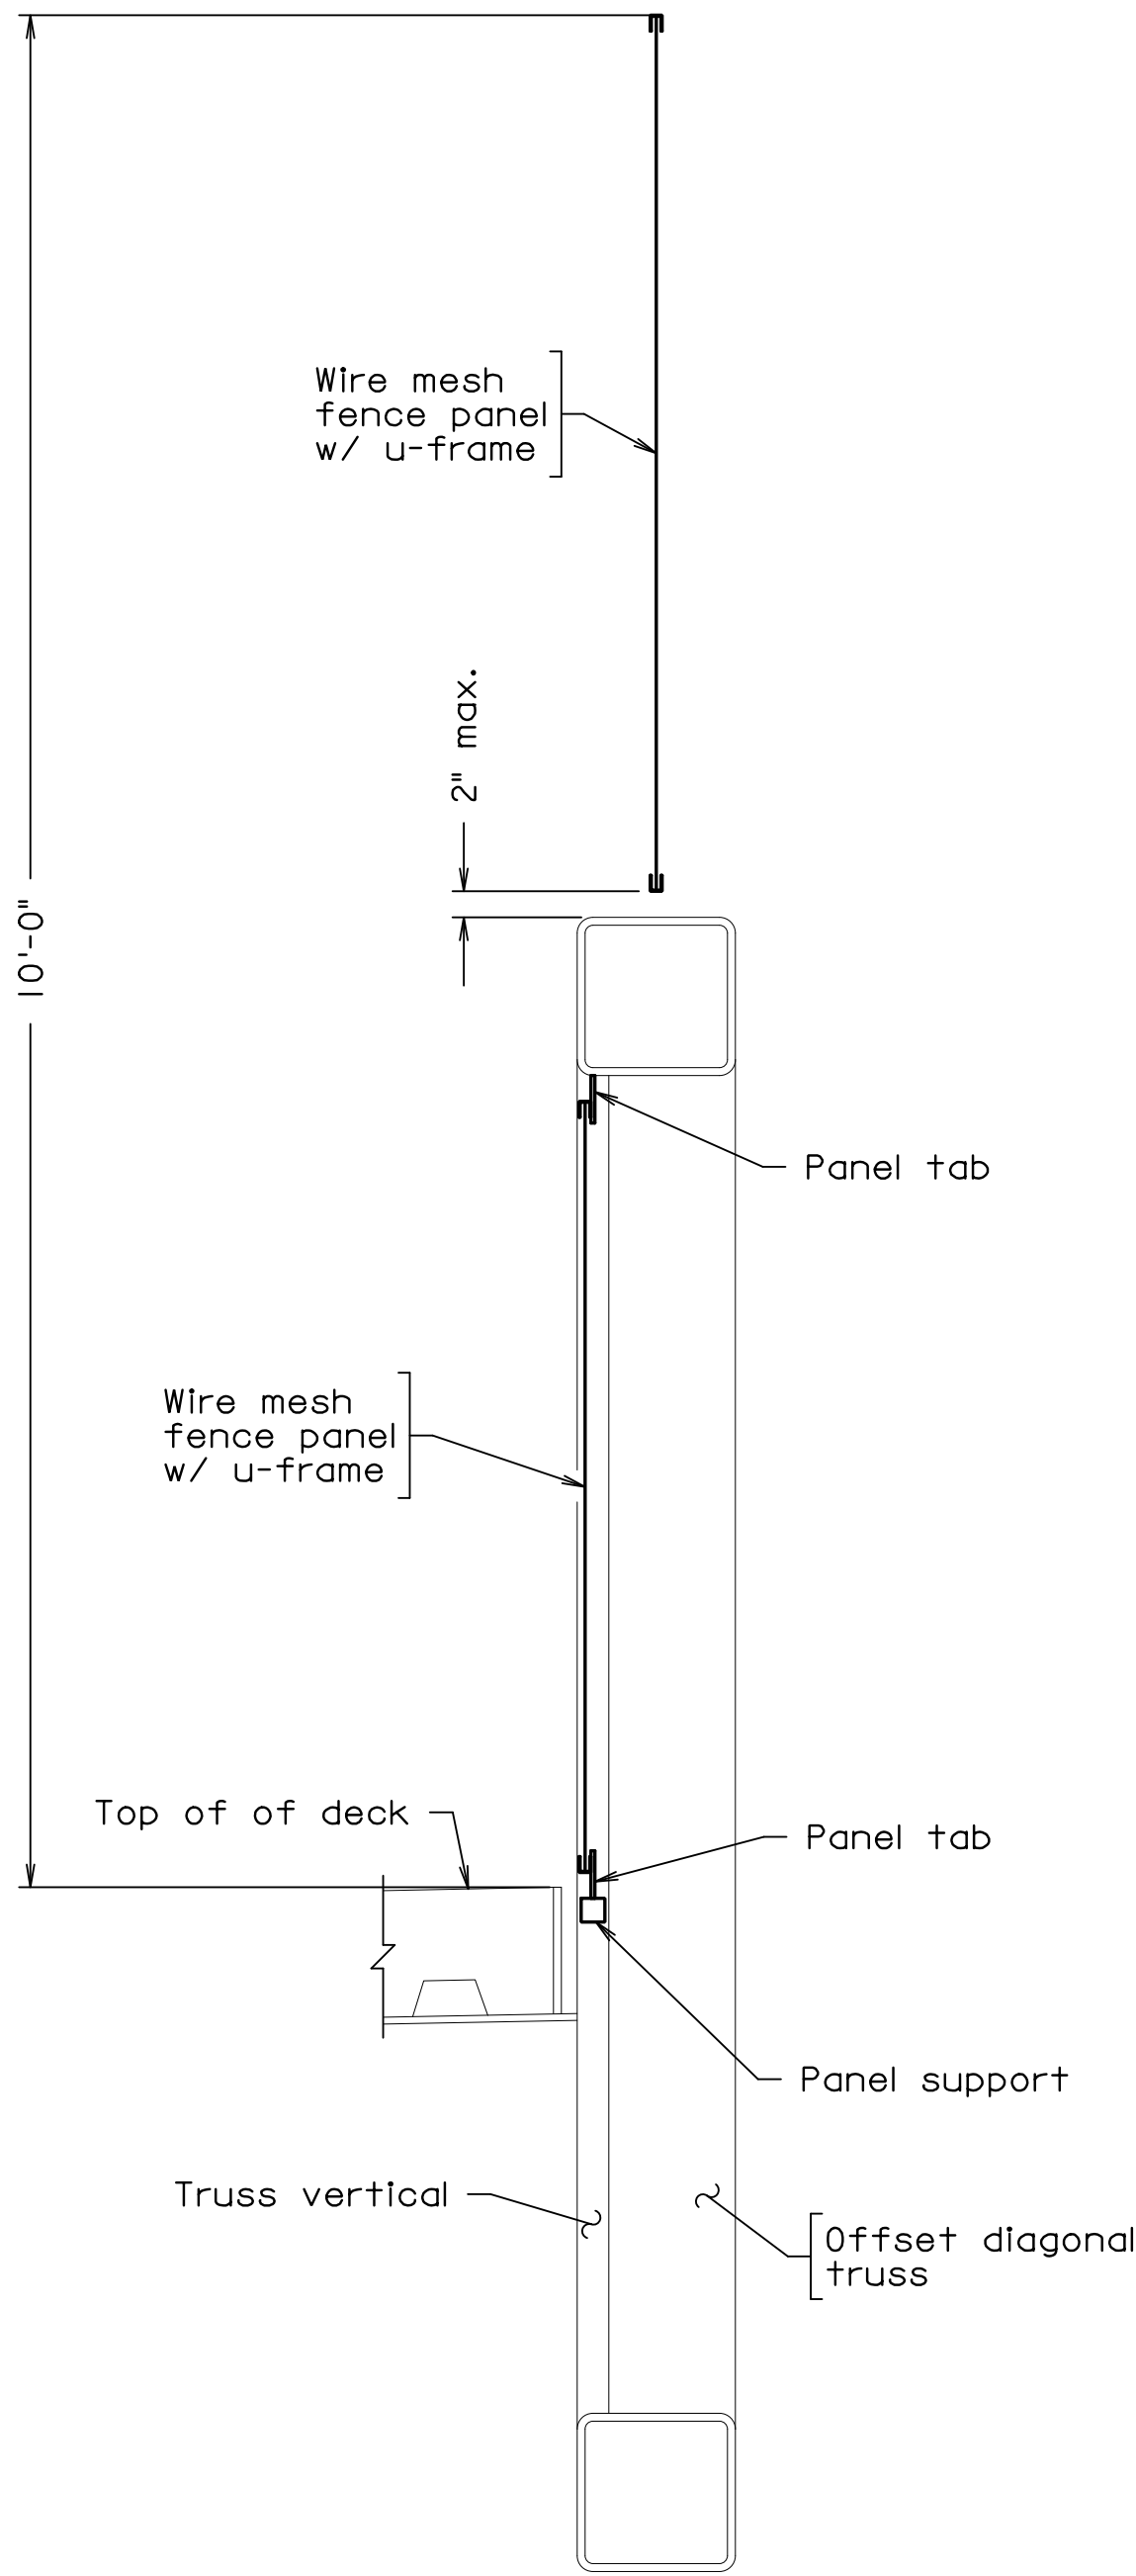SECTION B-B  
Scale: 3" = 1'-0"



SECTION A-A  
Scale: 1" = 1'-0"

Notes:

Posts shall be set vertical.

Spacing of posts to be equally spaced, and be centered over locations of vertical members of truss.

All panels shall be galvanized lock crimp wire mesh panels with galvanized u-frame.

Wire mesh shall be 7 gage wire with 1" square openings.

Wire mesh, posts, frames, bolts excluding threads, and other associated hardware shall be the color brown to match that of weathering steel trusses, and be either vinyl coated or powder coated.

Bolt threads shall not be galvanized or coated.

All bolts shall be high strength (ASTM A325).

All welded or seamless steel galvanized pipe shall conform to ASTM F1083, Schedule 40.

Prefabricated truss manufacturer to provide all necessary details of wire mesh fence panels for shop drawing reviews prior to fabrication. See special provisions for additional requirements not shown.

For MSE pedestrian fence details, see sheet 6(13).

PREFINAL PLANS

EMERGENCY POLICE - FIRE - RESCUE 911					
FAIRFAX COUNTY, VIRGINIA					
DEPARTMENT OF PUBLIC WORKS AND ENVIRONMENTAL SERVICES					
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R E V I S I O N S					OFFICE OF CAPITAL FACILITIES 703-324-5800
					WIEHLE AVENUE (RTE 828) AT W&OD TRAIL
					WIRE MESH FENCE PANEL
					DETAILS ON SUPERSTRUCTURE
					PROJECT NO: 1400102-2013
S	△#	DESCRIPTION	BY	APPROVED	DATE
	APPROVED BY THE TRANSPORTATION DESIGN DIVISION				
PLAN NO. XXX-XX				DESIGNED: JRM	SHEET
				DRAFTED: CRR	6(14)
				CHECKED: TAB	

FUND # 500-C5000

Scale as noted.

THESE PLANS ARE UNFINISHED AND UNAPPROVED AND ARE NOT TO BE USED FOR ANY TYPE OF CONSTRUCTION.



PROJECT MANAGER: SCOTT, BUFFNER, P.E., (703) 877-5236  
SURVEYED BY, DATE: FAIRFAX COUNTY  
DESIGN BY: WHITMAN, REQUARDT & ASSOCIATES, LLP, (703) 293-9717  
SUBSURFACE UTILITY BY, DATE: SO DEEP, INC., (703) 361-6005, December 23, 2014

STATE	FEDERAL AID		STATE	
	ROUTE	PROJECT	ROUTE	PROJECT
VA.	—	—	828	0828-029-248, B-601

Notes:

Architectural treatment for the MSE walls shall simulate drystack texture, similar to the pattern detailed on sheet 6(29).

This sheet is for layout and designation of aesthetic treatment only. For abutment and wing haunch details, see sheets 6(4) - 6(7).

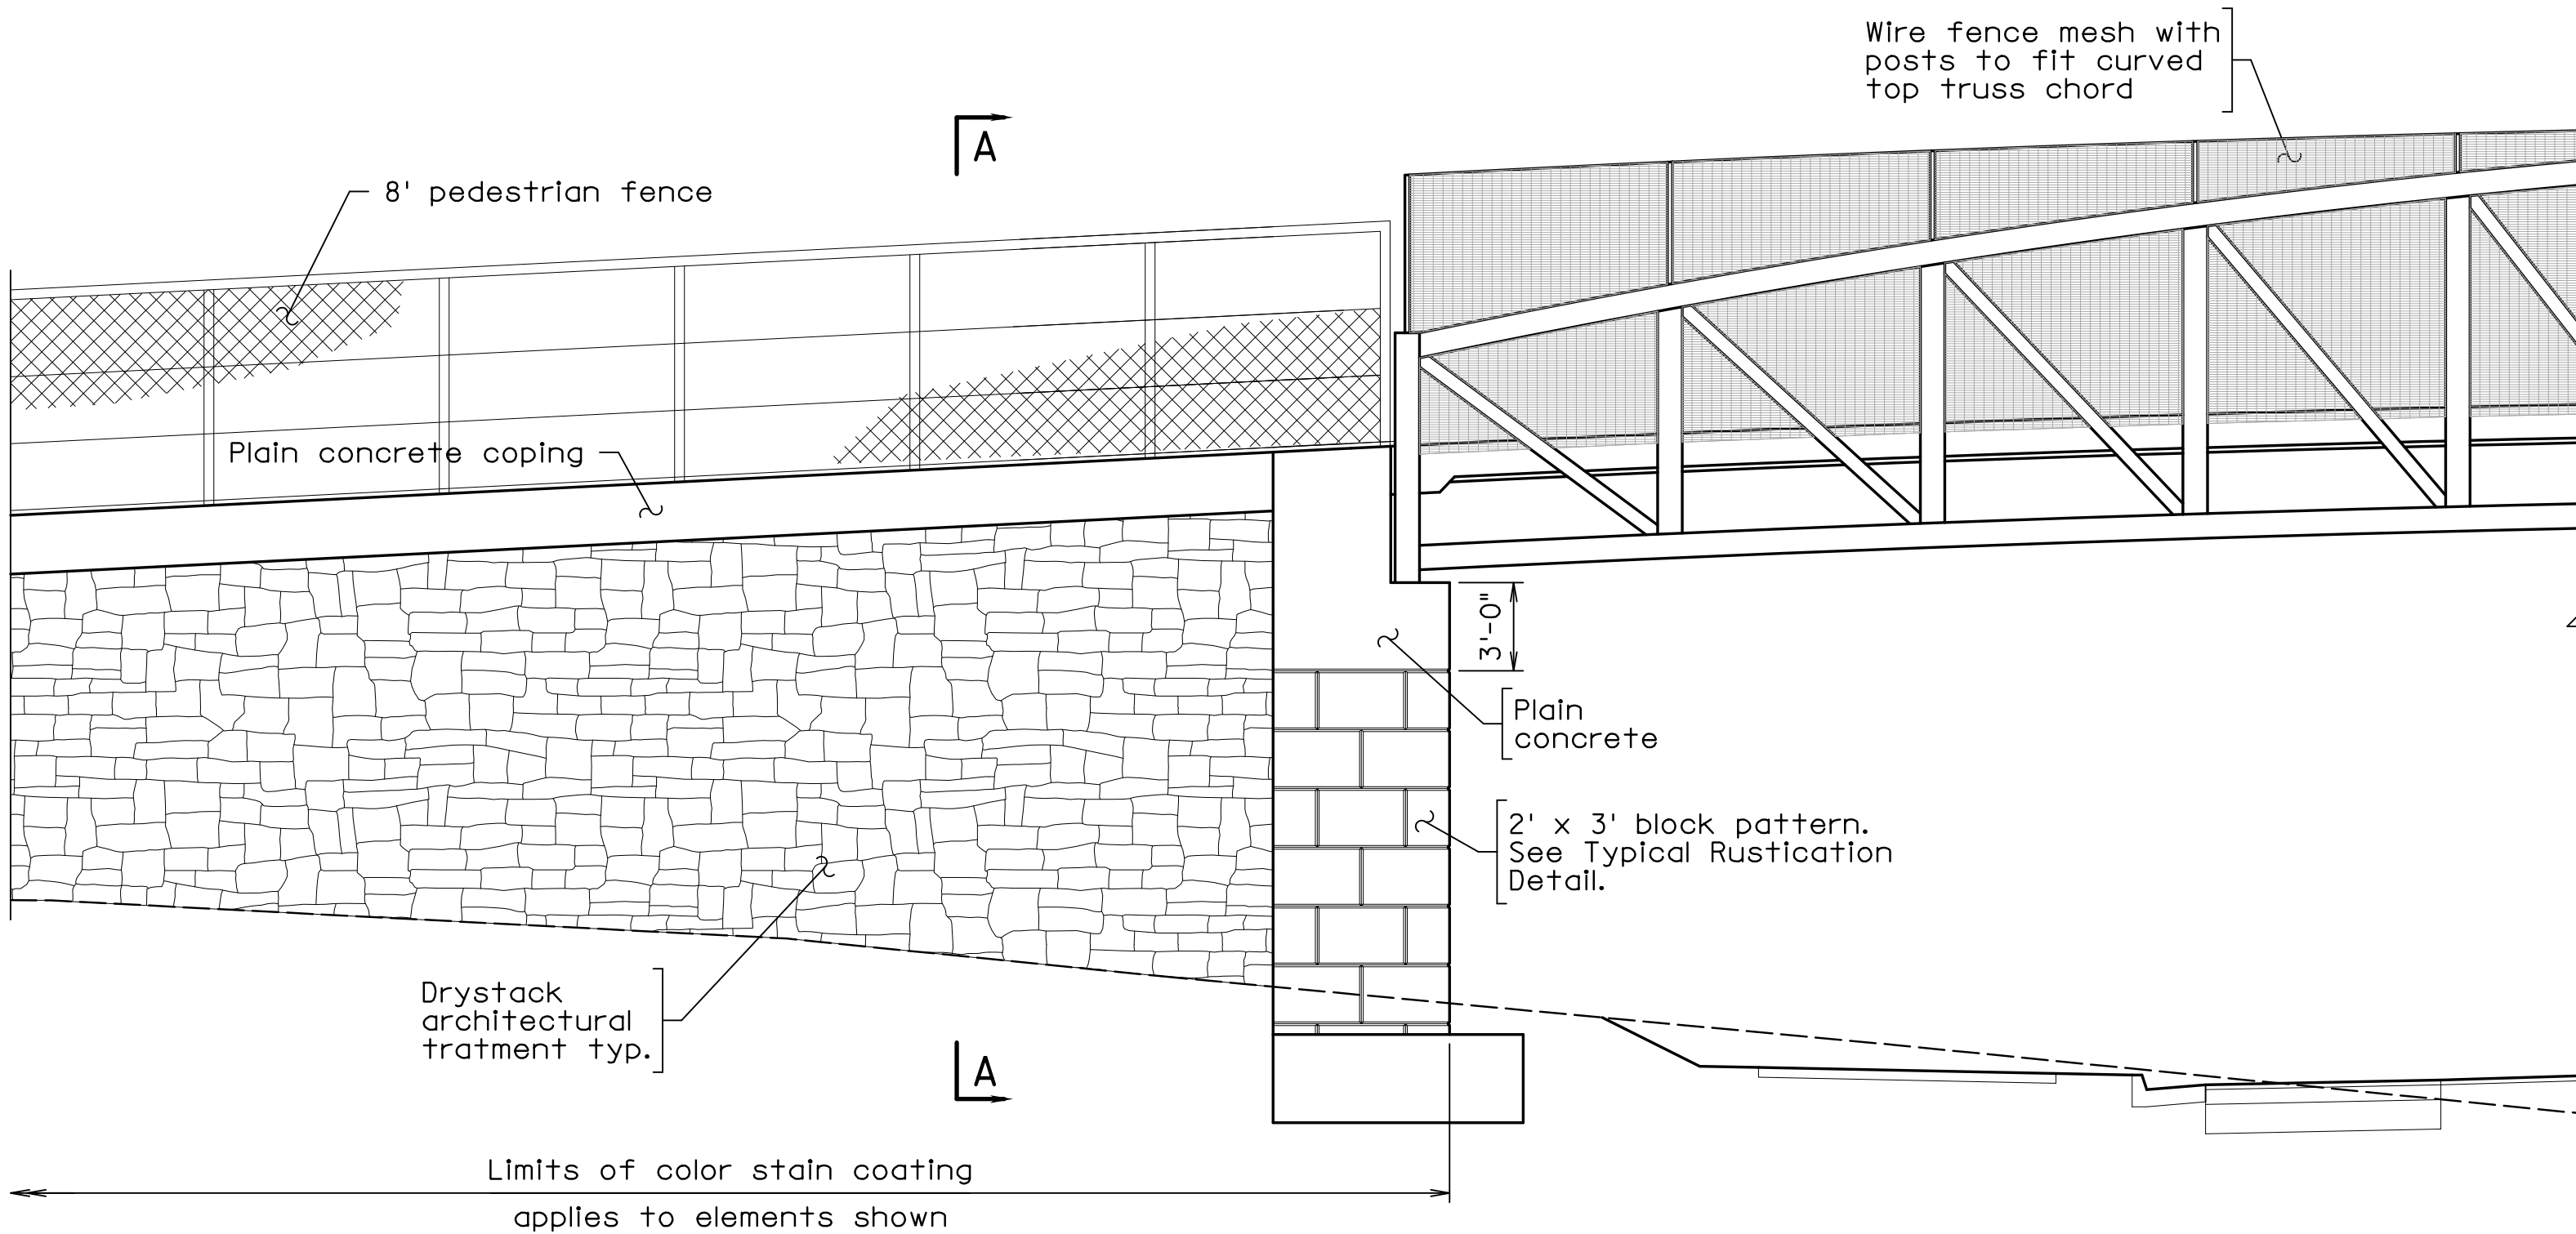
Concrete formliner pattern shall be drystack similar to the pattern detailed on this sheet. Maximum relief shall be 2" for MSE walls.

Limits of concrete stain color coating are indicated for both superstructure and substructure elements.

Color stain coating shall be applied prior to installation of 8' pedestrian fence.


All concrete designated as plain concrete on this sheet shall be white (Federal color no. 595C-XXXX). All 2' x 3' block pattern shall be grey (Federal color no. 595C-XXXX). All Drystack pattern shall be a combination of the white and grey colors used for the other defined elements.

For additional details and requirements not shown, see special provisions.




PART ELEVATION OF APPROACH WALL AND TRUSS

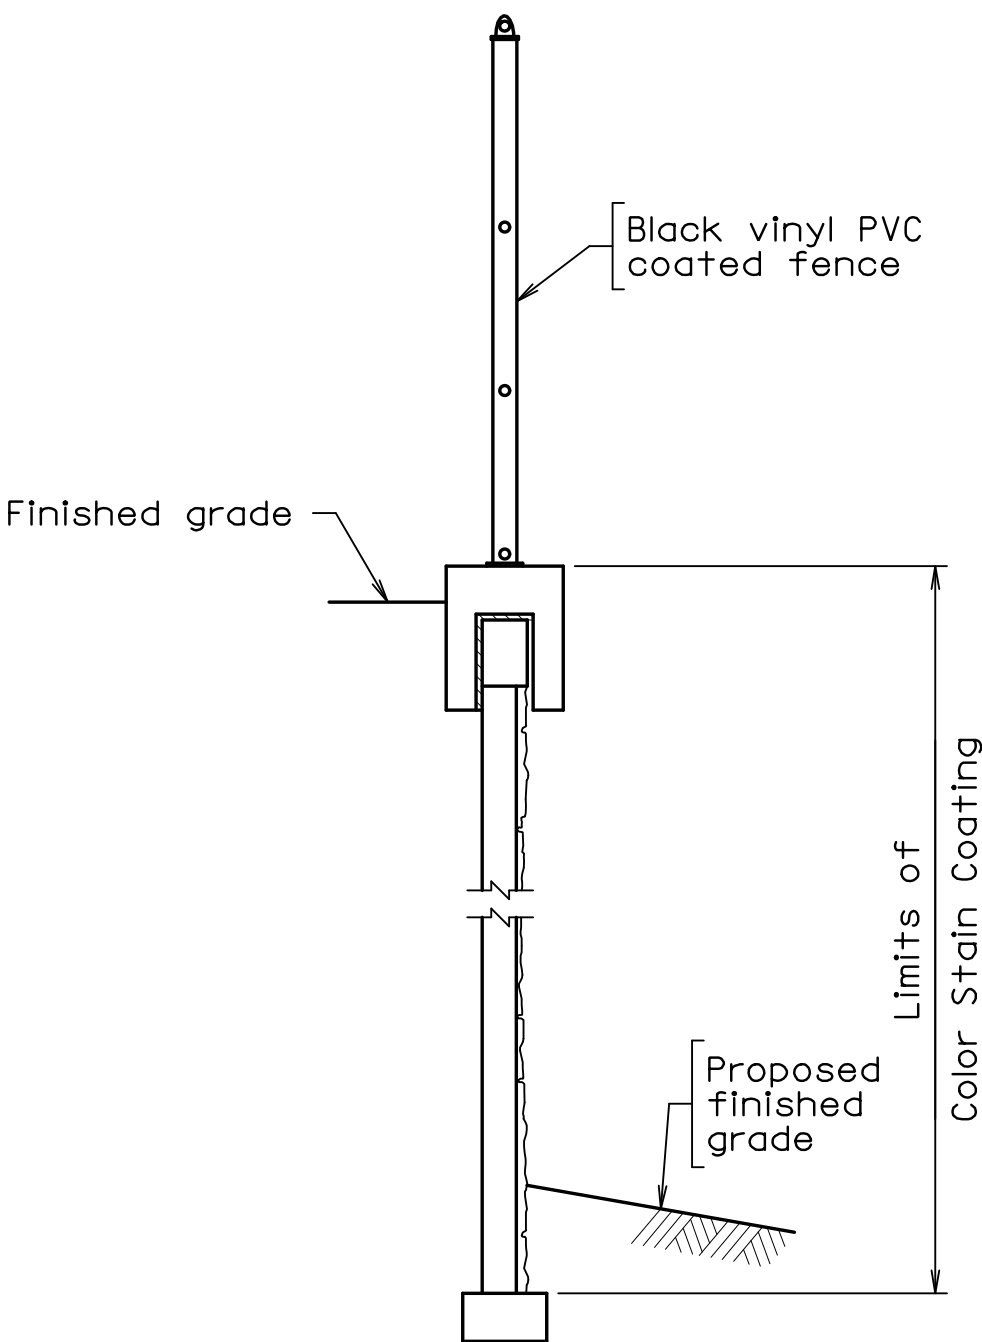Showing architectural treatments  
Scale: 3/16" = 1'-0"




SECTION A-A

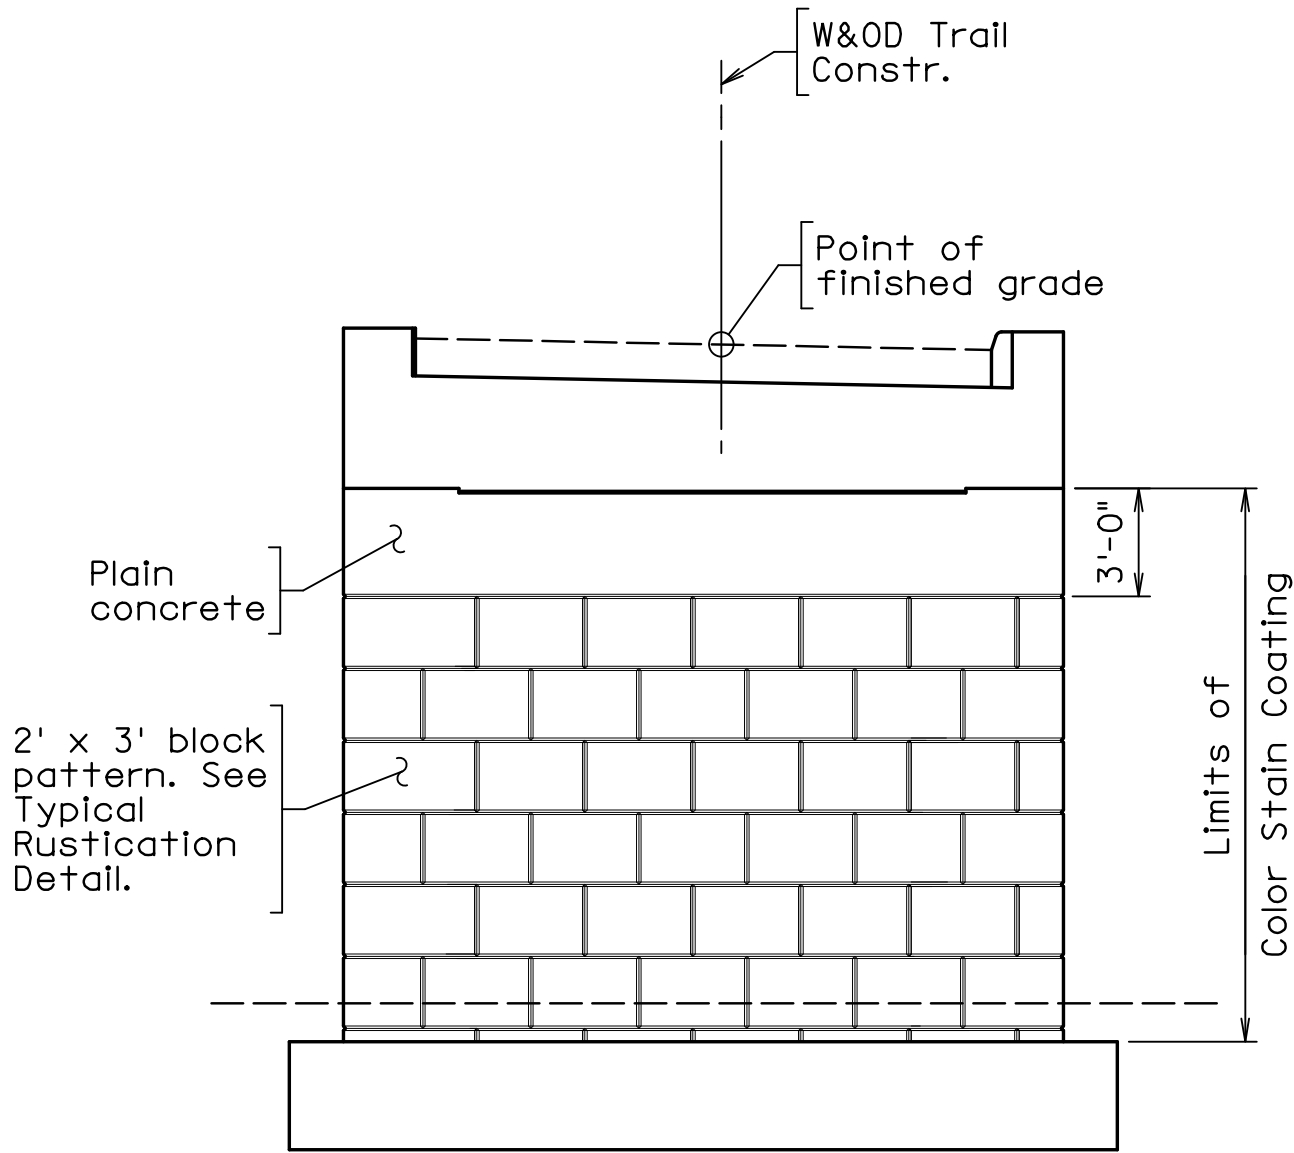Scale: 3/8" = 1'-0"



ELEVATION VIEW OF ABUTMENT

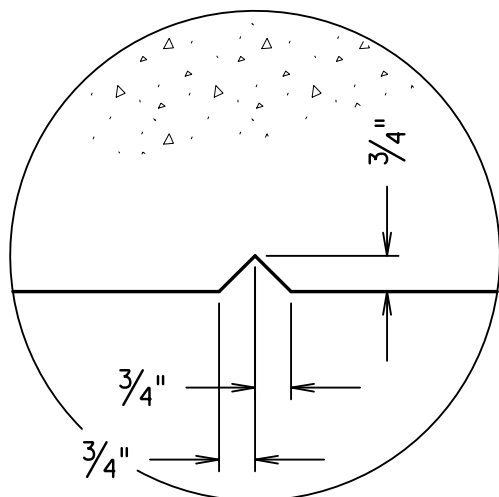Showing architectural treatments  
Scale: 3/16" = 1'-0"



TYPICAL RUSTICATION DETAIL

Scale: 3" = 1'-0"

PREFINAL PLANS

EMERGENCY POLICE - FIRE - RESCUE 911										
FAIRFAX COUNTY, VIRGINIA										
DEPARTMENT OF PUBLIC WORKS AND ENVIRONMENTAL SERVICES										
12000 GOVERNMENT CENTER PARKWAY, SUITE 449 FAIRFAX, VA., 22035-0052										
R E V I S I O N S						OFFICE OF CAPITAL FACILITIES				
							703-324-5800			
							WIEHLE AVENUE (RTE 828) AT W&OD TRAIL			
							ARCHITECTURAL TREATMENT DETAILS			
							PROJECT NO: 1400102-2013			
WHITMAN REQUARDT & ASSOCIATES RICHMOND, VA STRUCTURAL ENGINEER	△#	DESCRIPTION	BY	APPROVED	DATE	PLAN NO.	DESIGNED: JRM		SHEET  6(15)	
						XXX-XX	DRAFTED: CRR			
							CHECKED: TAB			

THESE PLANS ARE UNFINISHED AND UNAPPROVED AND ARE NOT TO BE USED FOR ANY TYPE OF CONSTRUCTION.




PROJECT MANAGER, SCOTT RUFFNER, P.E. (703) 877-5736  
SURVEYED BY, DATE FAIRFAX COUNTY  
DESIGN BY WHITMAN, REQUARDT & ASSOCIATES, LLP (703) 293-9717  
SUBSURFACE UTILITY BY, DATE SO DEEP, INC. (703) 361-6005 December 23, 2014

STATE	FEDERAL AID		STATE	
	ROUTE	PROJECT	ROUTE	PROJECT
VA.	—	—	828	0828-029-248, B-601

REINFORCING STEEL SCHEDULE							DIMENSION TABLE																
MARK	NO.	BAR SIZE	PIN DIA. FT.-IN.	LENGTH FT.-IN.		WEIGHT (LBS.)	LOCATION	MARK	TYPE	A FT.-IN.	B FT.-IN.	C FT.-IN.	D FT.-IN.	E P FT.-IN.	F Q FT.-IN.	G R FT.-IN.	H FT.-IN.	I S FT.-IN.	J T FT.-IN.	K U FT.-IN.	L FT.-IN.	V FT.-IN.	N FT.-IN.
ABUTMENT A																							
FOOTING - BLACK REINFORCING STEEL																							
AF0601	48	06		8-0		576	FOOTING	AF0601	1	8-0													
AF0602	18	06		22-6		608	FOOTING	AF0602	1	22-6													
AF0603	49	06	0-4 1/2	6-8 1/4		492	FOOTING	AF0603	24	6-0							0-6						
AF0404	40	04		3-0		80	FOOTING	AF0404	1	3-0													
AF0505	12	05		3-5		43	FOOTING	AF0505	1	3-5													
				TOTAL WEIGHT IN PRECEDING GROUP OF BARS		1799																	
ABUTMENT A																							
NEAT - CORROSION RESISTANT REINF. STEEL CLASS I																							
AH0401	68	04		19-7 1/2		891	STEM / BACKWALL	AH0401	1	19-7 1/2													
AH0602	5	06		19-7 1/2		147	SEAT	AH0602	1	19-7 1/2													
AH0503	64	05		5-7 1/2		375	WINGWALL	AH0503	1	5-7 1/2													
AH0504	32	05	0-2 1/2	6-0 1/8		201	WINGWALL	AH0504	7		1-4 3/4	2-5	2-5										
AH0505	8	05	0-2 1/2	8-4 1/8		70	WINGWALL	AH0505	7		1-4 3/4	3-7	3-7										
AH0506	9	05	0-2 1/2	6-2		58	WINGWALL	AH0506	51		1-6 1/2	1-4 3/4					0-5						
AH0507	3	05		2-2		7	WINGWALL	AH0507	1	2-2													
AH0508	3	05	0-2 1/2	7-3 1/8		23	WINGWALL	AH0508	7		0-9 3/4	3-8	3-0										
AV0401	40	04		14-11		399	STEM	AV0401	1	14-11													
AV0402	40	04	0-2	4-4 7/8		118	SEAT	AV0402	30		2-6 1/2	1-6					0-4 1/2						
AV0403	17	04	0-2	6-11 7/8		79	BACKWALL	AV0403	7		0-6 1/2	4-3 1/2	2-4										
AV0604	33	06		17-9		879	BACKWALL	AV0604	1	17-9													
AV0507	10	05		19-2		200	WINGWALL	AV0507	1	19-2													
AV0608	13	06		19-2		374	WINGWALL	AV0608	1	19-2													
AV0509	2	05		14-11		31	WINGWALL	AV0509	1	14-11													
AV0610	3	06		17-9		80	WINGWALL	AV0610	1	17-9													
AV0611	4	06	0-3 3/4	9-4 1/4		56	WINGWALL	AV0611	7		0-11 1/8	6-3 1/2	2-5										
				TOTAL WEIGHT IN PRECEDING GROUP OF BARS		3988																	
ABUTMENT B																							
FOOTING - BLACK REINFORCING STEEL																							
AF0601	48	06		8-0		576	FOOTING	AF0601	1	8-0													
AF0602	18	06		22-6		608	FOOTING	AF0602	1	22-6													
AF0603	49	06	0-4 1/2	6-8 1/4		492	FOOTING	AF0603	24	6-0							0-6						
AF0404	40	04		3-0		80	FOOTING	AF0404	1	3-0													
AF0505	12	05		3-5		43	FOOTING	AF0505	1	3-5													
				TOTAL WEIGHT IN PRECEDING GROUP OF BARS		1799																	
ABUTMENT B																							
NEAT - CORROSION RESISTANT REINF. STEEL CLASS I																							
AH0401	72	04		19-7 1/2		944	STEM / BACKWALL	AH0401	1	19-7 1/2													
AH0602	5	06		19-7 1/2		147	SEAT	AH0602	1	19-7 1/2													
AH0503	68	05		5-7 1/2		399	WINGWALL	AH0503	1	5-7 1/2													
AH0504	34	05	0-2 1/2	6-0 1/8		213	WINGWALL	AH0504	7		1-4 3/4	2-5	2-5										
AH0505	8	05	0-2 1/2	8-4 1/8		70	WINGWALL	AH0505	7		1-4 3/4	3-7	3-7										
AH0506	9	05	0-2 1/2	6-2		58	WINGWALL	AH0506	51		1-6 1/2	1-4 3/4					0-5						
AH0507	3	05		2-2		7	WINGWALL	AH0507	1	2-2													
AH0508	3	05	0-2 1/2	7-3 1/8		23	WINGWALL	AH0508	7		0-9 3/4	3-8	3-0										
AV0402	40	04	0-2	4-4 7/8		118	SEAT	AV0402	30		2-6 1/2	1-6					0-4 1/2						
AV0403	17	04	0-2	6-11 7/8		79	BACKWALL	AV0403	7		0-6 1/2	4-3 1/2	2-4										
AV0405	40	04		15-11		425	STEM	AV0405	1	15-11													
AV0606	33	06		18-9		929	BACKWALL	AV0606	1	18-9													
AV0611	4	06	0-3 3/4	9-4 1/4		56	WINGWALL	AV0611	7		0-11 1/8	6-3 1/2	2-5										
AV0512	10	05		20-2		210	WINGWALL	AV0512	1	20-2													
AV0613	13	06		20-2		394	WINGWALL	AV0613	1	20-2													
AV0514	2	05		15-11		33	WINGWALL	AV0514	1	20-11													
AV0615	3	06		18-9		84	WINGWALL	AV0615	1	18-9													
				TOTAL WEIGHT IN PRECEDING GROUP OF BARS		4189																	
ABUTMENT C																							
NEAT - CORROSION RESISTANT REINF. STEEL CLASS I																							
AH0401	72	04		19-7 1/2		944	STEM / BACKWALL	AH0401	1	19-7 1/2													
AH0602	5	06		19-7 1/2		147	SEAT	AH0602	1	19-7 1/2													
AH0503	68	05		5-7 1/2		399	WINGWALL	AH0503	1	5-7 1/2													
AH0504	34	05	0-2 1/2	6-0 1/8		213	WINGWALL	AH0504	7		1-4 3/4	2-5	2-5										
AH0505	8	05	0-2 1/2	8-4 1/8		70	WINGWALL	AH0505	7		1-4 3/4	3-7	3-7										
AH0506	9	05	0-2 1/2	6-2		58	WINGWALL	AH0506	51		1-6 1/2	1-4 3/4					0-5						
AH0507	3	05		2-2		7	WINGWALL	AH0507	1	2-2													
AH0508	3	05	0-2 1/2	7-3 1/8		23	WINGWALL	AH0508	7		0-9 3/4	3-8	3-0										
AV0402	40	04	0-2	4-4 7/8		118	SEAT	AV0402	30		2-6 1/2	1-6					0-4 1/2						
AV0403	17	04	0-2	6-11 7/8		79	BACKWALL	AV0403	7		0-6 1/2	4-3 1/2	2-4										
AV0405	40	04		15-11		425	STEM	AV0405	1	15-11													
AV0606	33	06		18-9		929	BACKWALL	AV0606	1	18-9													
AV0611	4	06	0-3 3/4	9-4 1/4		56	WINGWALL	AV0611	7		0-11 1/8	6-3 1/2	2-5										
AV0512	10	05		20-2		210	WINGWALL	AV0512	1	20-2													
AV0613	13	06		20-2		394	WINGWALL	AV0613	1	20-2													
AV0514	2	05		15-11		33	WINGWALL	AV0514	1	20-11													
AV0615	3	06		18-9		84	WINGWALL	AV0615	1	18-9													
				TOTAL WEIGHT IN PRECEDING GROUP OF BARS		4189																	
ABUTMENT C																							
NEAT - CORROSION RESISTANT REINF. STEEL CLASS I																							
AH0401	72	04		19-7 1/2		944	STEM / BACKWALL	AH0401	1	19-7 1/2													
AH0602	5	06		19-7 1/2		147	SEAT	AH0602	1	19-7 1/2													
AH0503	68	05		5-7 1/2		399	WINGWALL	AH0503	1	5-7 1/2													
AH0504	34	05	0-2 1/2	6-0 1/8		213	WINGWALL	AH0504	7		1-4 3/4	2-5	2-5										
AH0505	8	05	0-2 1/2	8-4 1/8		70	WINGWALL	AH0505	7		1-4 3/4	3-7	3-7										
AH0506	9	05	0-2 1/2	6-2		58	WINGWALL	AH0506	51		1-6 1/2	1-4 3/4					0-5						
AH0507	3	05		2-2		7	WINGWALL	AH0507	1	2-2													
AH0508	3	05	0-2 1/2	7-3 1/8		23	WINGWALL	AH0508	7		0-9 3/4	3-8	3-0										
AV0402	40	04	0-2	4-4 7/8		118	SEAT	AV0402	30		2-6 1/2	1-6					0-4 1/2						
AV0403	17	04	0-2	6-11 7/8		79	BACKWALL	AV0403	7		0-6 1/2												

[illegible]

## BENDING DIAGRAM

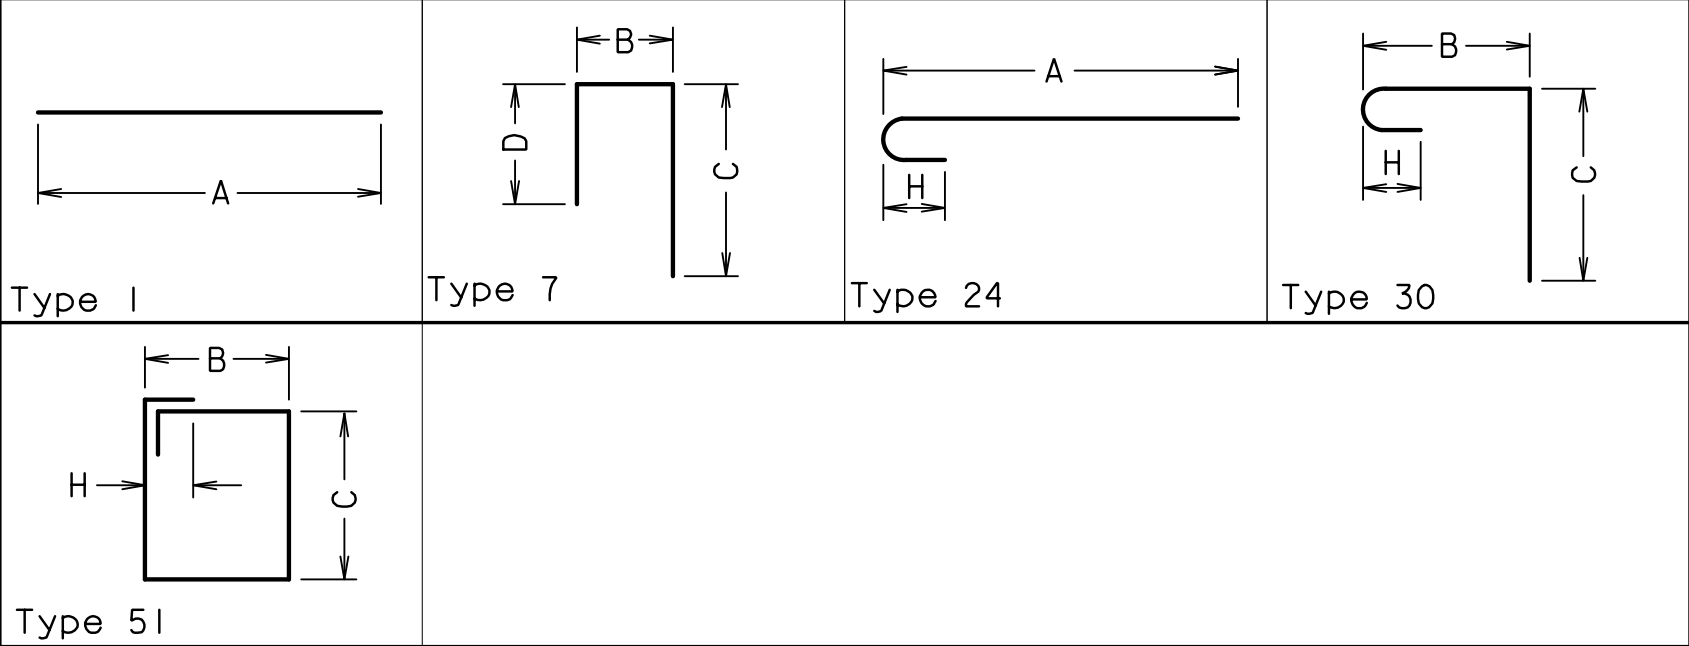

## PREFINAL PLANS

NOTES:

Dimensions in Bending Diagram are out-to-out of bars.

Weights in schedule are based on density of 490 lb/ft.<sup>3</sup>

If fabrication of deck slab bar is not possible for length detailed and multiple bars are required, bars shall have the least number of Class B splices possible. Splices shall be located approximately at points of contraflexure and splices in alternate bars shall be located in different bays.

Straight bars (top and bottom) may be substituted for truss bars (SB series) in the deck superstructure at no extra cost to the State.

**EMERGENCY POLICE - FIRE - RESCUE 911**

FAIRFAX COUNTY, VIRGINIA  
DEPARTMENT OF PUBLIC WORKS AND ENVIRONMENTAL SERVICES  
12000 GOVERNMENT CENTER PARKWAY, SUITE 449 FAIRFAX, VA., 22035-0052

R E V I S I O N					OFFICE OF CAPITAL FACILITIES 703-324-5800		
					WIEHLE AVENUE (RTE 828) AT W&OD TRAIL		
					REINFORCING STEEL SCHEDULE		
					PROJECT NO: 1400102-2013		
					PLAN NO. XXX-XX	DESIGNED: JRM DRAFTED: CRF CHECKED: TAB	SHEET 6(16)
	△#	DESCRIPTION	BY	APPROVED	DATE		
	APPROVED BY THE TRANSPORTATION DESIGN DIVISION						


FUND # 500-C5000


THESE PLANS ARE UNFINISHED AND UNAPPROVED AND ARE NOT TO BE USED FOR ANY TYPE OF CONSTRUCTION.




PROJECT MANAGER: SCOTT, BUFFNER, P.E., (703) 287-5236  
SURVEYED BY, DATE: FAIRFAX COUNTY  
DESIGN BY: WHITMAN, REQUARDT & ASSOCIATES, LLP, (703) 293-9717  
SUBSURFACE UTILITY BY, DATE: SO DEEP, INC. (703) 366-6005, December 23, 2014

STATE	FEDERAL AID		STATE	
	ROUTE	PROJECT	ROUTE	PROJECT
VA.	---	---	828	0828-029-248, B-601

 Virginia Department of Transportation										PROJECT #: 45494-027 LOCATION: W&OD Trail over Wiehle Avenue STRUCTURE: TRAIL				B-04 PAGE 1 OF 1					
STATION: 11303.06 NORTHING: 7031410.79 ft SURFACE ELEVATION: 386.0 ft										OFFSET: 10.13 ft LT Easting: 11813790.28 ft COORD. DATUM: VA North									
Date(s) Drilled: 10/24/2016 - 10/24/2016 Drilling Method(s): HSA SPT Method: Automatic Hammer Other Test(s): Driller: Raymond Logger: G Koepping										LAB DATA									
FIELD DATA										LIQUID LIMIT				PLASTICITY INDEX		MOISTURE CONTENT (%)		FINES CONTENT #200 (%)	
										FIELD DESCRIPTION OF STRATA				LL		PI		18.3	
REMARKS: Rig Type: CME-45C-2 Truck Rig.										PAGE 1 OF 1				B-04					

 Virginia Department of Transportation										PROJECT #: 45494-027 LOCATION: W&OD Trail over Wiehle Avenue STRUCTURE: TRAIL				B-05 PAGE 1 OF 1					
STATION: 11400.00 NORTHING: 7031379.24 ft SURFACE ELEVATION: 383.0 ft										OFFSET: 11.00 ft LT Easting: 11813922.61 ft COORD. DATUM: VA North									
Date(s) Drilled: 10/24/2016 - 10/24/2016 Drilling Method(s): HSA SPT Method: Automatic Hammer Other Test(s): Driller: Raymond Logger: G Koepping										LAB DATA									
FIELD DATA										LIQUID LIMIT				PLASTICITY INDEX		MOISTURE CONTENT (%)			
										FIELD DESCRIPTION OF STRATA				LL		PI			
REMARKS: Rig Type: CME-45C-2 Truck Rig.										PAGE 1 OF 1				B-05					

 Virginia Department of Transportation										PROJECT #: 45494-027 LOCATION: W&OD Trail over Wiehle Avenue STRUCTURE: BRIDGE ABUTMENT				B-06/07 PAGE 1 OF 2					
STATION: 11493.65 NORTHING: 7031345.63 ft SURFACE ELEVATION: 380.0 ft										OFFSET: 7.47 ft LT Easting: 11813922.61 ft COORD. DATUM: VA North									
Date(s) Drilled: 10/28/2016 - 10/28/2016 Drilling Method(s): HSA SPT Method: Automatic Hammer Other Test(s): Driller: Raymond Logger: B Grass										LAB DATA									
FIELD DATA										LIQUID LIMIT				PLASTICITY INDEX		MOISTURE CONTENT (%)		FINES CONTENT #200 (%)	
										FIELD DESCRIPTION OF STRATA				LL		PI			
REMARKS: Rig Type: CME-45C-2 Truck Rig.										PAGE 1 OF 2				B-06/07					

The subsurface information shown on the boring logs in these plans was obtained with reasonable care and recorded in good faith solely for use by the County in establishing design controls for the project. The County has no reason to suspect that such information is not reasonably accurate as an approximate indication of the subsurface conditions at the sites where the borings were taken. The County does not in any way warrant or guarantee that such data can be projected as indicative of conditions beyond the limits of the borings shown; and any such projections by bidders are purely interpretive and altogether speculative. Further, the County does not in any way guarantee, either expressly or by implication, the sufficiency of the information for bid purposes.

The boring logs are made available to bidders in order that they may have access to subsurface data identical to that which is possessed by the County, and are not intended as a substitute for personal investigation, interpretation and judgment by the bidders.

EMERGENCY POLICE - FIRE - RESCUE 911									
FAIRFAX COUNTY, VIRGINIA DEPARTMENT OF PUBLIC WORKS AND ENVIRONMENTAL SERVICES 12000 GOVERNMENT CENTER PARKWAY, SUITE 449 FAIRFAX, VA., 22035-0052									
OFFICE OF CAPITAL FACILITIES 703-324-5800									
WIEHLE AVENUE (RTE 828) AT W&OD TRAIL ENGINEERING GEOLOGY 1 OF 6									
PROJECT NO: 1400102-2013									
PLAN NO. XXX-XX									
DESIGNED: JRM									
DRAFTED: CRR									
CHECKED: TAB									
SHEET 6(17)									
FUND # 500-C5000									

THESE PLANS ARE UNFINISHED AND UNAPPROVED AND ARE NOT TO BE USED FOR ANY TYPE OF CONSTRUCTION.



SPT LOGB:W&amp;OD WIEHLE AVE.GPJ:8.30.004:092710:4/4/17

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The subsurface information shown on the boring logs in these plans was obtained with reasonable care and recorded in good faith solely for use by the County in establishing design controls for the project. The County has no reason to suspect that such information is not reasonably accurate as an approximate indication of the subsurface conditions at the sites where the borings were taken. The County does not in any way warrant or guarantee that such data can be projected as indicative of conditions beyond the limits of the borings shown; and any such projections by bidders are purely interpretive and altogether speculative. Further, the County does not in any way guarantee, either expressly or by implication, the sufficiency of the information for bid purposes.

WHITMAN REQUARDT & ASSOCIATES  
RICHMOND, VA  
STRUCTURAL ENGINEER


FUND # 500-C5000


THESE PLANS ARE UNFINISHED AND UNAPPROVED AND ARE NOT TO BE USED FOR ANY TYPE OF CONSTRUCTION.




PROJECT MANAGER: SCOTT, BUFFNER, P.E., (703) 287-5236  
SURVEYED BY, DATE: FAIRFAX COUNTY  
DESIGN BY: WHITMAN, REQUARDT & ASSOCIATES, LLP, (703) 293-9717  
SUBSURFACE UTILITY BY, DATE: SO DEEP, INC. (703) 361-6005, December 23, 2014

STATE	FEDERAL AID		STATE	
	ROUTE	PROJECT	ROUTE	PROJECT
VA.	---	---	828	0828-029-248, B-601

		PROJECT #: 45494-027 LOCATION: W&OD Trail over Wiehle Avenue STRUCTURE: TRAIL		B-11 PAGE 1 OF 2	
STATION: 11725.00 NORTHING: 7031273.94 ft SURFACE ELEVATION: 379.0 ft		OFFSET: 12.00 ft LT Easting: 11814191.65 ft COORD. DATUM: VA North			
FIELD DATA		Date(s) Drilled: 10/26/2016 - 10/26/2016		LAB DATA	
Drilling Method(s): HSA SPT Method: Automatic Hammer Other Test(s): Driller: Raymond Logger: B Grass				LIQUID LIMIT PLASTICITY INDEX MOISTURE CONTENT (%)	
GROUND WATER					
FIELD DESCRIPTION OF STRATA		LL		PI	
0.0 / 379.0 Brown, Sandy SILT, dry ML					
REMARKS: Rig Type: CME-45C-2 Truck Rig.				PAGE 1 OF 2 B-11	

		PROJECT #: 45494-027 LOCATION: W&OD Trail over Wiehle Avenue STRUCTURE: TRAIL		B-11 PAGE 2 OF 2	
STATION: 11725.00 NORTHING: 7031273.94 ft SURFACE ELEVATION: 379.0 ft		OFFSET: 12.00 ft LT Easting: 11814191.65 ft COORD. DATUM: VA North			
FIELD DATA		Date(s) Drilled: 10/26/2016 - 10/26/2016		LAB DATA	
Drilling Method(s): HSA SPT Method: Automatic Hammer Other Test(s): Driller: Raymond Logger: B Grass				LIQUID LIMIT PLASTICITY INDEX MOISTURE CONTENT (%)	
GROUND WATER					
FIELD DESCRIPTION OF STRATA		LL		PI	
30 32 34 345 22 50/1" 33 33.5 35 36 38 340 50/1" 5 38.5 40 42 44 335 50/2" 11 43.5 45 46 48 330 50/3" 17 48.5 50 50					
REMARKS: Rig Type: CME-45C-2 Truck Rig.				PAGE 2 OF 2 B-11	

		PROJECT #: 45494-027 LOCATION: W&OD Trail over Wiehle Avenue STRUCTURE: TRAIL		B-12 PAGE 1 OF 2	
STATION: 11900.00 NORTHING: 7031216.74 ft SURFACE ELEVATION: 363.0 ft		OFFSET: 12.00 ft LT Easting: 11814357.04 ft COORD. DATUM: VA North			
FIELD DATA		Date(s) Drilled: 10/27/2016 - 10/27/2016		LAB DATA	
Drilling Method(s): HSA SPT Method: Automatic Hammer Other Test(s): Driller: Raymond Logger: B Grass				LIQUID LIMIT PLASTICITY INDEX MOISTURE CONTENT (%)	
GROUND WATER					
FIELD DESCRIPTION OF STRATA		LL		PI	
0.0 / 363.0 Brown, SILT with trace Sand, dry ML					
REMARKS: Rig Type: CME-45C-2 Truck Rig.				PAGE 1 OF 2 B-12	

A copy of the original signed geotechnical submittal is on file with the County.

The subsurface information shown on the boring logs in these plans was obtained with reasonable care and recorded in good faith solely for use by the County in establishing design controls for the project. The County has no reason to suspect that such information is not reasonably accurate as an approximate indication of the subsurface conditions at the sites where the borings were taken. The County does not in any way warrant or guarantee that such data can be projected as indicative of conditions beyond the limits of the borings shown; and any such projections by bidders are purely interpretive and altogether speculative. Further, the County does not in any way guarantee, either expressly or by implication, the sufficiency of the information for bid purposes.

The boring logs are made available to bidders in order that they may have access to subsurface data identical to that which is possessed by the County, and are not intended as a substitute for personal investigation, interpretation and judgment by the bidders.


PREFINAL PLANS					
EMERGENCY POLICE - FIRE - RESCUE 911					
FAIRFAX COUNTY, VIRGINIA DEPARTMENT OF PUBLIC WORKS AND ENVIRONMENTAL SERVICES 12000 GOVERNMENT CENTER PARKWAY, SUITE 449 FAIRFAX, VA., 22035-0052					
OFFICE OF CAPITAL FACILITIES 703-324-5800				WIEHLE AVENUE (RTE 828) AT W&OD TRAIL ENGINEERING GEOLOGY 3 OF 6	
PROJECT NO: 1400102-2013				PLAN NO. XXX-XX	
DESIGNED: JRM DRAFTED: CRR CHECKED: TAB				SHEET 6(19)	
FUND # 500-C5000					

THESE PLANS ARE UNFINISHED AND UNAPPROVED AND ARE NOT TO BE USED FOR ANY TYPE OF CONSTRUCTION.




PROJECT MANAGER: SCOTT, RUFFNER, P.E., (703) 287-5236  
SURVEYED BY, DATE: FAIRFAX COUNTY  
DESIGN BY: WHITMAN, REQUARDT & ASSOCIATES, LLP, (703) 293-9717  
SUBSURFACE UTILITY BY, DATE: SO DEEP, INC. (703) 361-6005, December 23, 2014

STATE	FEDERAL AID		STATE	
	ROUTE	PROJECT	ROUTE	PROJECT
VA.	---	---	828	0828-029-248, B-601

										PROJECT #: 45494-027 LOCATION: W&OD Trail over Wiehle Avenue STRUCTURE: TRAIL			B-12 PAGE 2 OF 2			
STATION: 11900.00 NORTHING: 7031216.74 ft SURFACE ELEVATION: 363.0 ft										OFFSET: 12.00 ft LT Easting: 11814357.04 ft COORD. DATUM: VA North						
FIELD DATA										Date(s) Drilled: 10/27/2016 - 10/27/2016 Drilling Method(s): HSA SPT Method: Automatic Hammer Other Test(s): Driller: Raymond Logger: B Grass					LAB DATA	
DEPTH (ft)	ELEVATION (ft)	SOIL		SAMPLE LEGEND	ROCK			CORE RECOVERY (%)	ROCK QUALITY DESIGNATION	STRATA	JOINTS	STRATA LEGEND	LL	PI	MOISTURE CONTENT (%)	
		STANDARD PENETRATION TEST HAMMER BLOWS	SOIL RECOVERY (%)		DIP °											
GROUND WATER																
FIELD DESCRIPTION OF STRATA																
32	330	13	30 50/5"	33.5												
34				35												
36																
38	325		30 50/5"	61	38.5											
40					40											
42																
44	320		40 50/5"	61	43.5											
46					45											
48	315		37 50/4"	55	48.5											
50					50											
REMARKS: Rig Type: CME-45C-2 Truck Rig.													PAGE 2 OF 2 B-12			

SPT LOGS W&OD WIEHLE AVE.GP:J8.30.004392710:4/17

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										PROJECT #: 45494-027 LOCATION: W&OD Trail over Wiehle Avenue STRUCTURE: TRAIL			B-13 PAGE 1 OF 1			
STATION: 12050.00 NORTHING: 7031167.13 ft SURFACE ELEVATION: 355.0 ft										OFFSET: 33.97 ft RT Easting: 11814500.48 ft COORD. DATUM: VA North						
FIELD DATA										Date(s) Drilled: 10/26/2016 - 10/26/2016 Drilling Method(s): HSA SPT Method: Automatic Hammer Other Test(s): Driller: Raymond Logger: B Grass					LAB DATA	
DEPTH (ft)	ELEVATION (ft)	SOIL		SAMPLE LEGEND	ROCK			CORE RECOVERY (%)	ROCK QUALITY DESIGNATION	STRATA	JOINTS	STRATA LEGEND	LL	PI	MOISTURE CONTENT (%)	FINES CONTENT #200 (%)
		STANDARD PENETRATION TEST HAMMER BLOWS	SOIL RECOVERY (%)		DIP °											
GROUND WATER																
FIELD DESCRIPTION OF STRATA																
3		3	55													0.0 / 355.0 Gravel <b>GP</b>
2		9	7	28	1.5											0.5 / 354.5 Brown, Silty fine SAND, dry <b>SM</b>
4		7	7		4											2.5 / 352.5 Brown, Sandy SILT, dry <b>ML</b>
6	350	4	4	33	5											
8		6	9	78	6.5											
10		345	12		8.5											
12					10											
14		20	50/5"	61	13.5											
16	340				15											
18		14	15	78	18.5											
20	335		48		20											
REMARKS: Rig Type: CME-45C-2 Truck Rig.													PAGE 1 OF 1 B-13			

SPT LOGS W&OD WIEHLE AVE.GP:J8.30.004392710:4/17

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A copy of the original signed geotechnical submittal is on file with the County.

PREFINAL PLANS									
EMERGENCY POLICE - FIRE - RESCUE 911									
FAIRFAX COUNTY, VIRGINIA DEPARTMENT OF PUBLIC WORKS AND ENVIRONMENTAL SERVICES 12000 GOVERNMENT CENTER PARKWAY, SUITE 449 FAIRFAX, VA., 22035-0052									
R E V I S I O N S						OFFICE OF CAPITAL FACILITIES 703-324-5800			
						WIEHLE AVENUE (RTE 828) AT W&OD TRAIL ENGINEERING GEOLOGY 4 OF 6			
						PROJECT NO: 1400102-2013			
						PLAN NO. XXX-XX	DESIGNED: JRM DRAFTED: CRR CHECKED: TAB	SHEET 6(20)	
						APPROVED BY THE TRANSPORTATION DESIGN DIVISION			
WHITMAN REQUARDT & ASSOCIATES RICHMOND, VA STRUCTURAL ENGINEER					FUND # 500-C5000				

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PROJECT MANAGER: SCOTT, BUFFNER, P.E., (703) 877-5236  
SURVEYED BY, DATE: FAIRFAX COUNTY  
DESIGN BY: WHITMAN, REQUARDT & ASSOCIATES, LLP, (703) 293-9717  
SUBSURFACE UTILITY BY, DATE: SO DEEP, INC., (703) 361-6005, December 23, 2014

STATE	ROUTE	FEDERAL AID	ROUTE	STATE
		PROJECT		PROJECT
VA.	---	---	828	0828-029-248, B-601



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Notes: See borehole logs for complete data  
See Material and Sample Symbols List

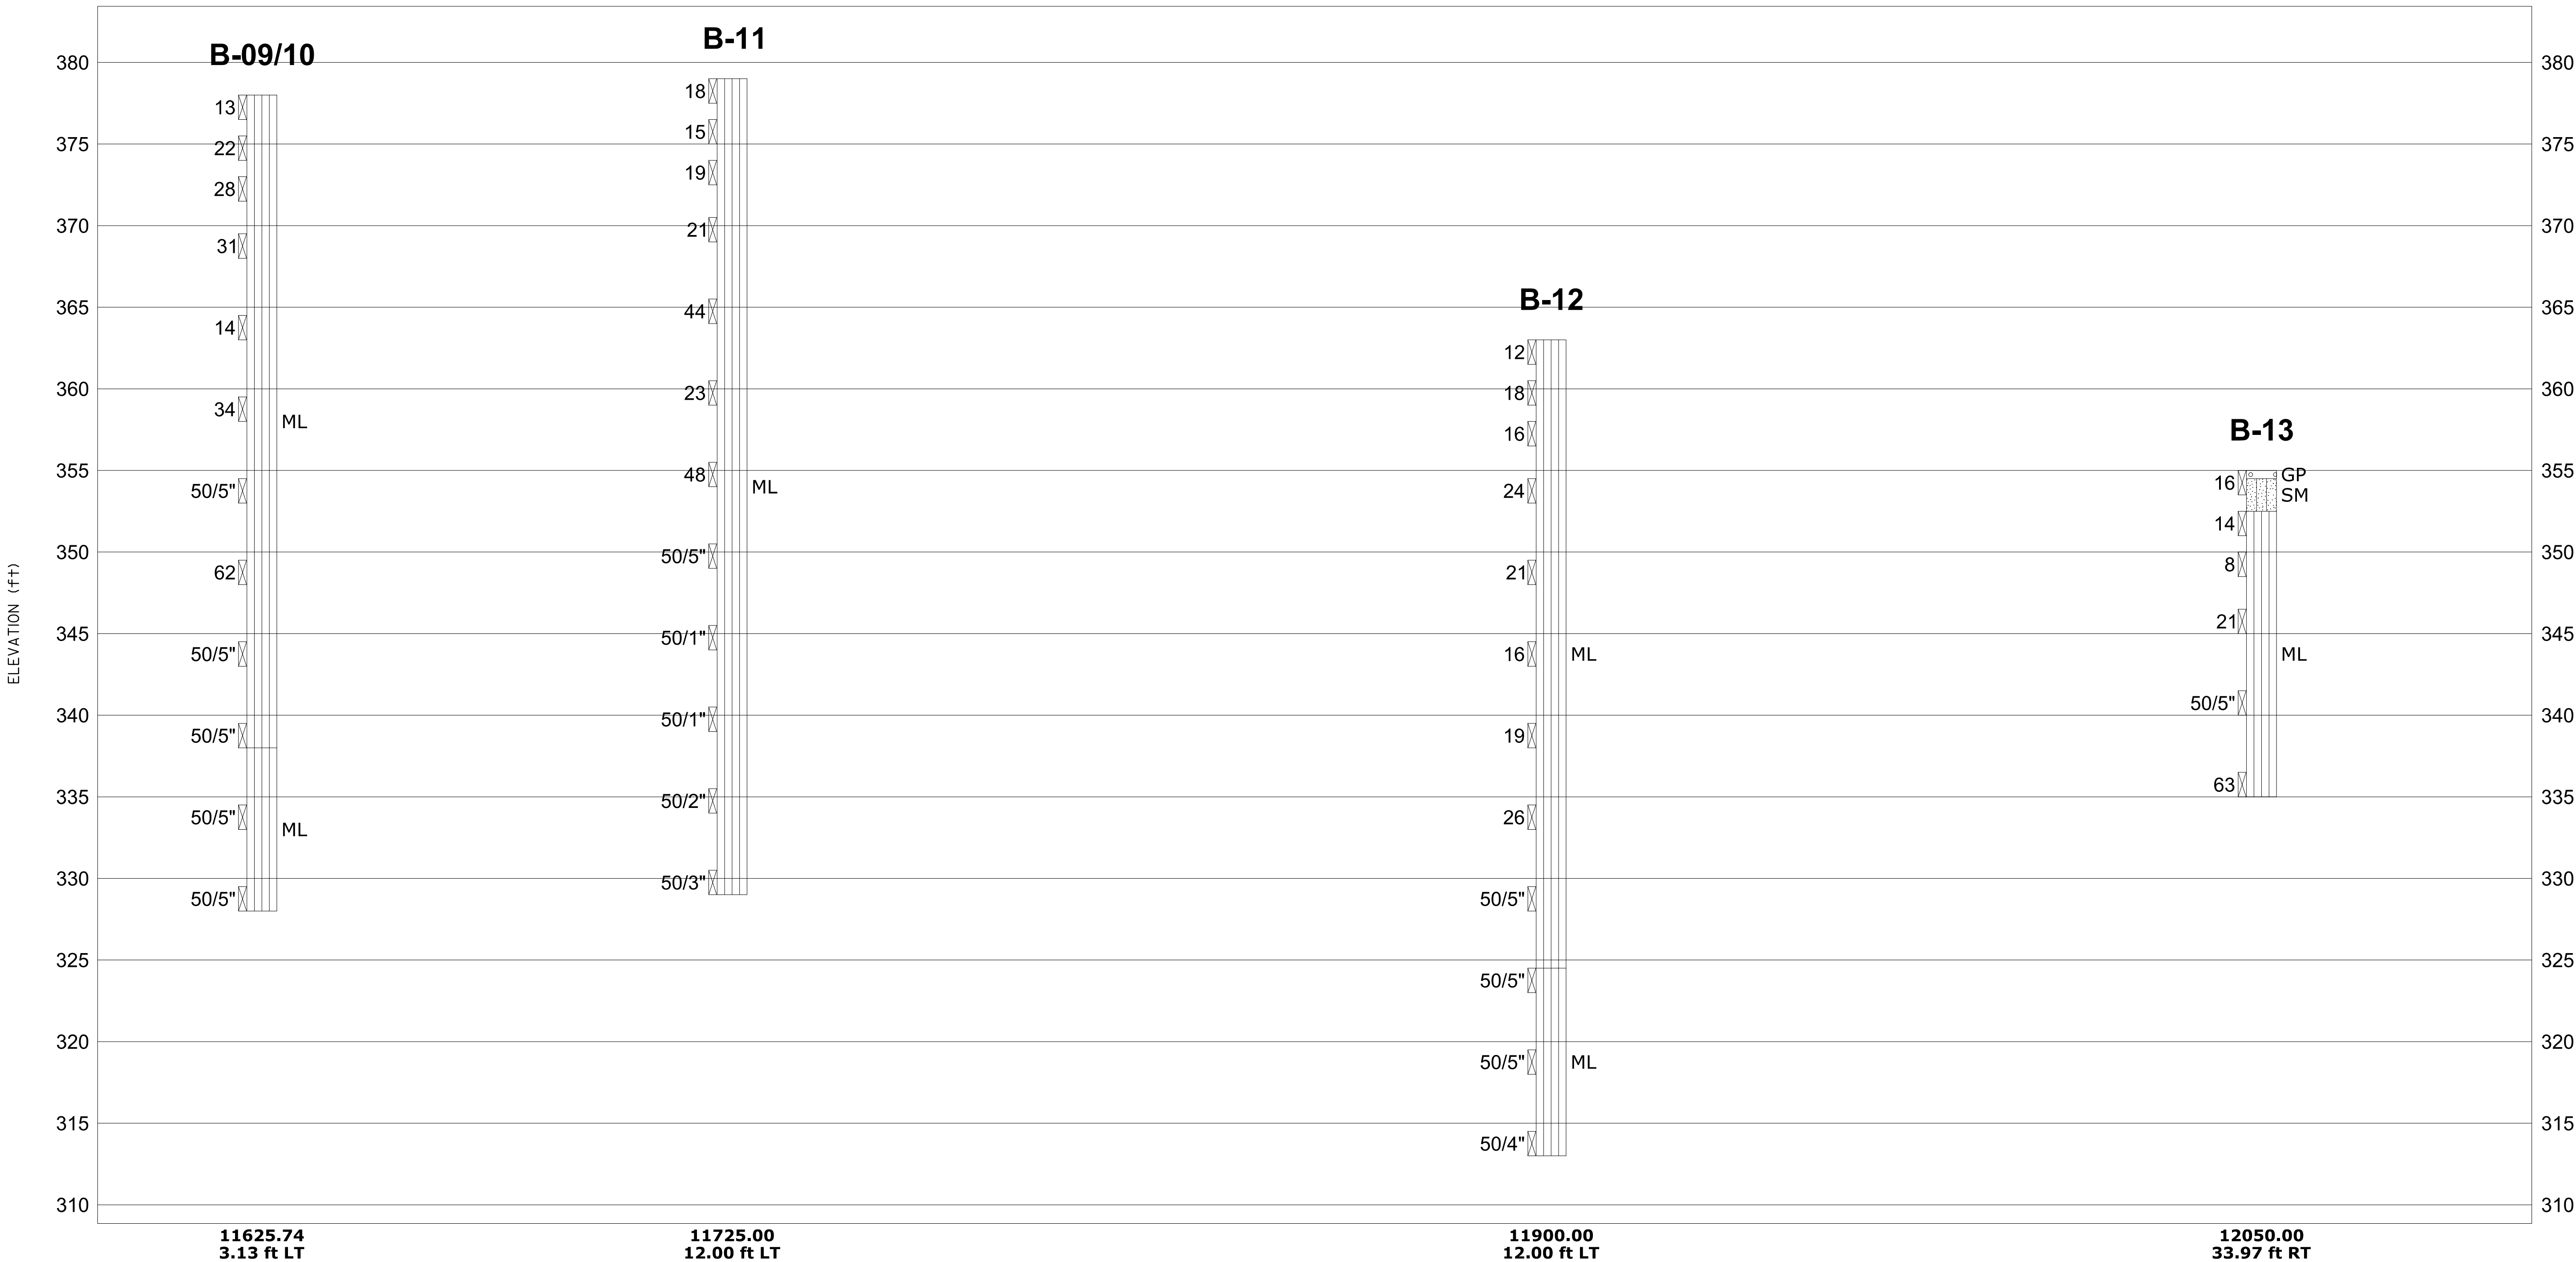
EMERGENCY POLICE - FIRE - RESCUE 911			
FAIRFAX COUNTY, VIRGINIA			
DEPARTMENT OF PUBLIC WORKS AND ENVIRONMENTAL SERVICES			
12000 GOVERNMENT CENTER PARKWAY, SUITE 449 FAIRFAX, VA., 22035-0052			
OFFICE OF CAPITAL FACILITIES		703-324-5800	
WIEHLE AVENUE (RTE 828) AT W&OD TRAIL		ENGINEERING GEOLOGY	
5 OF 6		PROJECT NO: 1400102-2013	
PLAN NO.	DESIGNED: JRM	SHEET	
XXX-XX	DRAFTED: CRR	6(21)	
CHECKED: TAB		FUND # 500-C5000	

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PROJECT MANAGER \_SCOTT\_BUFFNER,P.E.\_ (703) 287-5236 -----  
SURVEYED BY, DATE \_FAIRFAX COUNTY\_ -----  
DESIGN BY \_WHITMAN,REQUARDT\_ & ASSOCIATES,LLP (703) 293-9717 -----  
SUBSURFACE UTILITY BY, DATE \_SO DEEP,INC.(703) 361-6005 December 23,2014

STATE	FEDERAL AID		STATE	
	ROUTE	PROJECT	ROUTE	PROJECT
VA.	---	---	828	0828-029-248, B-601



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Notes: See borehole logs for complete data  
See Material and Sample Symbols List

WHITMAN REQUARDT & ASSOCIATES  
RICHMOND, VA  
STRUCTURAL ENGINEER

EMERGENCY POLICE - FIRE - RESCUE 911

FAIRFAX COUNTY, VIRGINIA

DEPARTMENT OF PUBLIC WORKS AND ENVIRONMENTAL SERVICES

12000 GOVERNMENT CENTER PARKWAY, SUITE 449 FAIRFAX, VA., 22035-0052

OFFICE OF CAPITAL FACILITIES  
703-324-5800

WIEHLE AVENUE (RTE 828) AT W&OD TRAIL

ENGINEERING GEOLOGY

6 OF 6

PROJECT NO: 1400102-2013

PLAN NO. XXX-XX

DESIGNED: JRM

DRAFTED: CRR

CHECKED: TAB

SHEET 6(22)

FUND # 500-C5000

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PROJECT MANAGER, SCOTT RUFFNER, P.E. (703) 877-5736  
SURVEYED BY, DATE FAIRFAX COUNTY  
DESIGN BY WHITMAN, REQUARDT & ASSOCIATES, LLP (703) 293-9717  
SUBSURFACE UTILITY BY, DATE SO DEEP, INC. (703) 361-6005 December 23, 2014

STATE	FEDERAL AID		STATE	
	ROUTE	PROJECT	ROUTE	PROJECT
VA.	—	—	828	0828-029-248, B-601

MSE WALL GENERAL NOTES:

Specifications:

Construction: Virginia Department of Transportation Road and Bridge Specifications, 2016.

Design: AASHTO LRFD Bridge Design Specifications, 7th Edition, 2014; and  
VDOT Modifications

Standards: Virginia Department of Transportation Road and Bridge Standards, 2016.

These plans are incomplete unless accompanied by the Supplemental Specifications and Special Provisions.

The minimum design life of MSE wall shall be 100-year for walls within 100 feet from edge of a bridge abutment and 75-year there after.

The anticipated MSE wall total settlement and estimated settlement waiting periods are shown on this sheet.

For bearing requirements, see the MSE Walls Design Data Table on this sheet.

Prior to wall construction, the foundation shall be compacted with a smooth wheel vibratory roller. The drums of the roller should be ballasted and each pass of the roller should overlap one half the width of the previous pass. The roller shall make at least ten passes over the proposed wall foundation zone. No density test will be required. Any foundation soils found to be unsuitable shall be removed and replaced with select material Type I minimum CBR of 30.

Minimum panel design thickness is 5.5 inches. Thickness of concrete must increase to accommodate any architectural surface finish that may be specified. Maximum panel dimensions shall not exceed 5 ft.x10 ft.

A geotextile shall be used as a separator between the mechanically stabilized earth mass, retained fill, and the subbase. A geotextile is not necessary separating the mechanically stabilized earth mass and subbase if a minimum of 6 inches of compacted No. 21B stone is placed on top of the subgrade.

Corrosion resistant reinforcing steel Class I shall be used in all copings.

Coping shall not be placed until wall completion and waiting periods are complete.

All coping designated herein shall be cast-in-place or precast concrete to the dimensions shown.

The selected wall supplier will submit a detailed design and shop drawings for approval.

Provide drainage details such as perforated pipe underdrain and/or drainage blanket based upon field conditions.

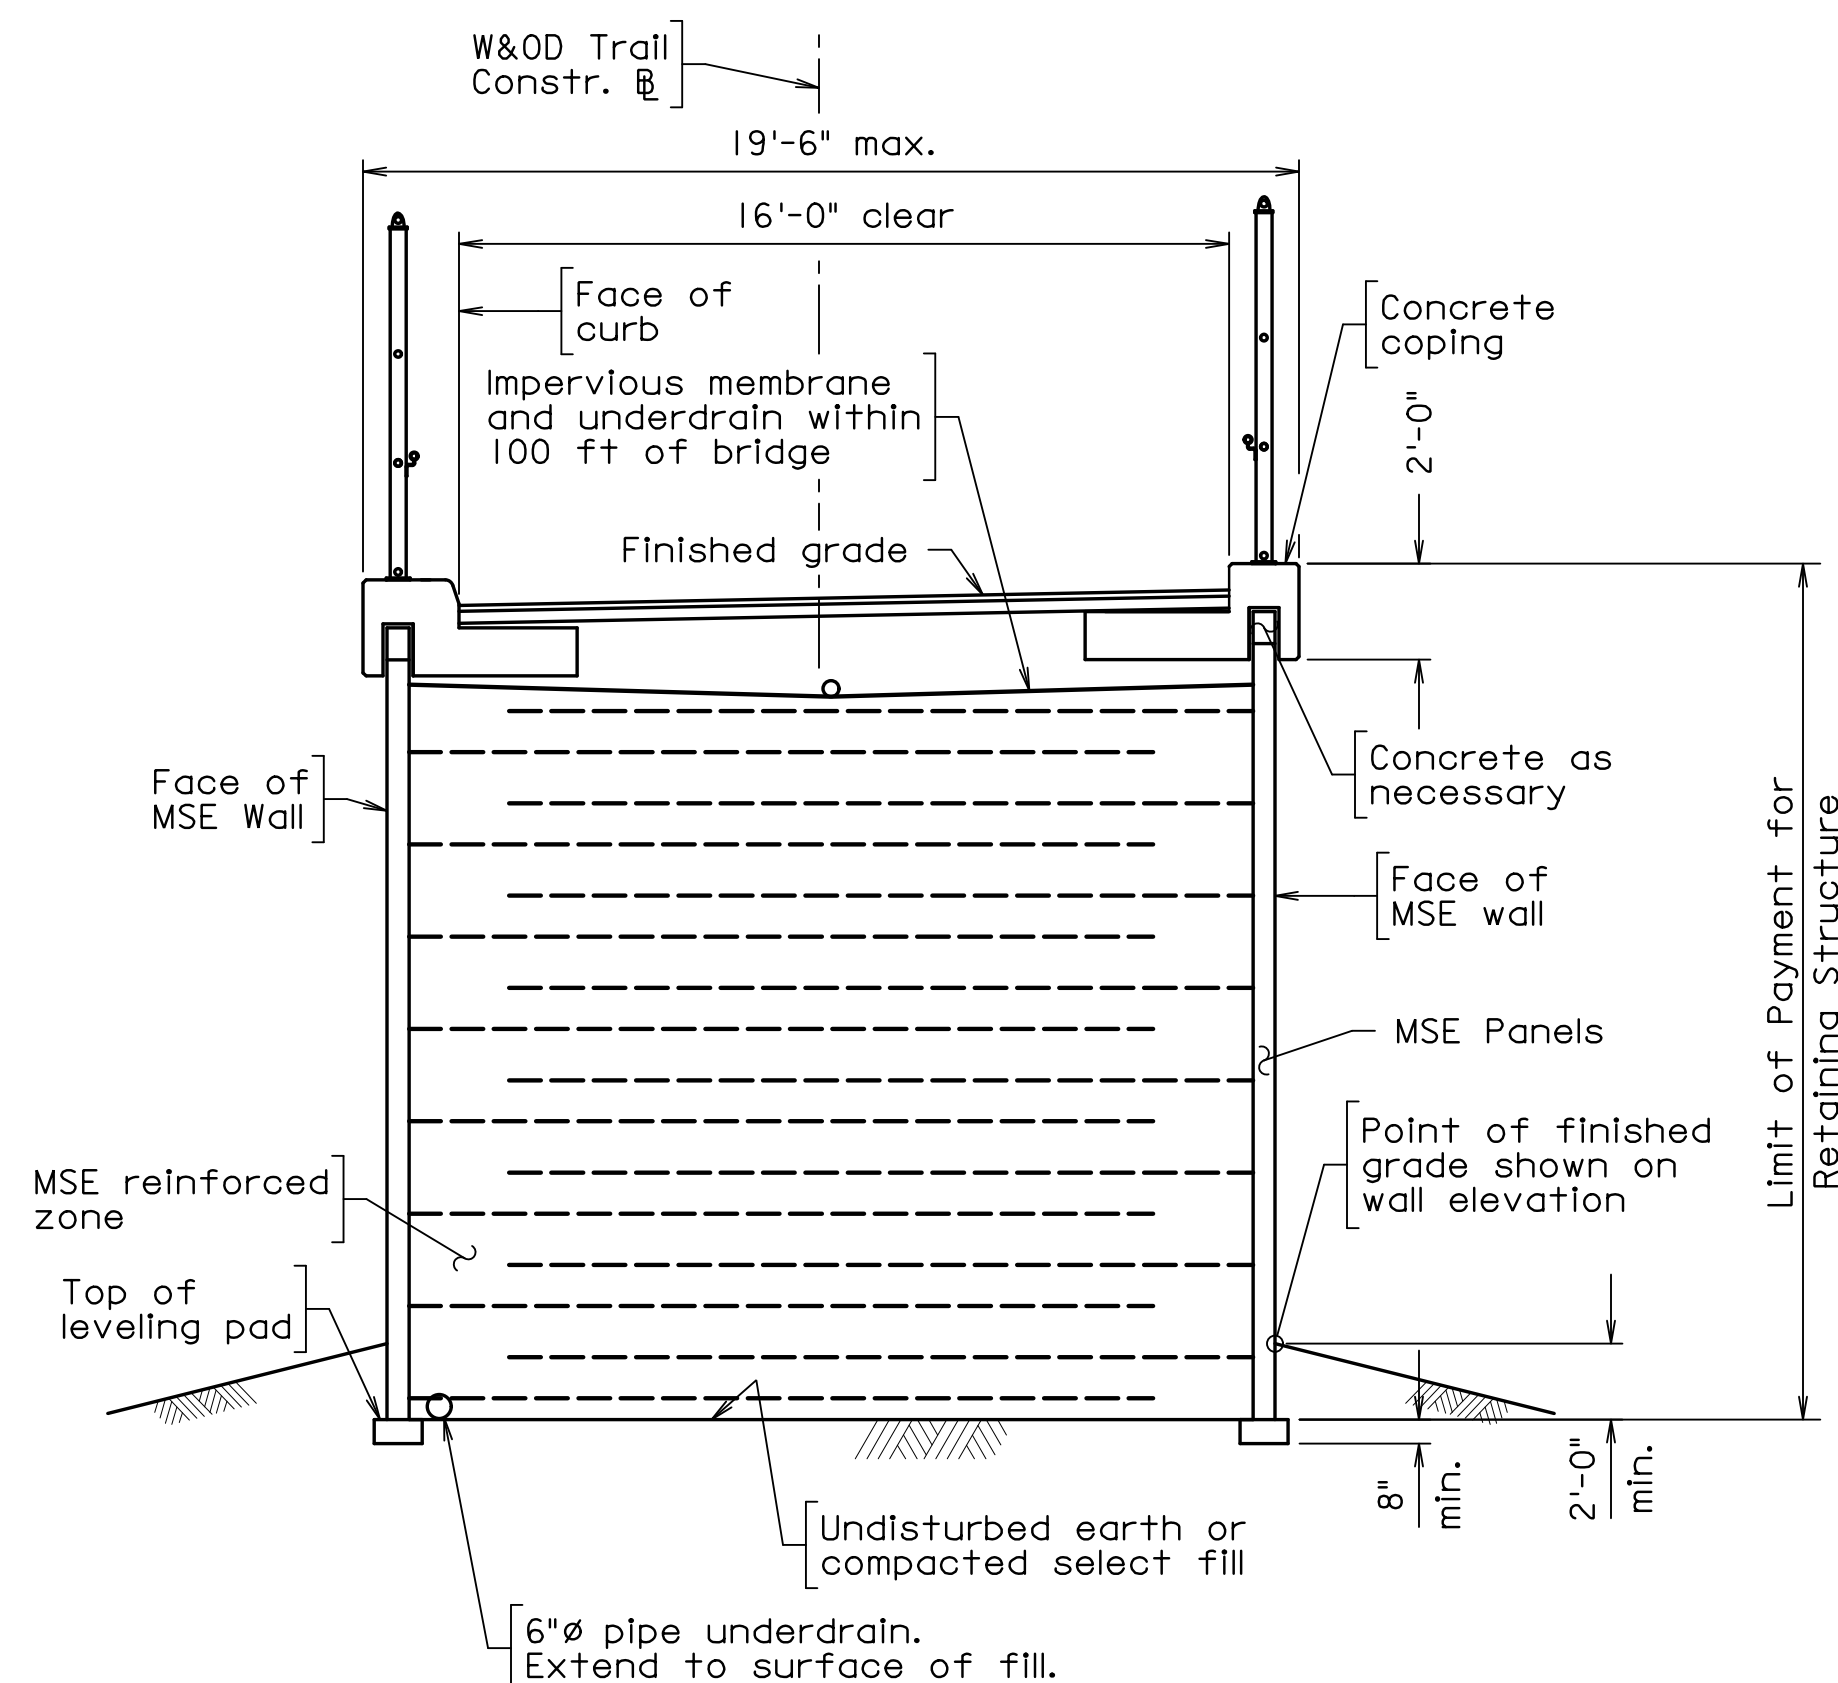
All panel types and other related elements shall be detailed on shop drawings.

Wall shall be designed to resist forces from retained fill with the following parameters:


Soil Friction angle  $\phi = 34$  degrees Ka = 0.283  
 Unit Weight = 125 lb/cf  
 Traffic Surcharge = 90 lb/sf  
 Handrail Lateral Force = 120 lb/ft

Contractor shall coordinate with all trades performing work within MSE wall limits.


Wall supplier shall include all details for the MSE coping and reaction slabs.



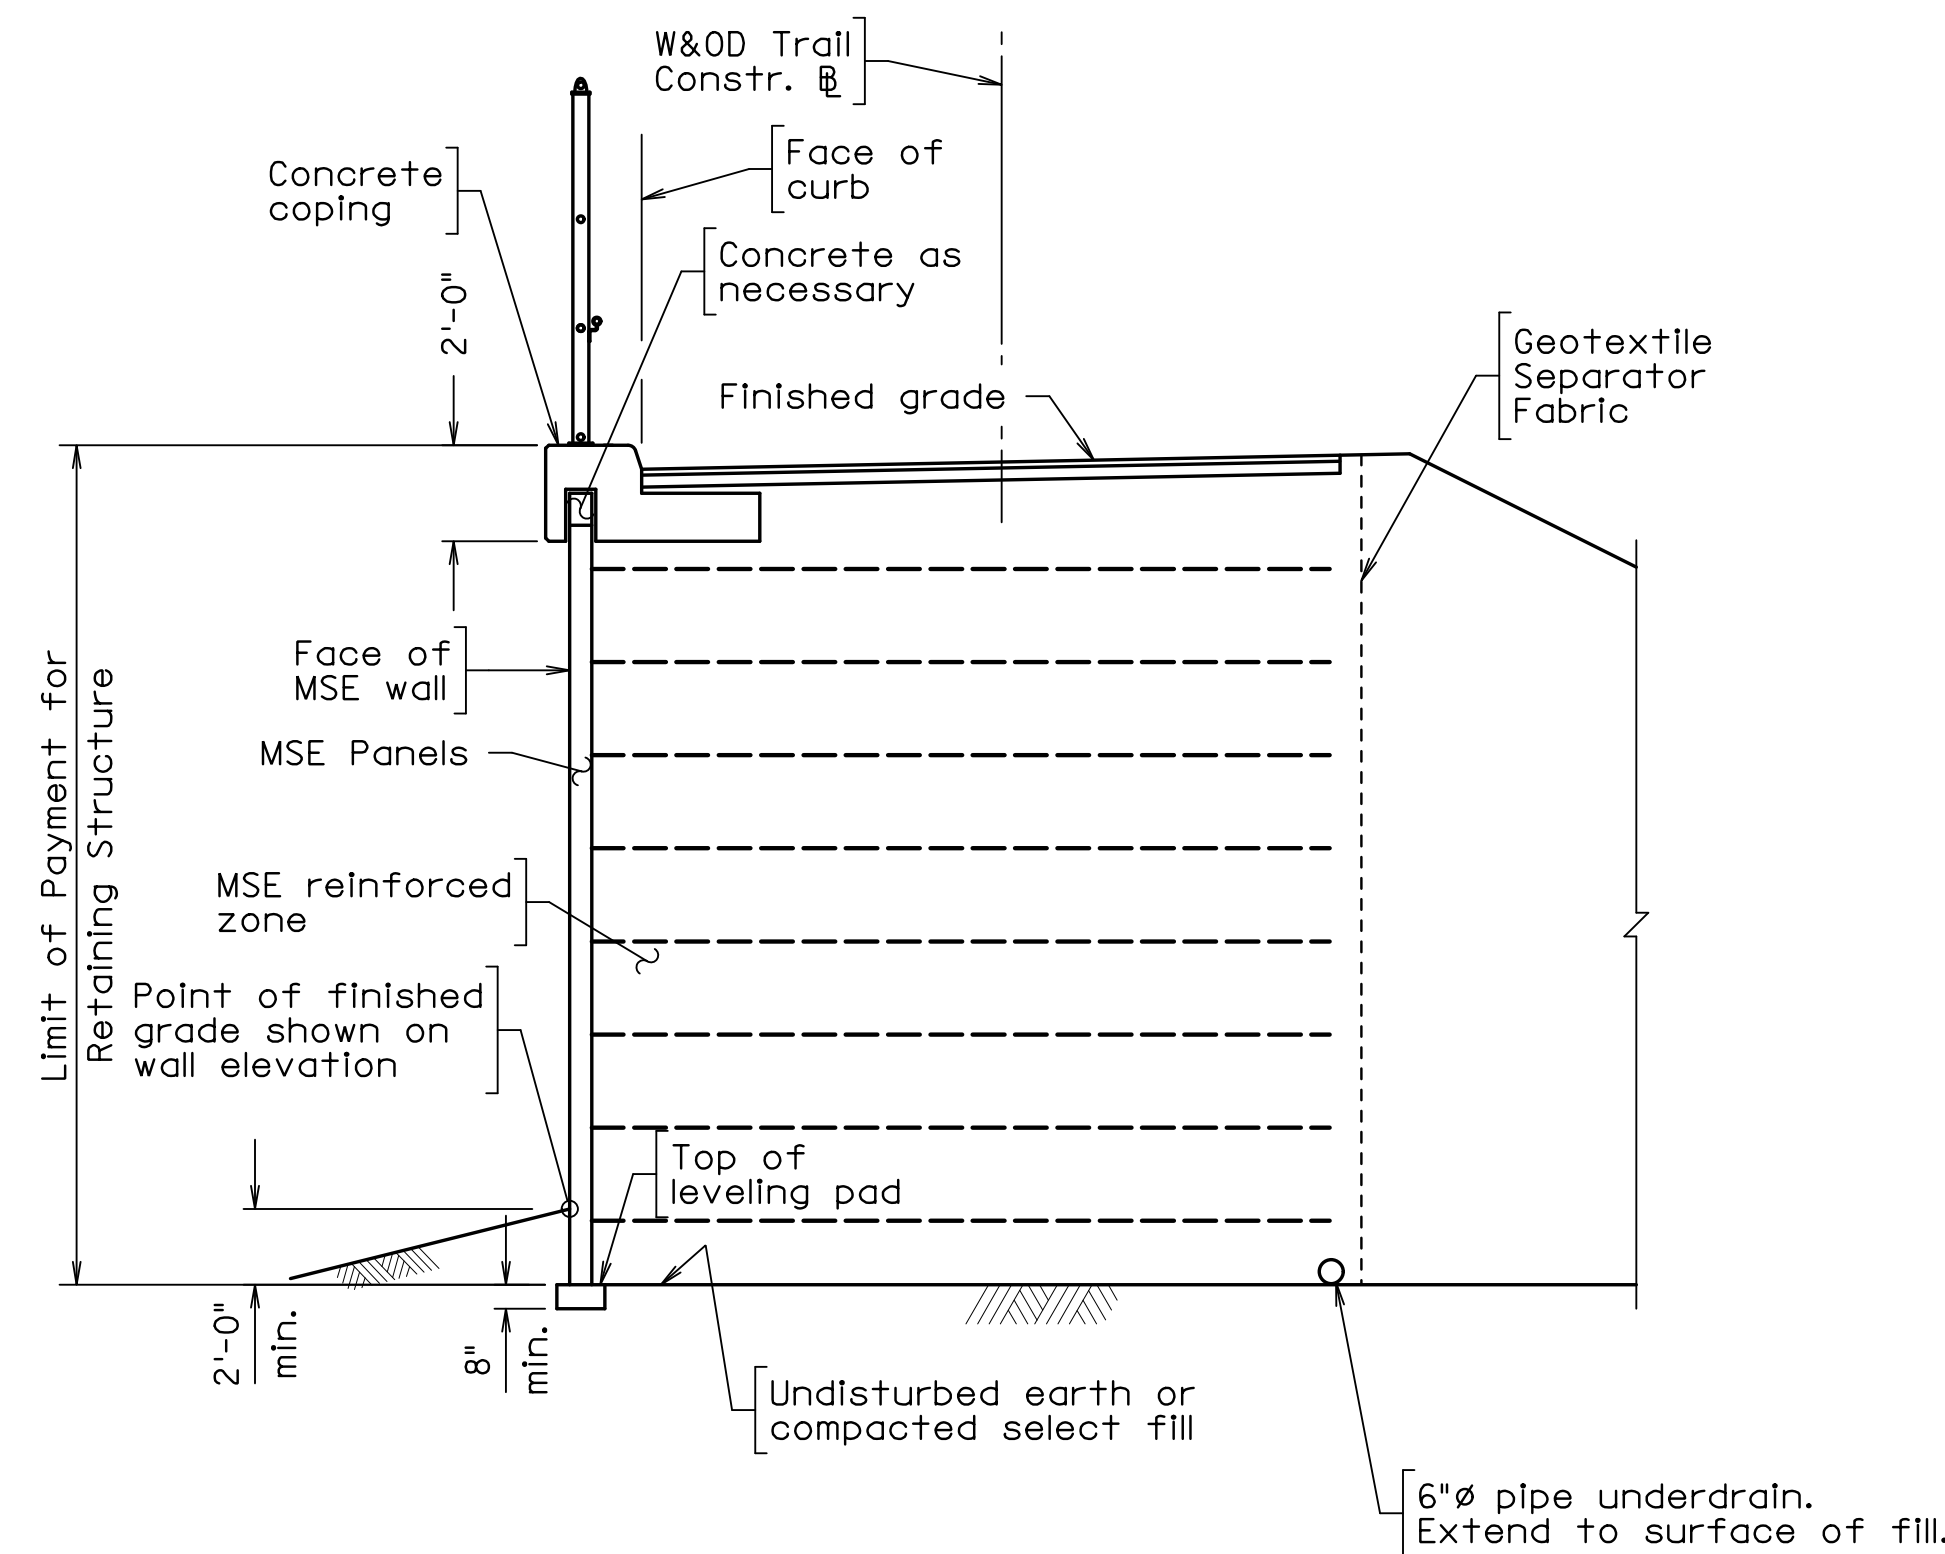TYPICAL SECTION THROUGH  
MSE WALLS 2, 3, 4, AND 5  
IN BRIDGE APPROACH SECTION



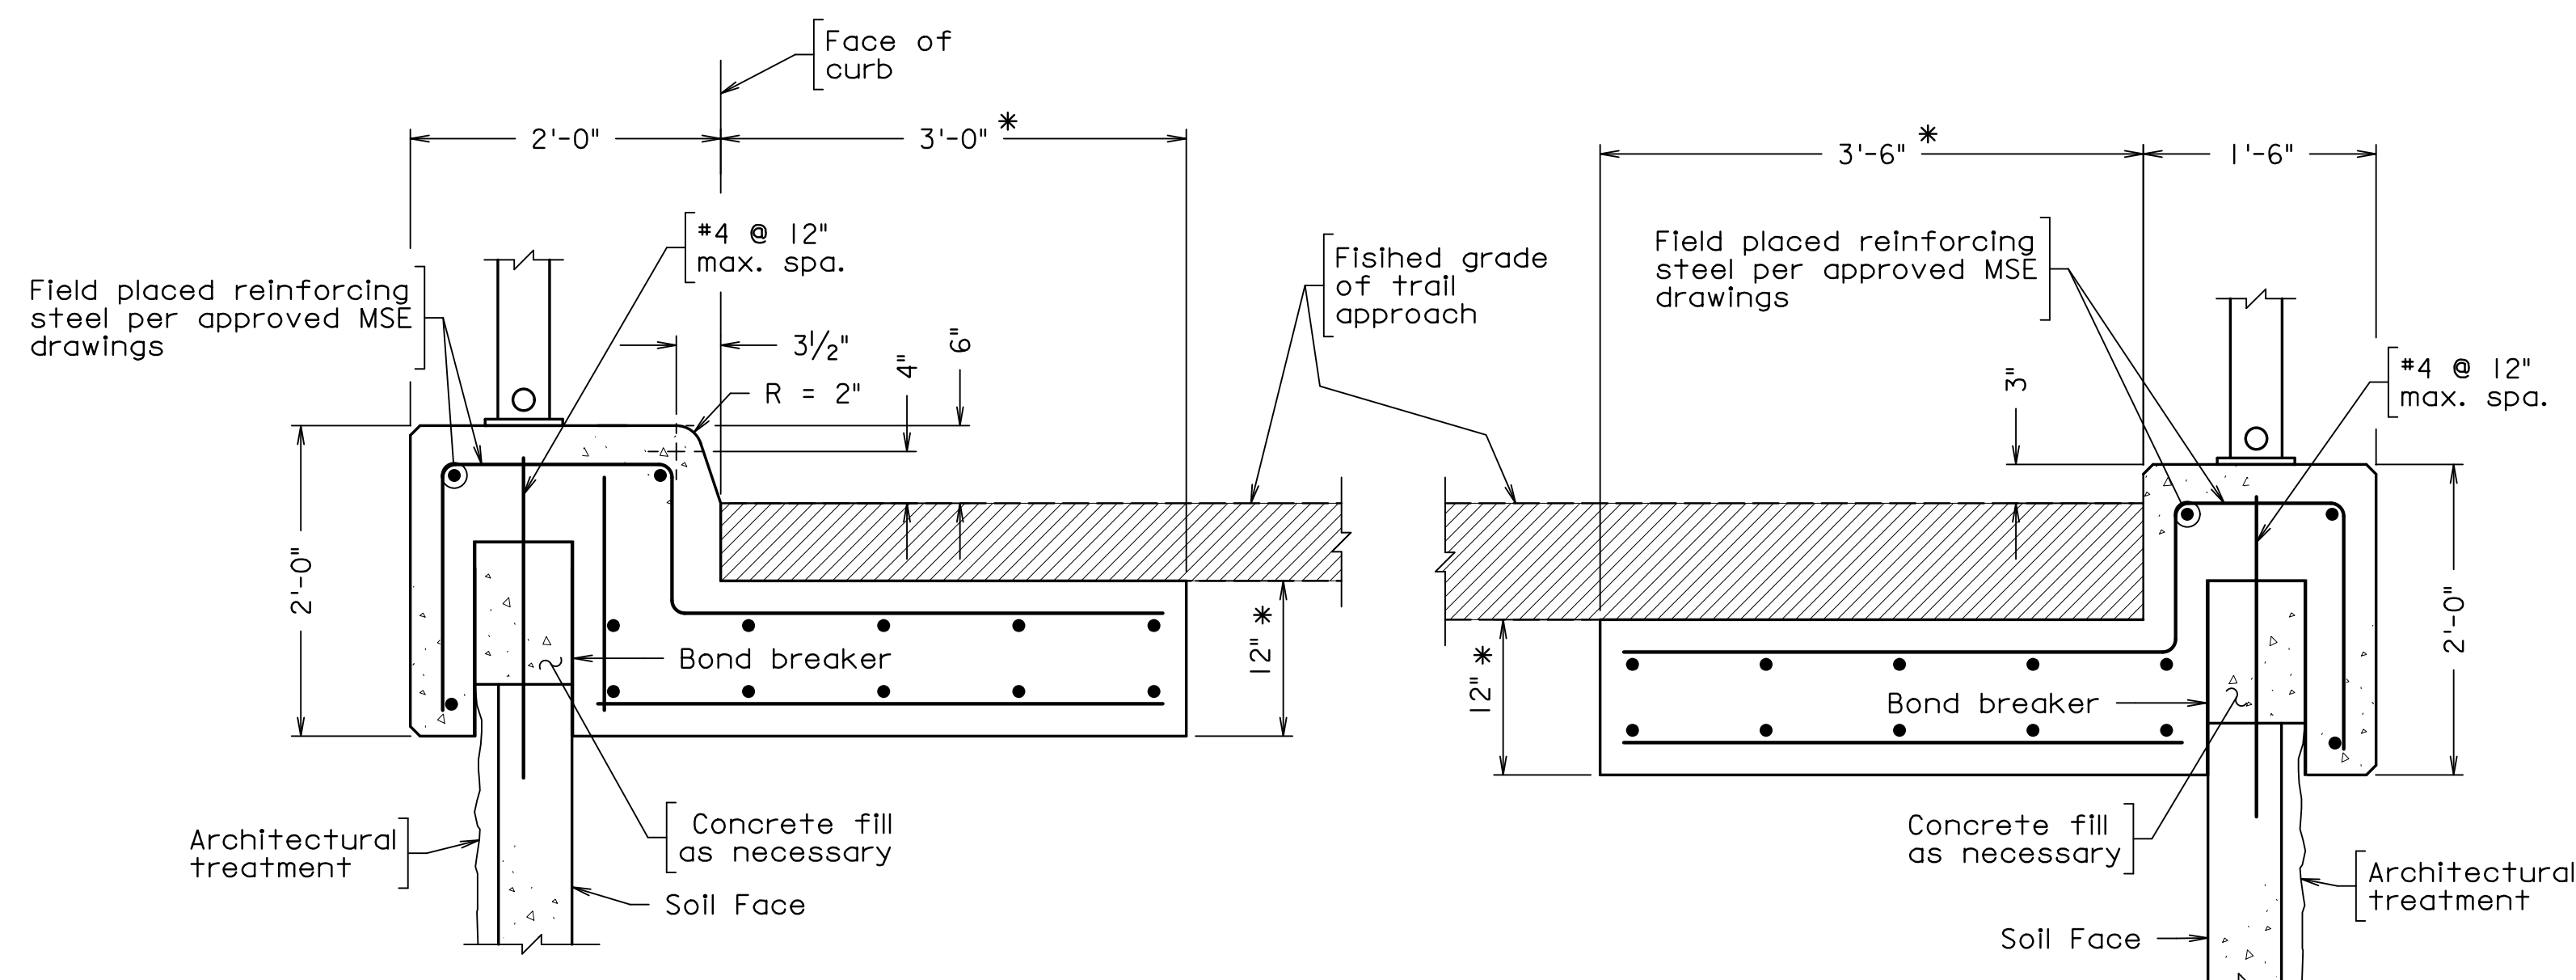TYPICAL SECTION THROUGH  
MSE WALL 4  
BEYOND STATION 42+00



## CAST-IN-PLACE REACTION SLAB DETAILS

\* Approximate dimension. Reaction slab details as determined by the MSE manufacturer.

MSE WALLS DESIGN DATA TABLE					
Wall	Minimum Strap Length  (ft)	Estimated Settlement  (in)	Estimated Settlement Waiting Period (weeks)	Service Limit State	Strength Limit State
				Applied Base Pressure (ksf)	Maximum Factored Bearing Resistance (ksf)
2	0.7H/6 ft.	< x 1.0 inch	None	5.9	8.0
3	0.7H/6 ft.	< x 1.0 inch	None	5.9	8.0
4	0.7H/6 ft.	< x 1.0 inch	None	5.9	8.5
5	0.7H/6 ft.	< x 1.0 inch	None	5.9	8.0

\* Minimum strap length shall be the greater of 6'-0" or 0.7H, where "H" is the height measured from the bottom of leveling pad to the top of the roadway.

PREFINAL PLANS

		EMERGENCY POLICE – FIRE – RESCUE 911							
		FAIRFAX COUNTY, VIRGINIA							
		DEPARTMENT OF PUBLIC WORKS AND ENVIRONMENTAL SERVICES							
		12000 GOVERNMENT CENTER PARKWAY, SUITE 449 FAIRFAX, VA., 22035-0052							
R E V I S I O N						OFFICE OF CAPITAL FACILITIES 703-324-5800			
						WIEHLE AVENUE (RTE 828) AT W&OD TRAIL MSE WALLS			
						GENERAL NOTES AND DETAILS			
						PROJECT NO: 1400102-2013			
						PLAN NO. XXX-XX			
WHITMAN REQUARDT & ASSOCIATES RICHMOND, VA STRUCTURAL ENGINEER						DESIGNED: JRM		SHEET 6(23)	
						DRAFTED: CRR			
						CHECKED: TAB			
		APPROVED BY THE TRANSPORTATION DESIGN DIVISION							
							FUND # 500-C5000		

FUND #	500-C5000
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Scale: 1" = 1'-0", unless otherwise shown

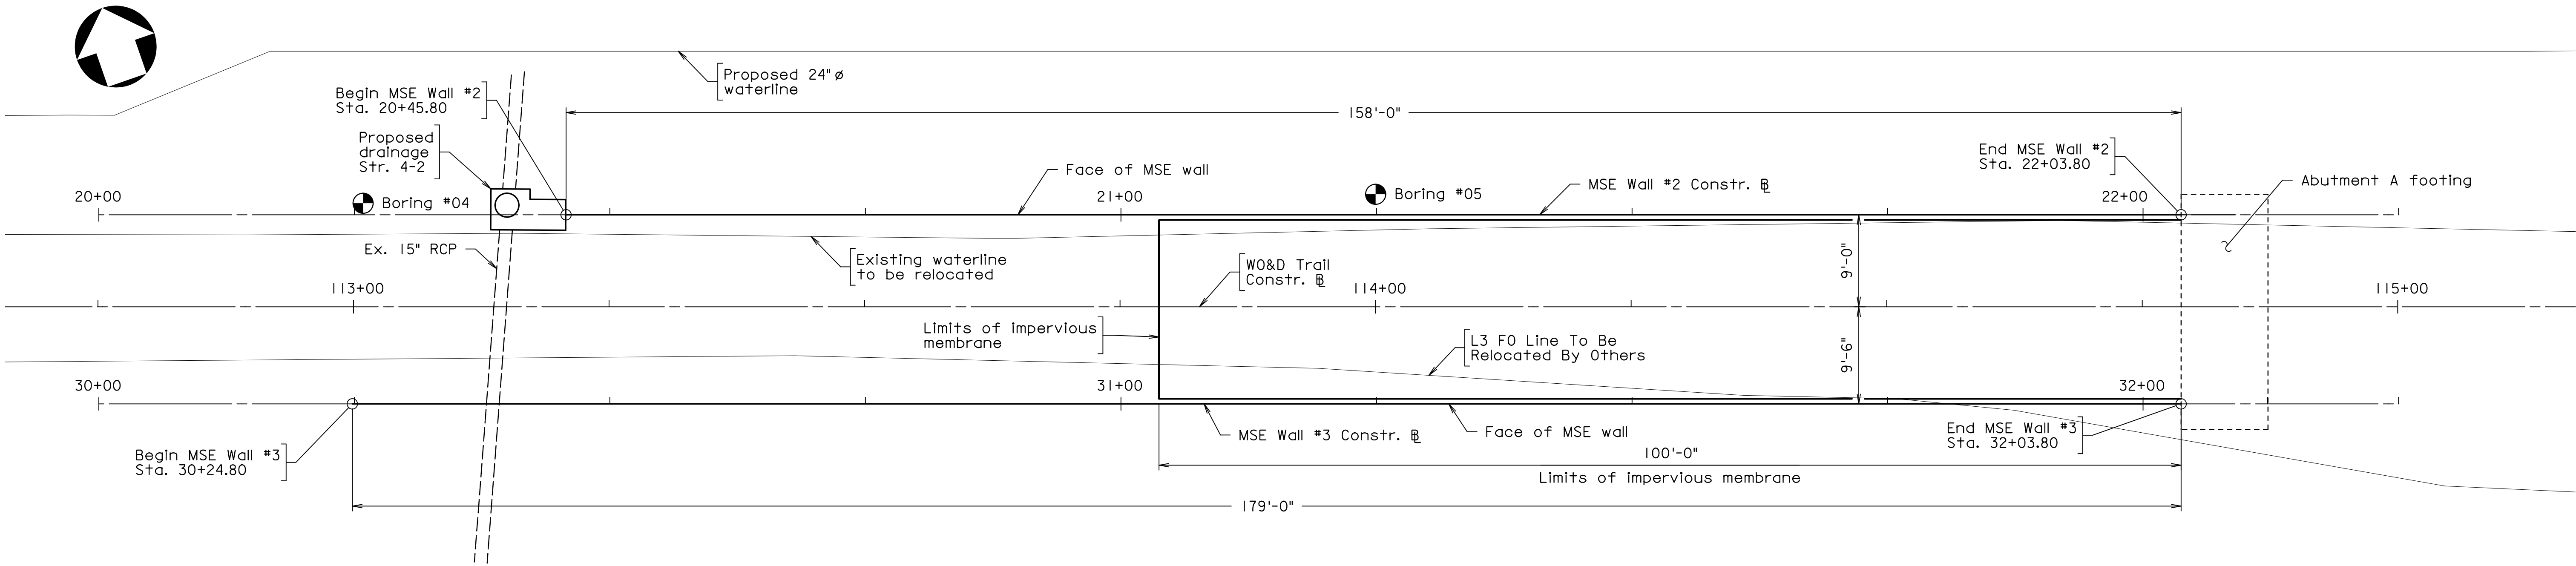
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PROJECT MANAGER: SCOTT, BUFFNER, P.E. (703) 877-5236  
SURVEYED BY, DATE: FAIRFAX COUNTY  
DESIGN BY: WHITMAN, REQUARDT & ASSOCIATES, LLP (703) 293-9717  
SUBSURFACE UTILITY BY, DATE: SO DEEP, INC. (703) 361-6005, December 23, 2014

STATE	FEDERAL AID		STATE	
	ROUTE	PROJECT	ROUTE	PROJECT
VA.	—	—	828	0828-029-248, B-601

Notes:  
For MSE Wall Baseline definitions, see sheet 1F(2)  
For boring logs, see sheet 6(17)  
For MSE wall general notes, see sheet 6(23)  
For wall elevations, see sheet 6(26)



MSE WALL LAYOUT - ABUTMENT A

PREFINAL PLANS

EMERGENCY POLICE - FIRE - RESCUE 911				
FAIRFAX COUNTY, VIRGINIA				
DEPARTMENT OF PUBLIC WORKS AND ENVIRONMENTAL SERVICES				
12000 GOVERNMENT CENTER PARKWAY, SUITE 449 FAIRFAX, VA., 22035-0052				
OFFICE OF CAPITAL FACILITIES 703-324-5800				
WIEHLE AVENUE (RTE 828) AT W&OD TRAIL MSE WALL LAYOUT 1 OF 2				
PROJECT NO: 1400102-2013				
PLAN NO. XXX-XX		DESIGNED: JRM DRAFTED: CRR CHECKED: TAB		SHEET 6(24)
FUND # 500-C5000				

WHITMAN REQUARDT & ASSOCIATES RICHMOND, VA STRUCTURAL ENGINEER	APPROVED BY THE TRANSPORTATION DESIGN DIVISION	DATE
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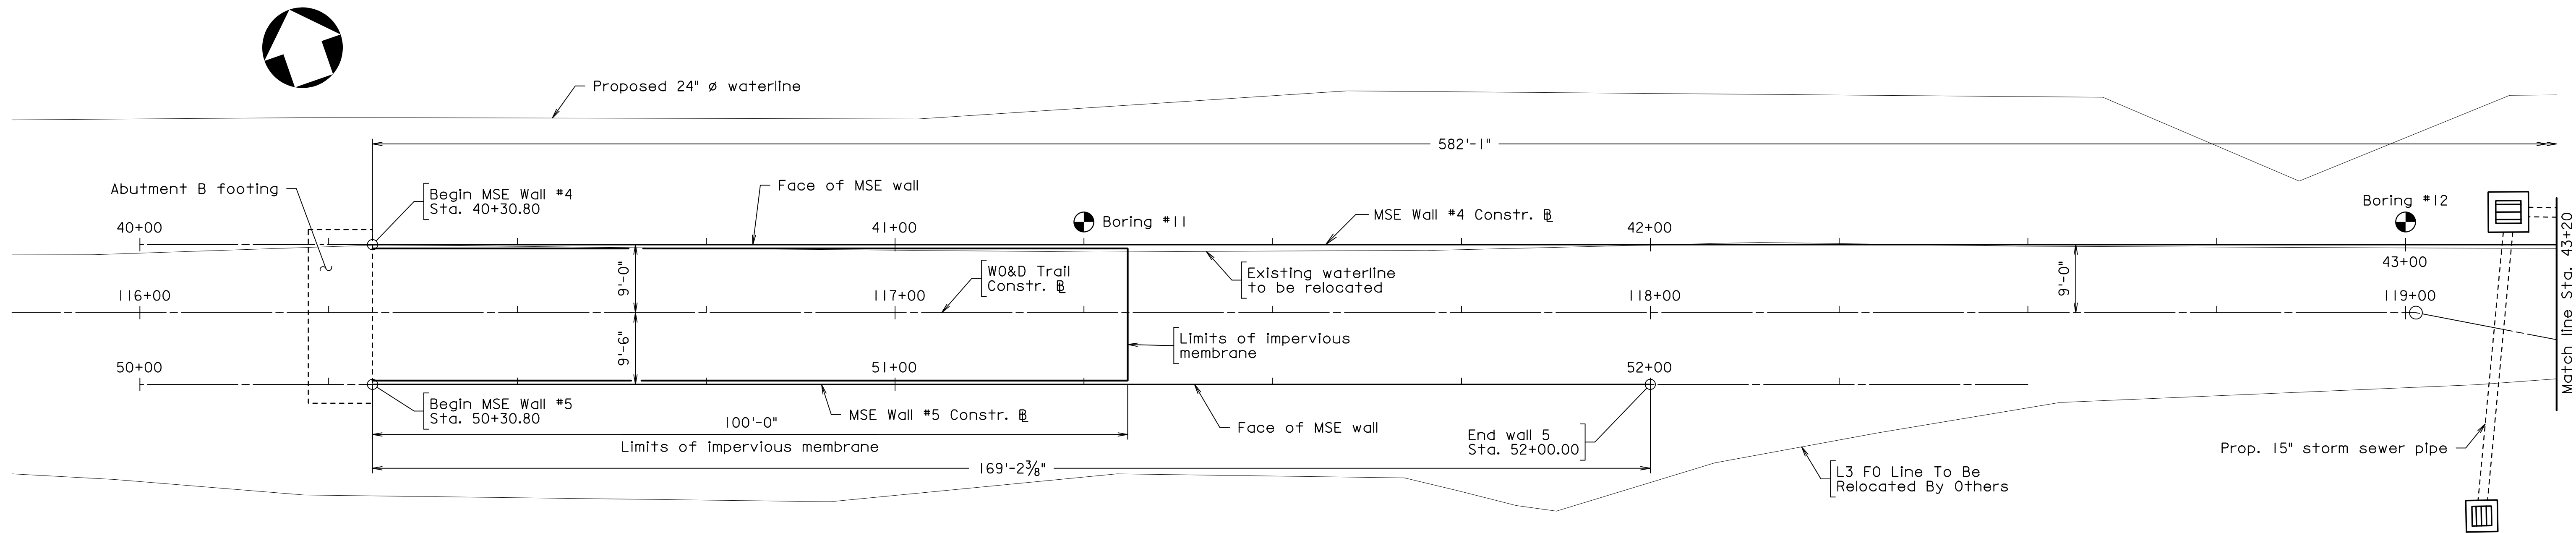
Scale: 1/8" = 1'-0"

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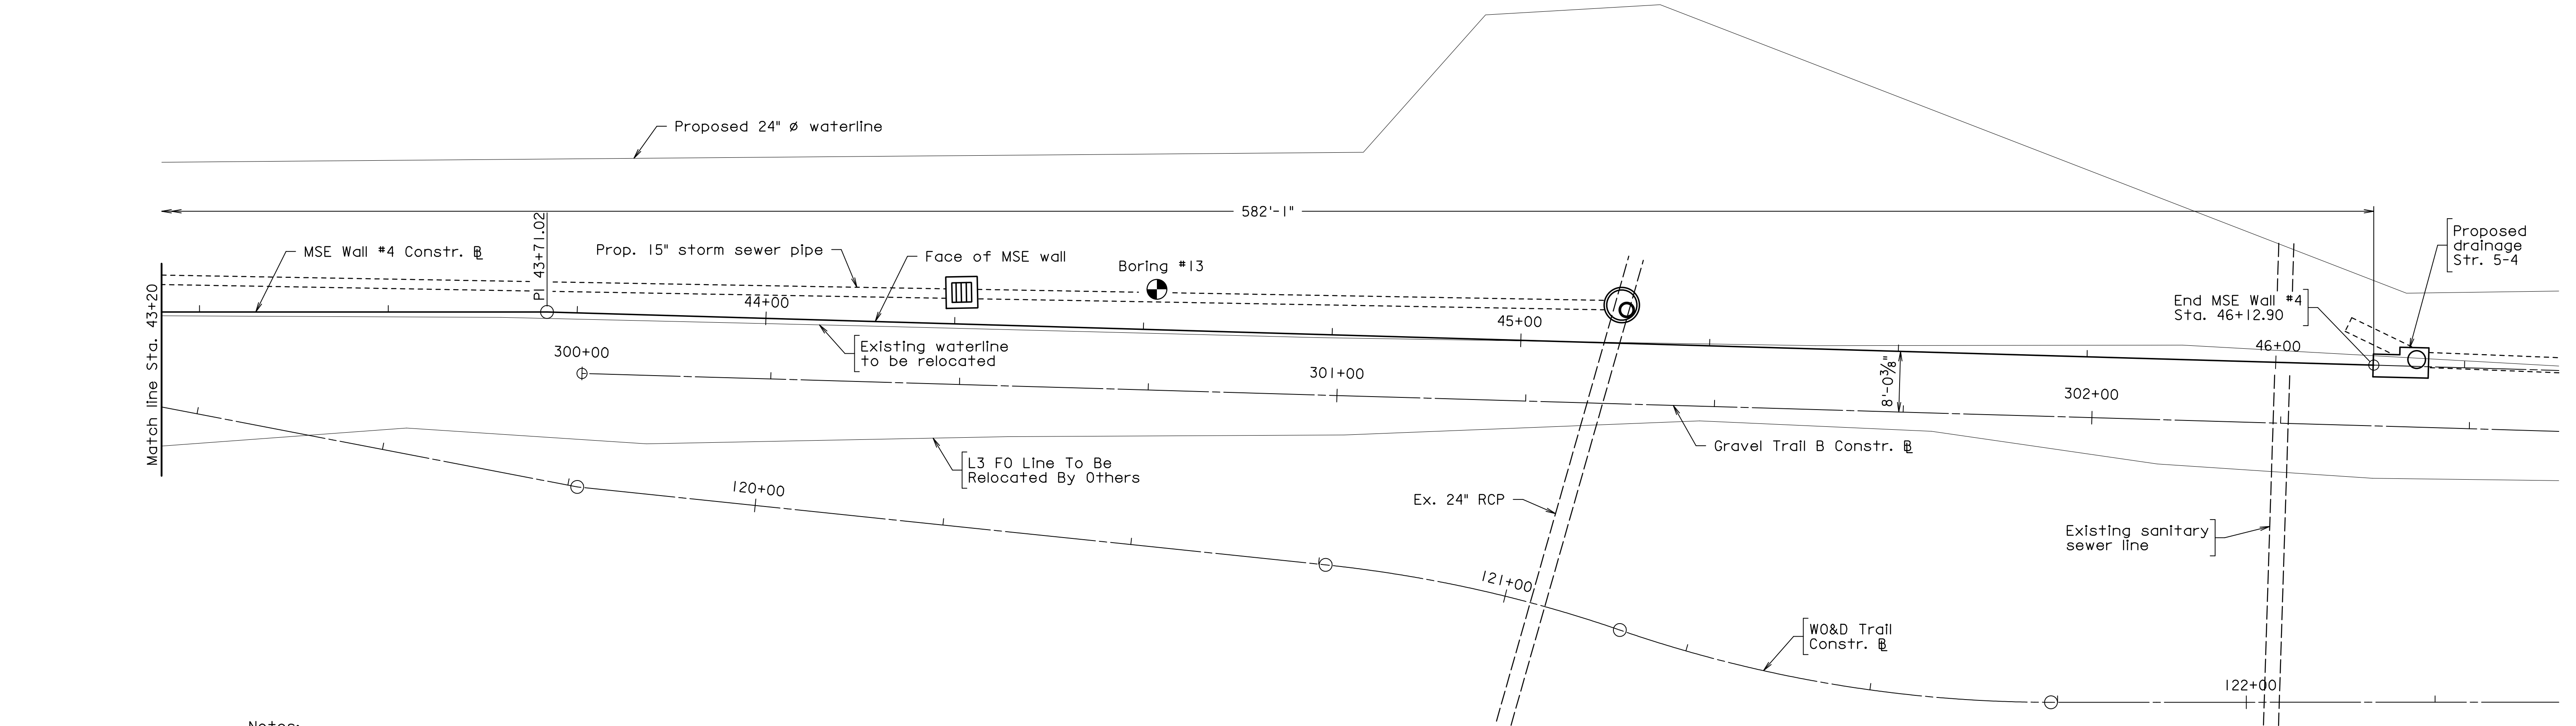


PROJECT MANAGER: SCOTT, BUFFNER, P.E. (703) 287-5236  
SURVEYED BY, DATE: FAIRFAX COUNTY  
DESIGN BY: WHITMAN, REQUARDT & ASSOCIATES, LLP (703) 293-9717  
SUBSURFACE UTILITY BY, DATE: SO DEEP, INC. (703) 361-6005 December 23, 2014

STATE	FEDERAL AID		STATE	
	ROUTE	PROJECT	ROUTE	PROJECT
VA.	—	—	828	0828-029-248, B-601



MSE WALL LAYOUT - ABUTMENT B



MSE WALL LAYOUT - ABUTMENT B

Notes:  
For MSE Wall Baseline definitions, see sheet 1F(2)  
For boring logs, see sheets 6(19) and 6(20)  
For MSE wall general notes, see sheet 6(23)  
For wall elevations, see sheets 6(27) and 6(28)

Scale: 3/32" = 1'-0"

EMERGENCY POLICE - FIRE - RESCUE 911			
FAIRFAX COUNTY, VIRGINIA			
DEPARTMENT OF PUBLIC WORKS AND ENVIRONMENTAL SERVICES			
12000 GOVERNMENT CENTER PARKWAY, SUITE 449 FAIRFAX, VA., 22035-0052			
OFFICE OF CAPITAL FACILITIES		703-324-5800	
WIEHLE AVENUE (RTE 828) AT W&OD TRAIL		MSE WALL LAYOUT	
2 OF 2		PROJECT NO: 1400102-2013	
PLAN NO.	DESIGNED: JRM	SHEET	
XXX-XX	DRAFTED: CRR	6(25)	
CHECKED: TAB		FUND # 500-C5000	

WHITMAN REQUARDT & ASSOCIATES  
RICHMOND, VA  
STRUCTURAL ENGINEER

Δ#	DESCRIPTION	BY	APPROVED	DATE


APPROVED BY THE TRANSPORTATION DESIGN DIVISION

THESE PLANS ARE UNFINISHED AND UNAPPROVED AND ARE NOT TO BE USED FOR ANY TYPE OF CONSTRUCTION.




PROJECT MANAGER: SCOTT, BUFFNER, P.E., (703) 877-5236  
SURVEYED BY, DATE: FAIRFAX COUNTY  
DESIGN BY: WHITMAN, REQUARDT & ASSOCIATES, LLP, (703) 293-9717  
SUBSURFACE UTILITY BY, DATE: SO DEEP, INC., (703) 361-6005, December 23, 2014

STATE	ROUTE	FEDERAL AID	ROUTE	STATE
		PROJECT		PROJECT
VA.	—	—	828	0828-029-248, B-601

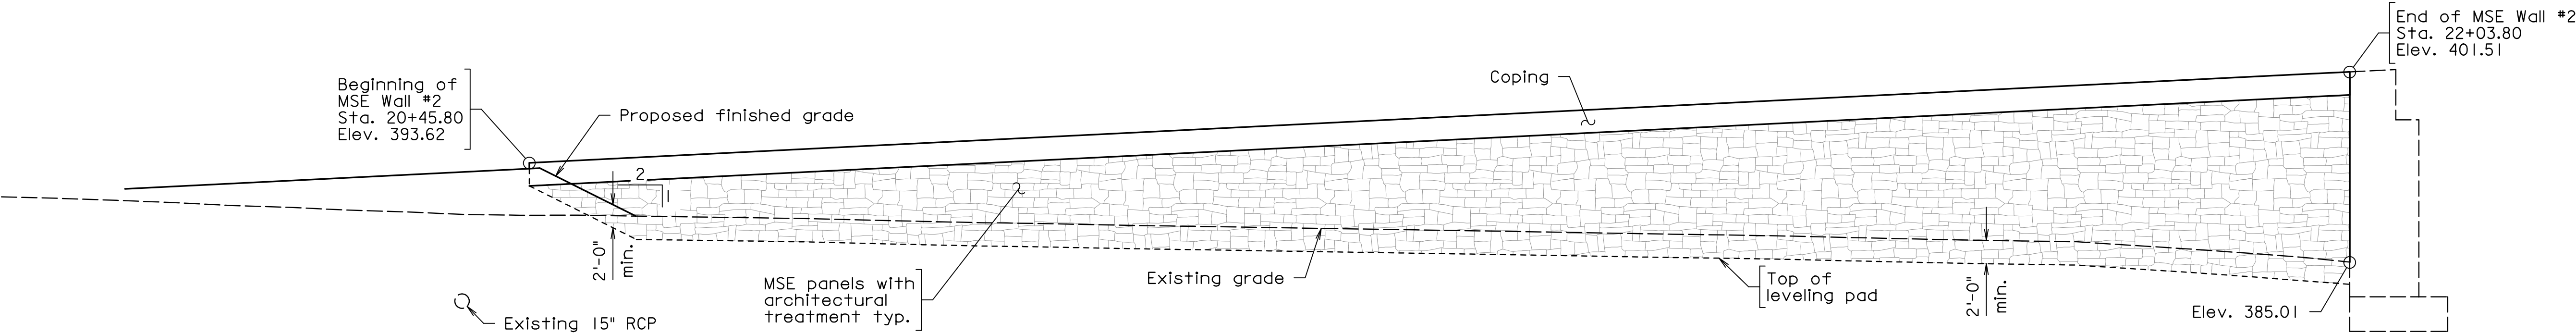

MSE WALL 2 - ELEVATION

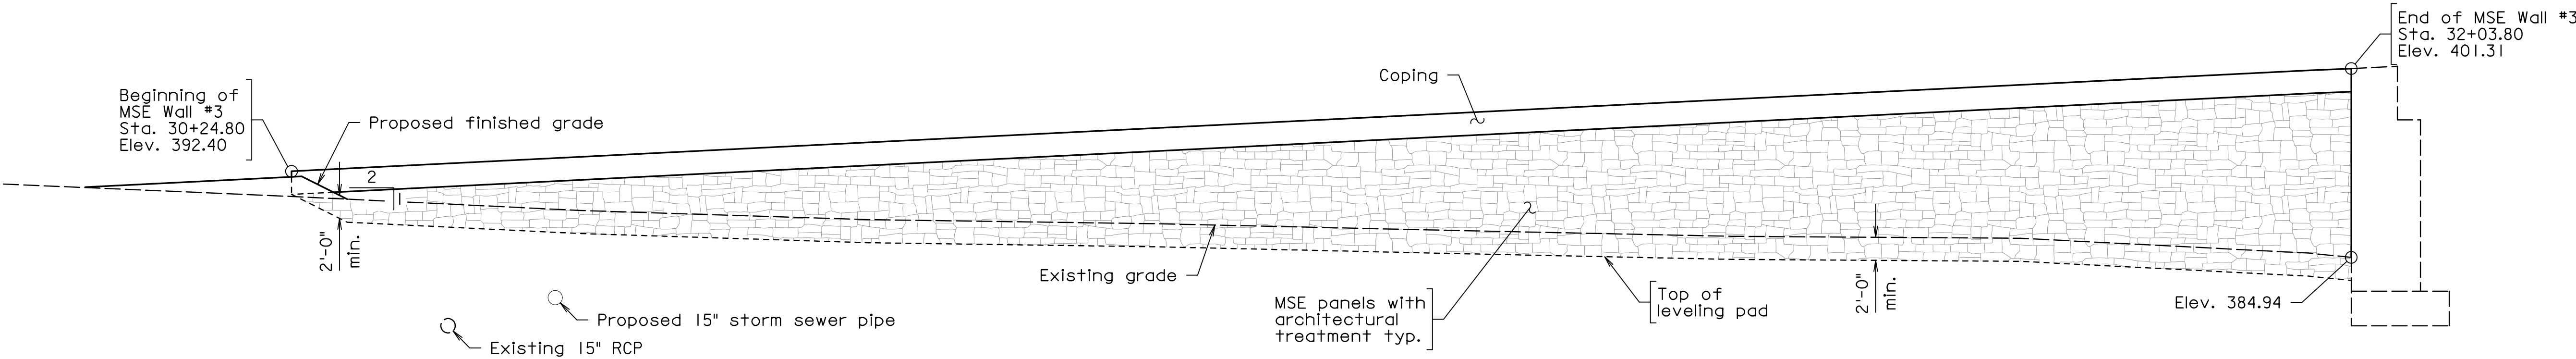

MSE WALL 3 - ELEVATION

PREFINAL PLANS

EMERGENCY POLICE - FIRE - RESCUE 911

FAIRFAX COUNTY, VIRGINIA  
DEPARTMENT OF PUBLIC WORKS AND ENVIRONMENTAL SERVICES  
12000 GOVERNMENT CENTER PARKWAY, SUITE 449 FAIRFAX, VA., 22035-0052

OFFICE OF CAPITAL FACILITIES  
703-324-5800

WIEHLE AVENUE (RTE 828) AT W&OD TRAIL  
MSE WALL ELEVATIONS  
WALLS 2 & 3

PROJECT NO: 1400102-2013

PLAN NO.	DESIGNED: JRM	SHEET
XXX-XX	DRAFTED: CRR	
CHECKED: TAB		6(26)

WHITMAN REQUARDT & ASSOCIATES  
RICHMOND, VA  
STRUCTURAL ENGINEER

Δ#	DESCRIPTION	BY	APPROVED	DATE
APPROVED BY THE TRANSPORTATION DESIGN DIVISION				

FUND # 500-C5000

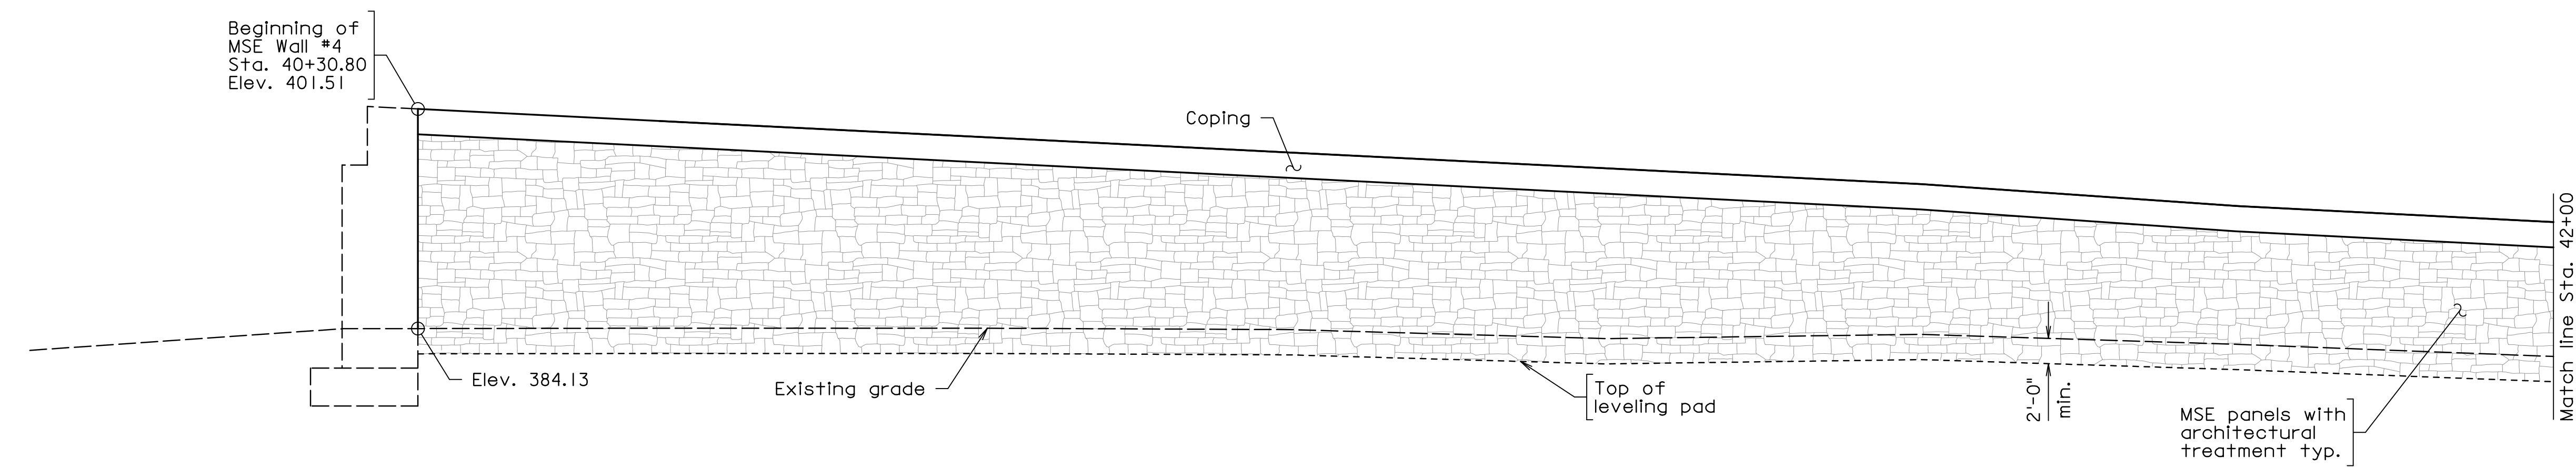
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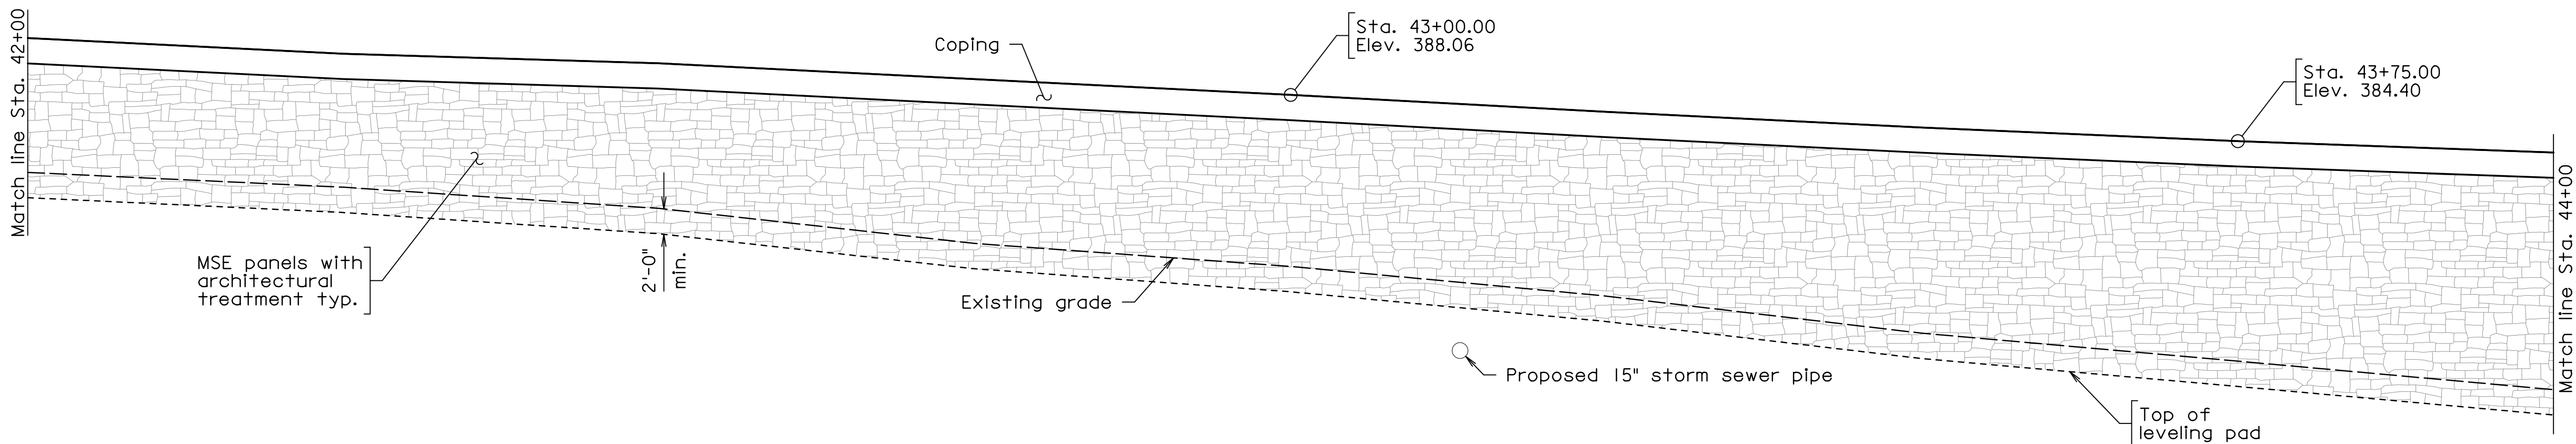


PROJECT MANAGER: SCOTT J. BUFFNER, P.E., (703) 877-5236  
SURVEYED BY, DATE: FAIRFAX COUNTY  
DESIGN BY: WHITMAN, REQUARDT & ASSOCIATES, LLP, (703) 293-9717  
SUBSURFACE UTILITY BY, DATE: SO DEEP, INC., (703) 361-6005, December 23, 2014


STATE	ROUTE	FEDERAL AID	ROUTE	STATE
		PROJECT		PROJECT
VA.	—	—	828	0828-029-248, B-601



MSE WALL 4 - ELEVATION



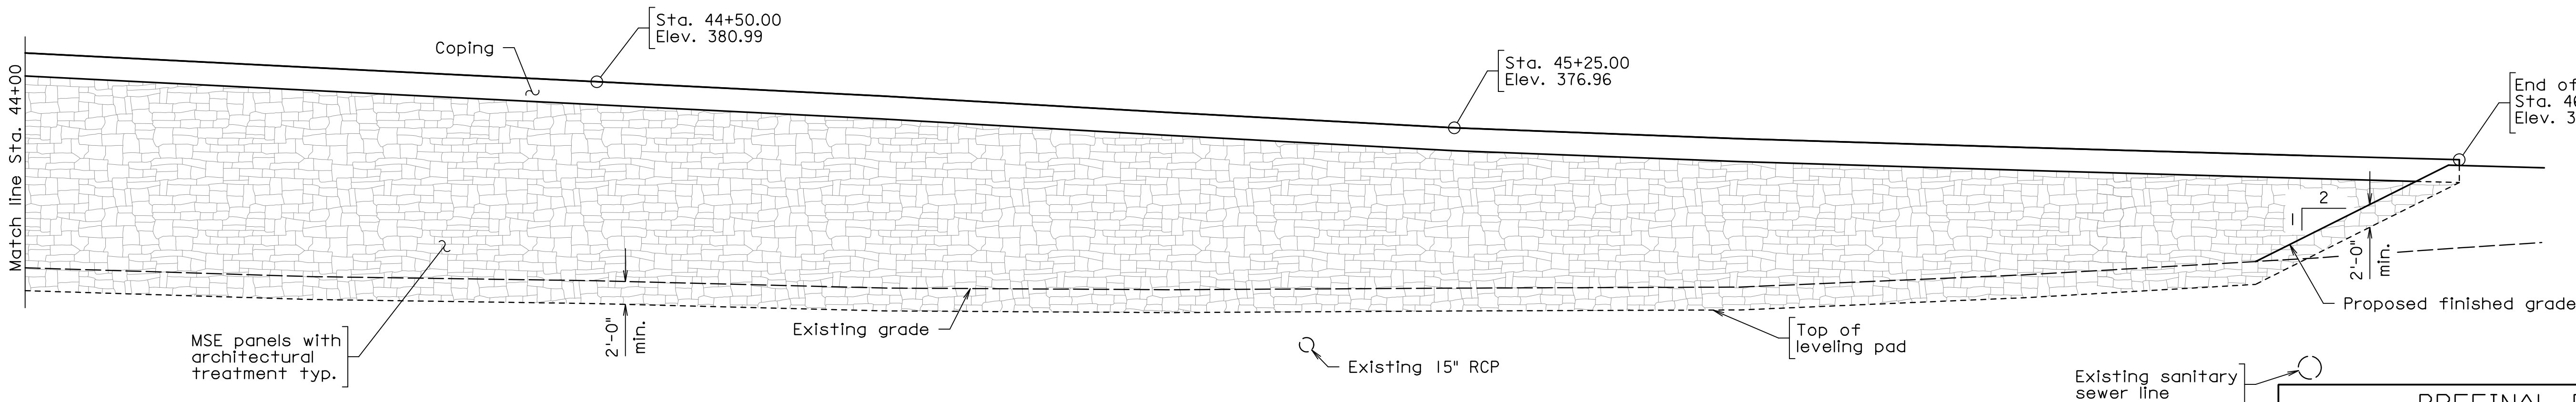MSE WALL 4 - ELEVATION



MSE WALL 4 - ELEVATION

PREFINAL PLANS

EMERGENCY POLICE - FIRE - RESCUE 911

FAIRFAX COUNTY, VIRGINIA  
DEPARTMENT OF PUBLIC WORKS AND ENVIRONMENTAL SERVICES  
12000 GOVERNMENT CENTER PARKWAY, SUITE 449 FAIRFAX, VA., 22035-0052

OFFICE OF CAPITAL FACILITIES  
703-324-5800

WIEHLE AVENUE (RTE 828) AT W&OD TRAIL  
MSE WALL ELEVATION  
WALL 4

PROJECT NO: 1400102-2013

PLAN NO. XXX-XX	DESIGNED: JRM DRAFTED: CRR CHECKED: TAB	SHEET 6(27)
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FUND # 500-C5000

WHITMAN REQUARDT & ASSOCIATES  
RICHMOND, VA  
STRUCTURAL ENGINEER


Scale: 1/8" = 1'-0"

THESE PLANS ARE UNFINISHED AND UNAPPROVED AND ARE NOT TO BE USED FOR ANY TYPE OF CONSTRUCTION.



PROJECT MANAGER: SCOTT, BUFFNER, P.E. (703) 877-5236  
SURVEYED BY, DATE: FAIRFAX COUNTY  
DESIGN BY: WHITMAN, REQUARDT & ASSOCIATES, LLP (703) 293-9717  
SUBSURFACE UTILITY BY, DATE: SO DEEP, INC. (703) 361-6005, December 23, 2014

STATE	FEDERAL AID		STATE	
	ROUTE	PROJECT	ROUTE	PROJECT
VA.	—	—	828	0828-029-248, B-601

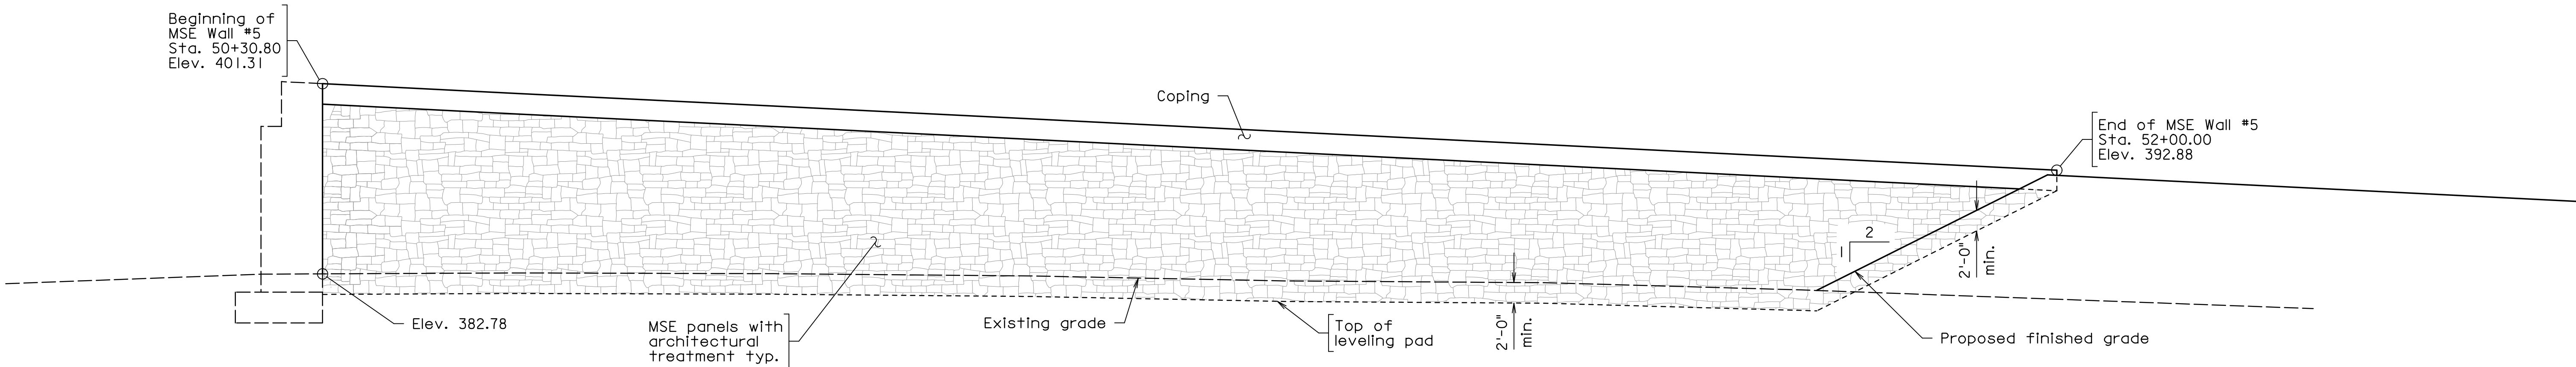

MSE WALL 5 - ELEVATION

Scale: 1/8" = 1'-0"

EMERGENCY POLICE - FIRE - RESCUE 911

FAIRFAX COUNTY, VIRGINIA

DEPARTMENT OF PUBLIC WORKS AND ENVIRONMENTAL SERVICES

12000 GOVERNMENT CENTER PARKWAY, SUITE 449 FAIRFAX, VA., 22035-0052

OFFICE OF CAPITAL FACILITIES

703-324-5800

WIEHLE AVENUE (RTE 828) AT W&OD TRAIL

MSE WALL ELEVATION

WALL 5

PROJECT NO: 1400102-2013

PLAN NO. XXX-XX

DESIGNED: JRM

DRAFTED: CRR

CHECKED: TAB

SHEET 6(28)

WHITMAN REQUARDT & ASSOCIATES

RICHMOND, VA

STRUCTURAL ENGINEER

APPROVED BY THE TRANSPORTATION DESIGN DIVISION

APPROVED

DATE

FUND # 500-C5000



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PROJECT MANAGER \_SCOTT\_BUFFNER,P.E.\_ (703) 877-5236 -----  
SURVEYED BY, DATE \_FAIRFAX COUNTY\_ -----  
DESIGN BY \_WHITMAN,REQUARDT & ASSOCIATES,LLP\_ (703) 293-9717 -----  
SUBSURFACE UTILITY BY, DATE \_SO DEEP,INC.(703) 361-6005\_ December 23, 2014 -----

STATE	FEDERAL AID		STATE	
	ROUTE	PROJECT	ROUTE	PROJECT
VA.	---	---	828	0828-029-248, B-601

Notes:  
For additional details, see Sheets 6(23) through 6(28)




PREFINAL PLANS									
EMERGENCY POLICE - FIRE - RESCUE 911									
FAIRFAX COUNTY, VIRGINIA									
DEPARTMENT OF PUBLIC WORKS AND ENVIRONMENTAL SERVICES									
12000 GOVERNMENT CENTER PARKWAY, SUITE 449 FAIRFAX, VA., 22035-0052									
R E V I S I O N S	OFFICE OF CAPITAL FACILITIES 703-324-5800								
	WIEHLE AVENUE (RTE 828) AT W&OD TRAIL MSE WALL								
	ARCHITECTURAL TREATMENT DETAILS								
	PROJECT NO: 1400102-2013								
	PLAN NO. XXX-XX		DESIGNED: JRM DRAFTED: CRR CHECKED: TAB				SHEET 6(29)		
WHITMAN REQUARDT & ASSOCIATES RICHMOND, VA STRUCTURAL ENGINEER		△#		DESCRIPTION	BY	APPROVED	DATE	APPROVED BY THE TRANSPORTATION DESIGN DIVISION	
FUND # 500-C5000									

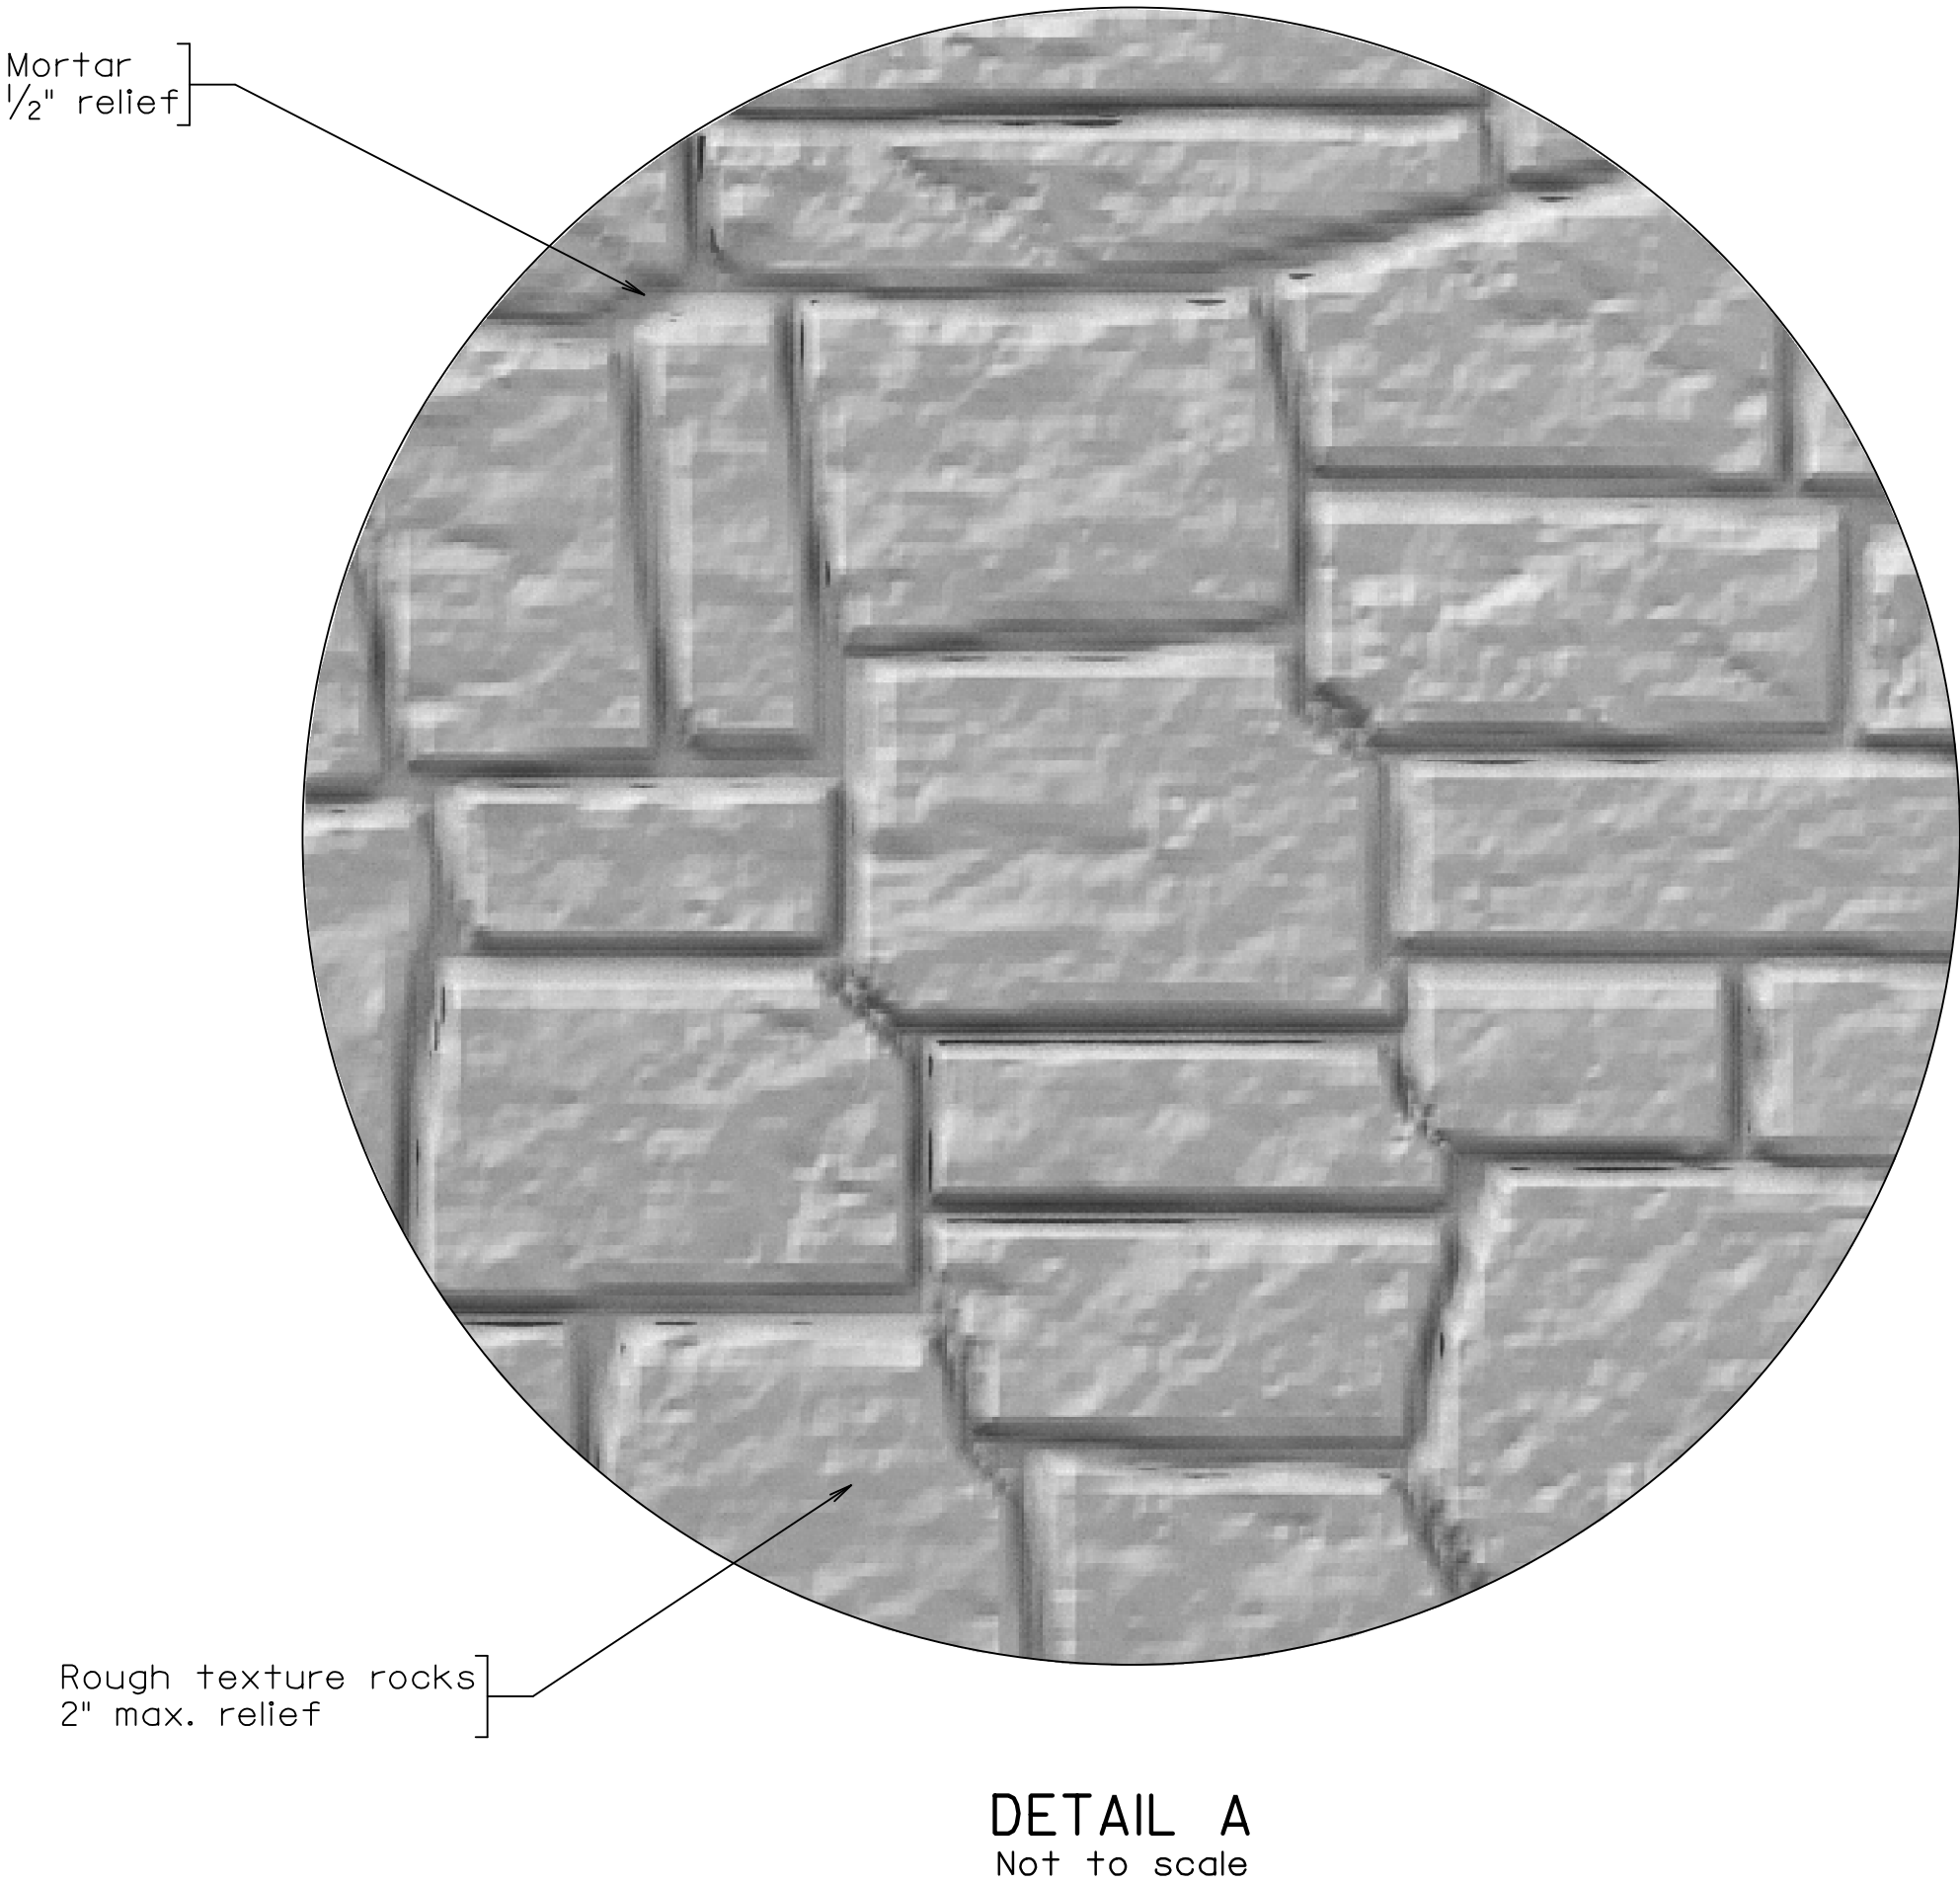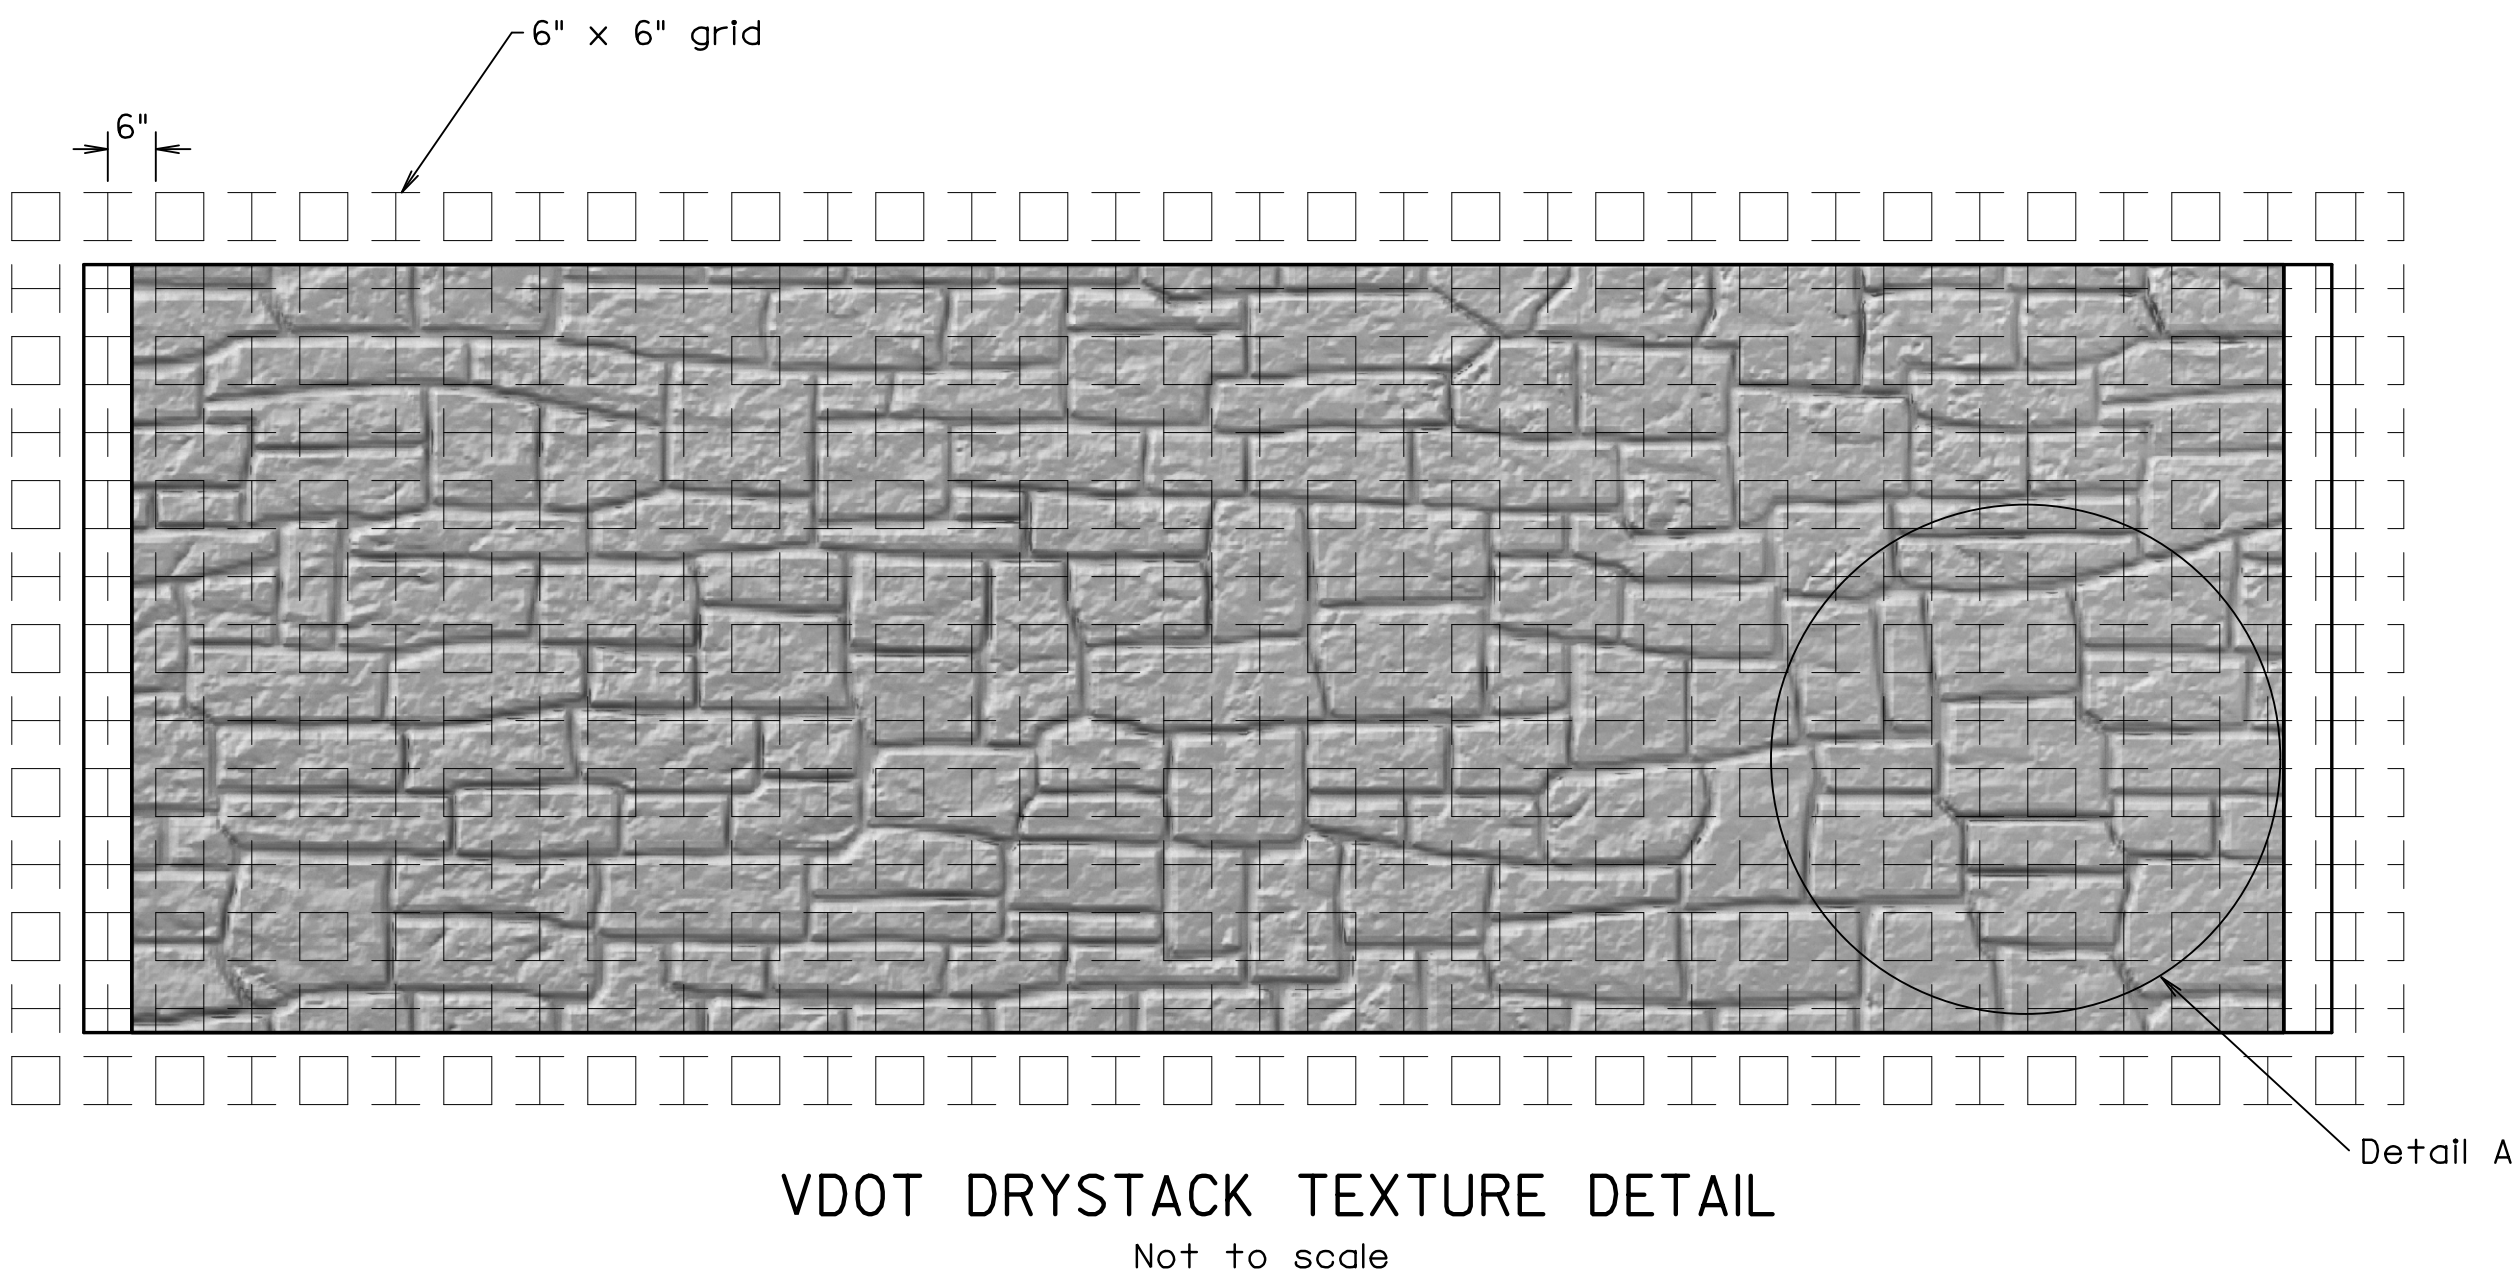THESE PLANS ARE UNFINISHED AND UNAPPROVED AND ARE NOT TO BE USED FOR ANY TYPE OF CONSTRUCTION.



PROJECT MANAGER: SCOTT BUFFNER, P.E. (703) 877-5736  
SURVEYED BY, DATE: FAIRFAX COUNTY, NOVEMBER 28, 2014  
DESIGN BY: WHITMAN, REQUARDT & ASSOCIATES, LLP (703) 293-9772  
SUBSURFACE UTILITY BY, DATE: SQ DEEP, INC. (703) 361-6005, DECEMBER 23, 2014

# SIGNING & PAVEMENT MARKING PLAN

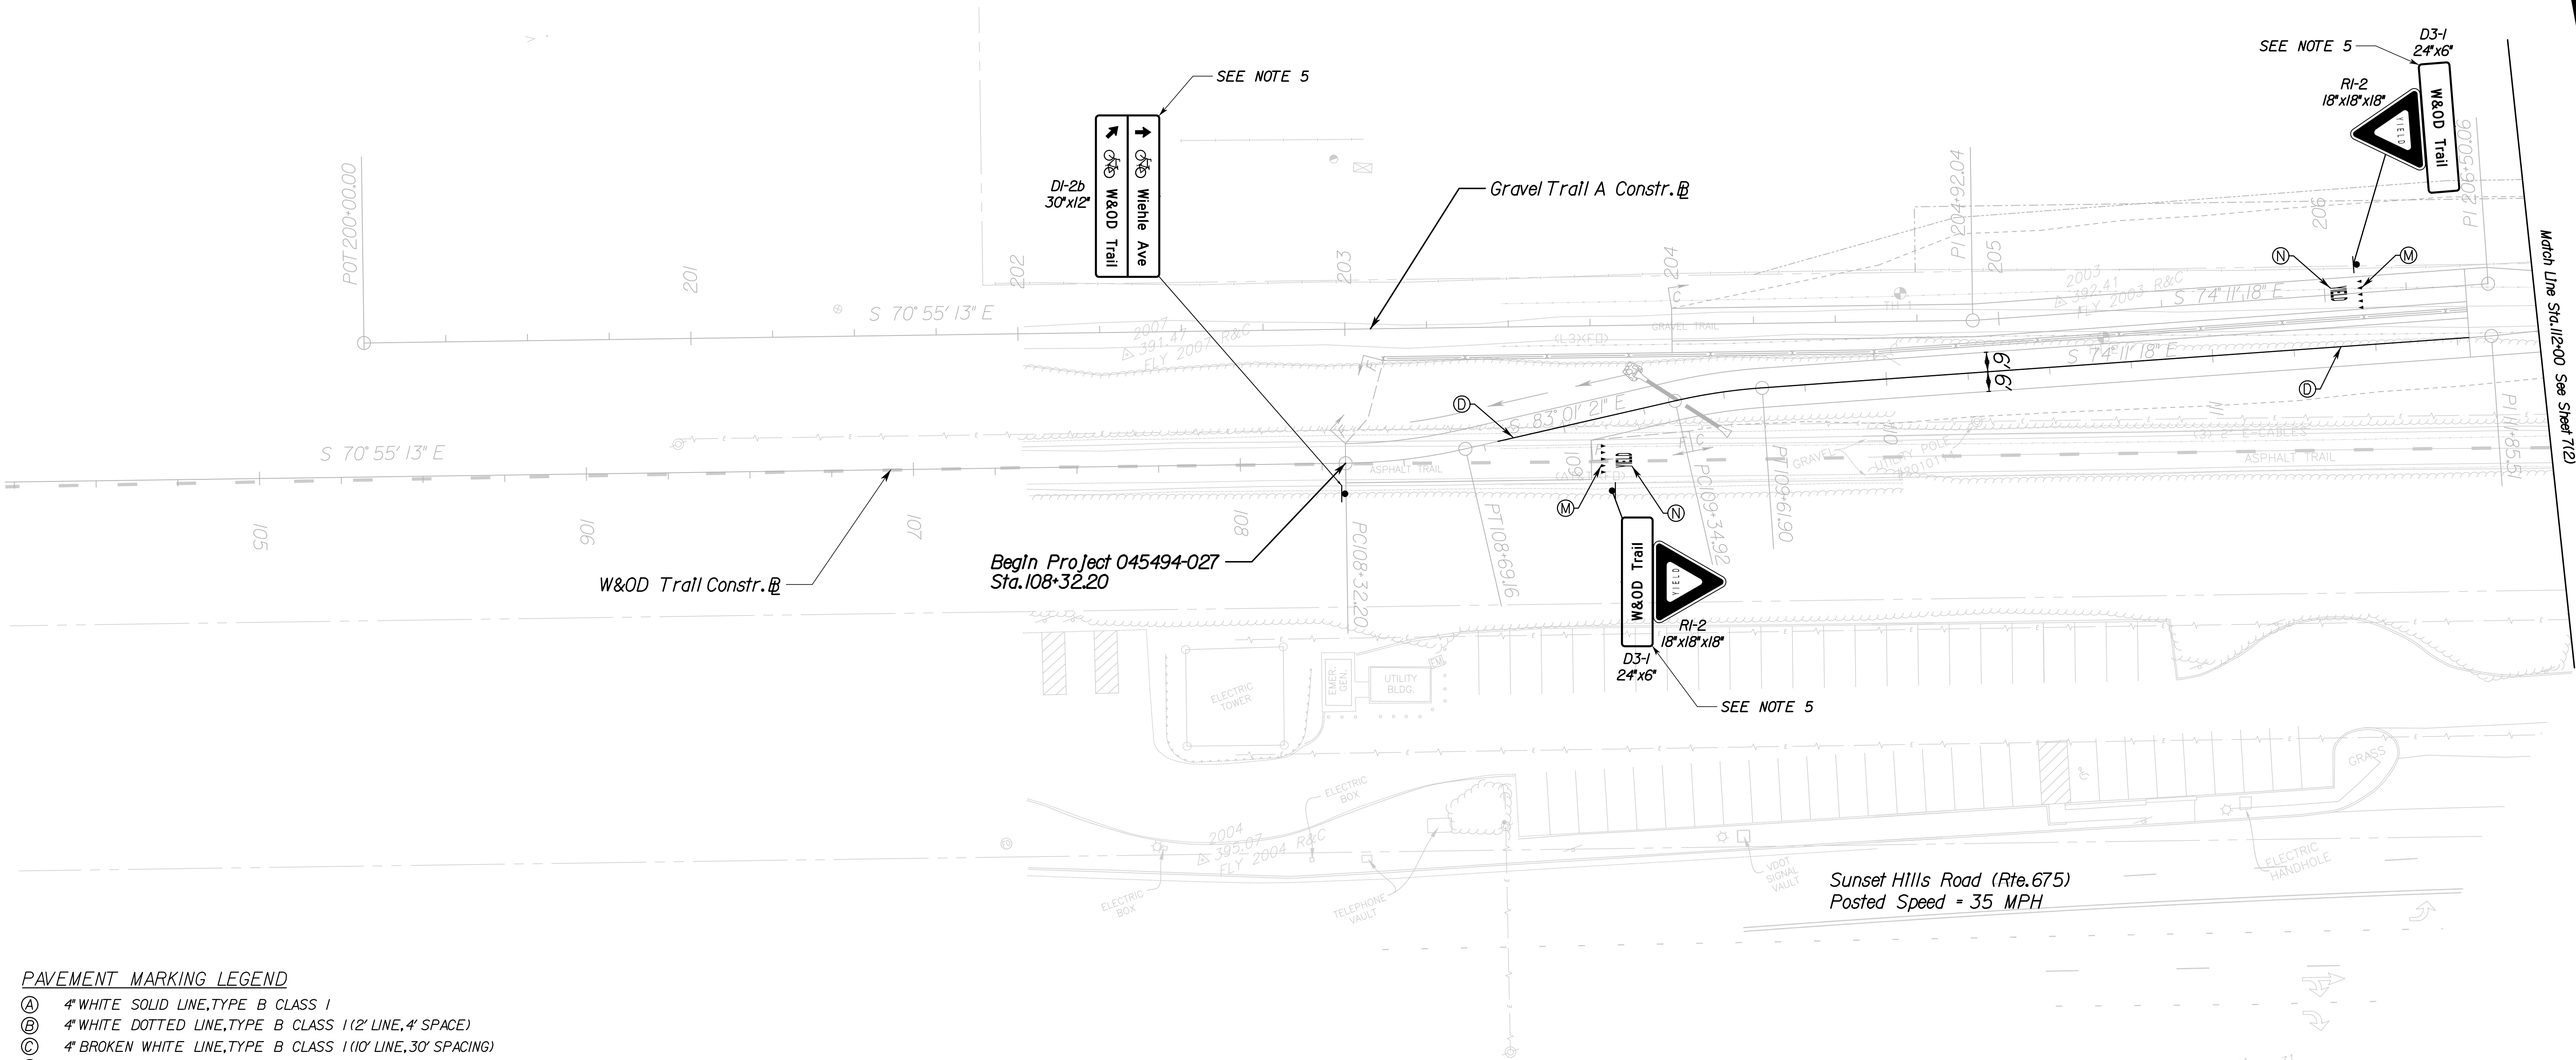

## PAVEMENT MARKING LEGEND

- A 4" WHITE SOLID LINE, TYPE B CLASS I
- B 4" WHITE DOTTED LINE, TYPE B CLASS I (2' LINE, 4' SPACE)
- C 4" BROKEN WHITE LINE, TYPE B CLASS I (10' LINE, 30' SPACING)
- D 4" YELLOW LINE, TYPE B CLASS I
- E 24" WHITE SOLID LINE, TYPE B CLASS I
- F 6" WHITE SOLID LINE, TYPE B CLASS I
- G 4" BROKEN YELLOW LINE, TYPE B CLASS I (3' LINE, 9' SPACING)
- H 24" YELLOW SOLID LINE, TYPE B CLASS I (20' SPACING AT 45 DEGREES)
- I PAVEMENT MESSAGE MARKING ELONGATED ARROW SINGLE
- J 8" WHITE SOLID LINE, TYPE B CLASS I (5' SPACING)
- K ERADICATE EXISTING PAVEMENT MARKINGS
- L 24" WHITE SOLID LINE, TYPE B CLASS I (10' LINE, SPACING 2'-5')
- M 18" WHITE YIELD LINE, TYPE B CLASS I
- N PAVEMENT MESSAGE MARKING "YIELD", TYPE B CLASS I

## NOTES:

- 1) ALL PROPOSED SIGNING AND PAVEMENT MARKINGS SHALL BE IN ACCORDANCE WITH THE MOST CURRENT EDITION OF EACH OF THE FOLLOWING MANUALS, OR THE MOST RECENT REVISION THERETO:  
A. MANUAL ON UNIFORM TRAFFIC CONTROL DEVICES.  
B. THE VIRGINIA SUPPLEMENT TO THE MANUAL ON UNIFORM TRAFFIC CONTROL DEVICES.  
C. THE VIRGINIA DEPARTMENT OF TRANSPORTATION ROAD AND BRIDGE SPECIFICATIONS.  
D. THE VIRGINIA DEPARTMENT OF TRANSPORTATION ROAD AND BRIDGE STANDARDS.
- 2) EXISTING SIGNS WITHIN THE LIMITS OF THE CONTRACT WHICH HAVE NOT BEEN ACCOUNTED FOR IN THE PLAN SHALL BE RELOCATED OR REMOVED AS DIRECTED BY THE ENGINEER.
- 3) ALL COMPONENTS OF AN EXISTING SIGN INSTALLATION WHICH ARE REMOVED SHALL BE PROPERLY DISPOSED OF BY THE CONTRACTOR AT AN OFF-SITE LOCATION.
- 4) ALL SIGNS TO BE PLACED ON A STP-1-2 IN.14 GA. POST UNLESS OTHERWISE NOTED.
- 5) SEE SHEET 7(4) FOR SIGN PANEL DETAILS.



Whitman Requardt & Associates  
Richmond, Virginia  
TRAFFIC ENGINEER

EMERGENCY POLICE - FIRE - RESCUE 911				
FAIRFAX COUNTY, VIRGINIA				
DEPARTMENT OF PUBLIC WORKS AND ENVIRONMENTAL SERVICES				
12000 GOVERNMENT CENTER PARKWAY, SUITE 449 FAIRFAX, VA., 22035-0052				
OFFICE OF CAPITAL FACILITIES 703-324-5800			WIEHLE AVENUE (RTE 828) AT W&OD TRAIL SIGNING AND PAVEMENT MARKING PLAN PROJECT NO: 1400102-2013	
SCALE 1"=25'		DESIGNED: NDD DRAFTED: WRA CHECKED: RBH		SHEET 7(1)
APPROVED BY THE TRANSPORTATION DESIGN DIVISION				



Whitman, Requardt & Associates, LLP

FUND # 500-C5000

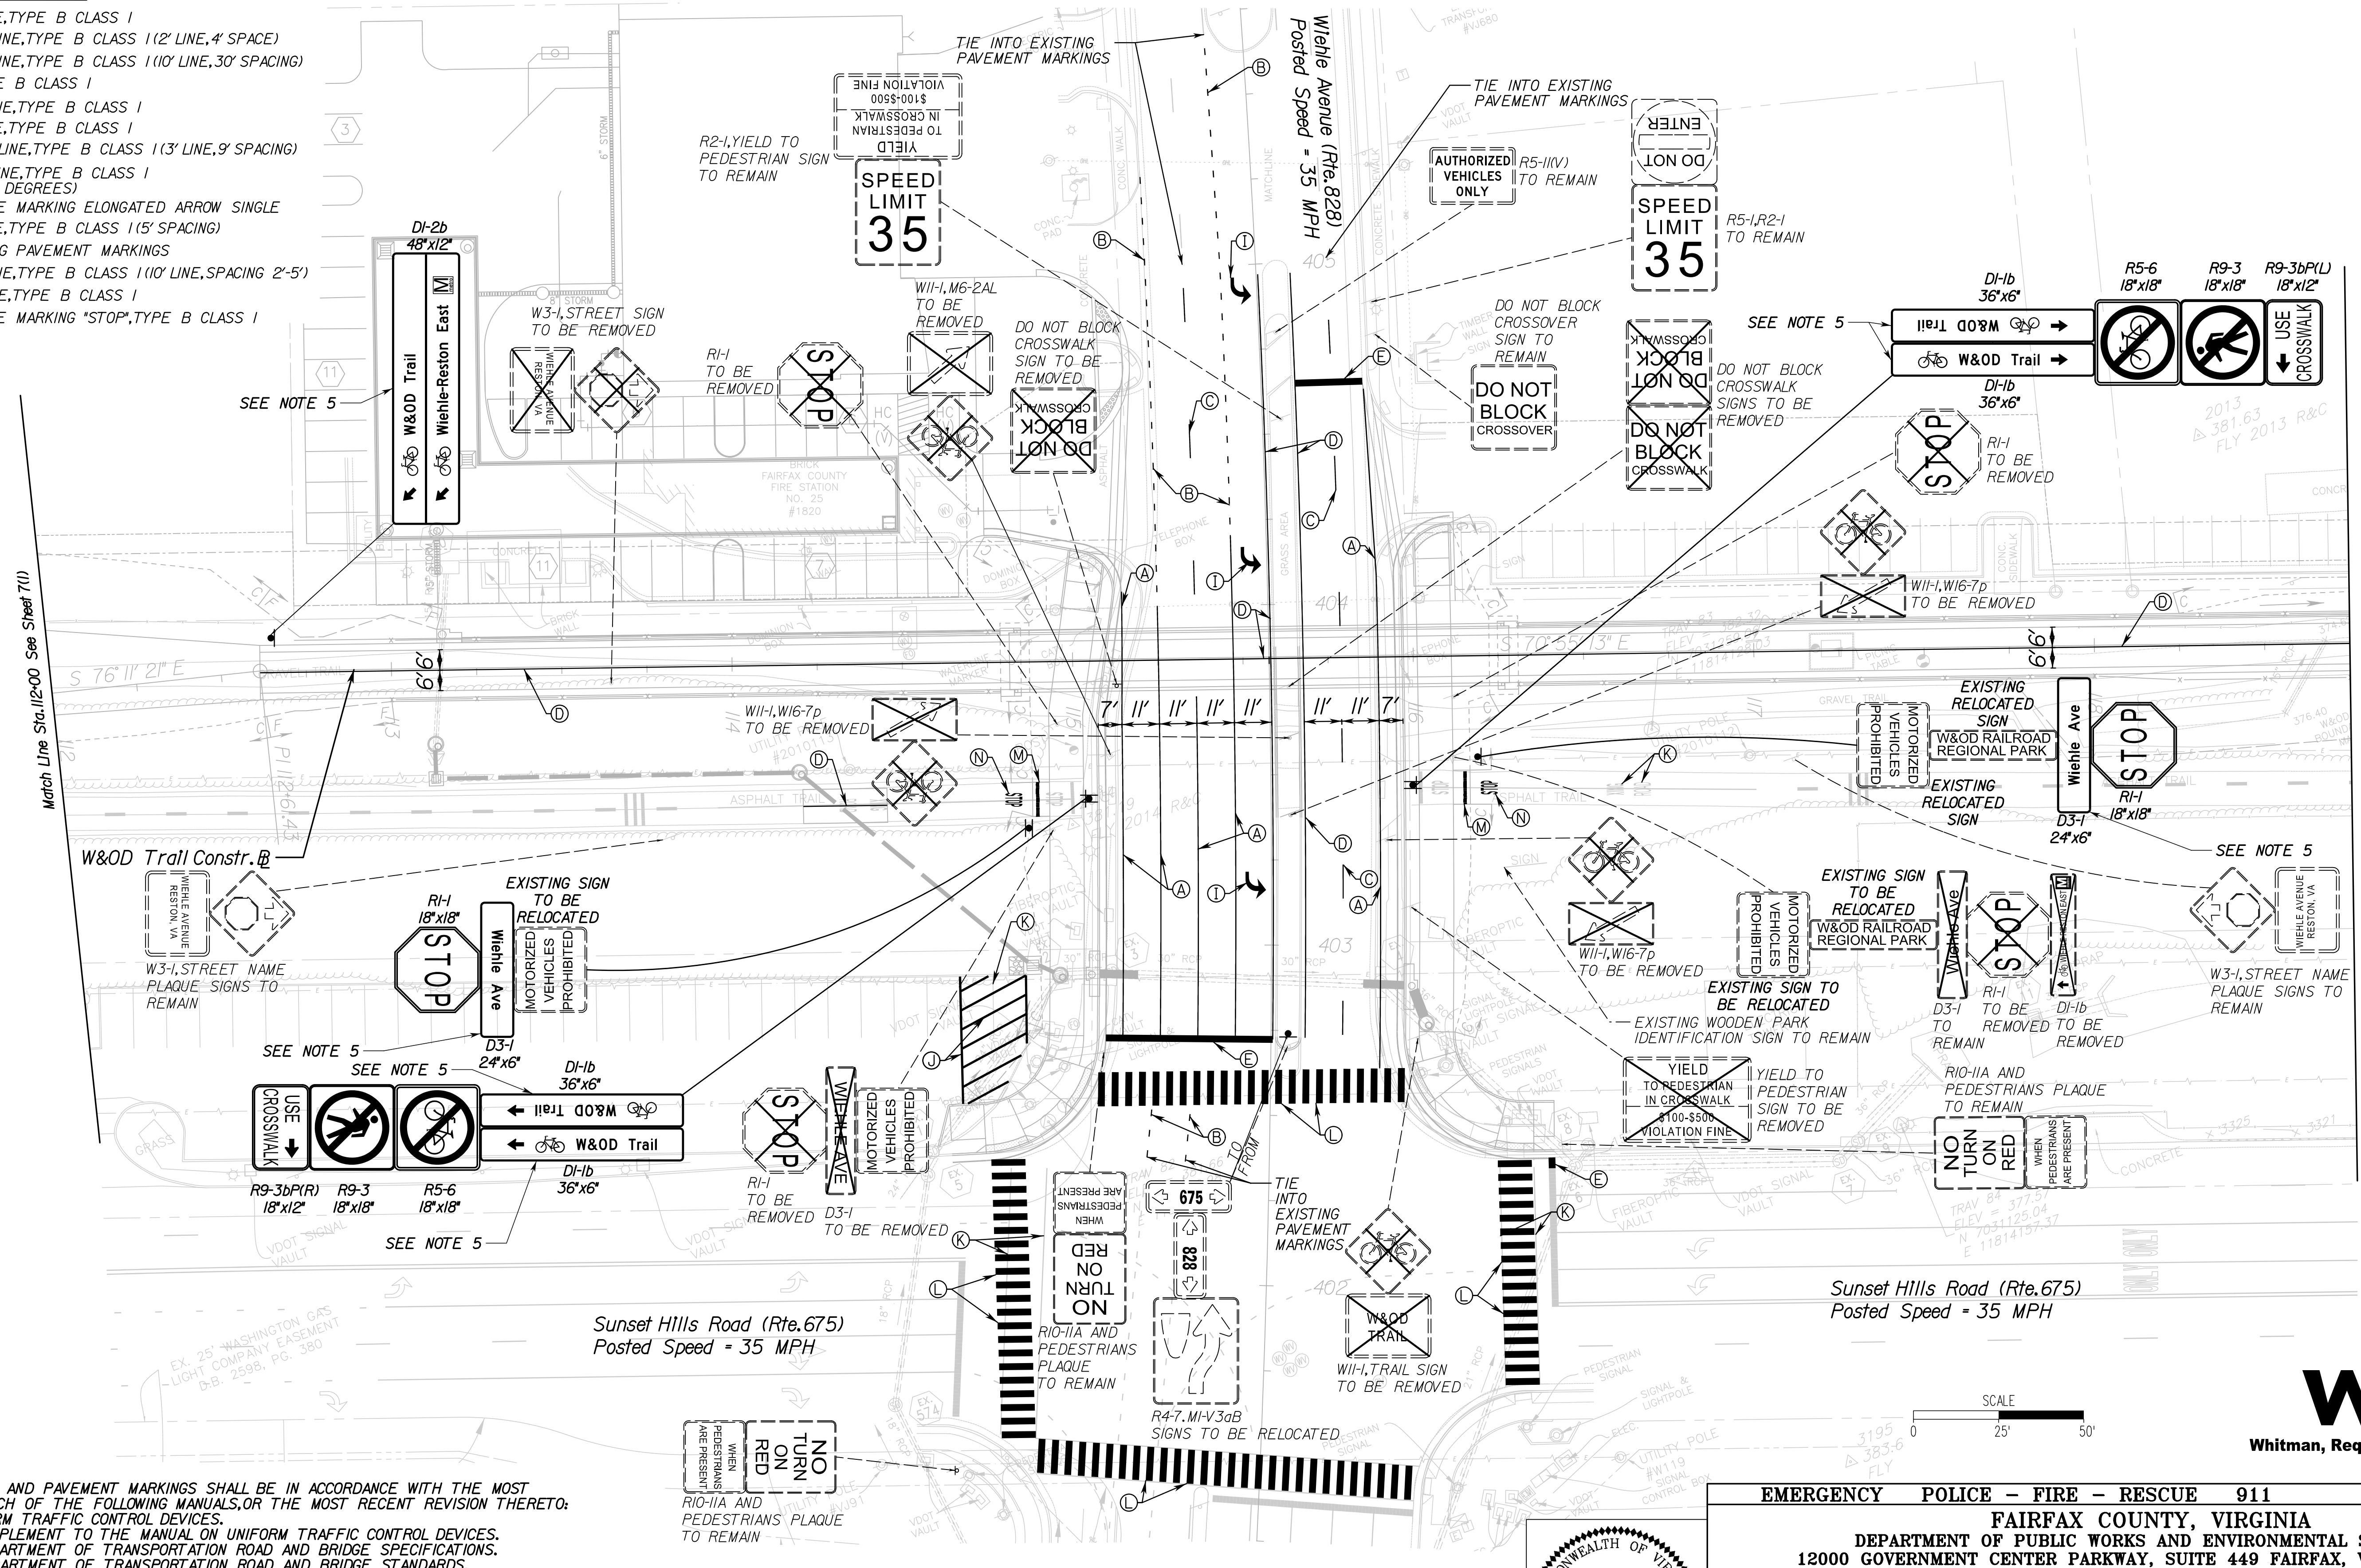


PROJECT MANAGER: SCOTT BUFFNER, P.E. (703) 877-5736  
SURVEYED BY: DATE: FAIRFAX COUNTY, NOVEMBER 28, 2014  
DESIGN BY: WHITMAN, REQUARDT & ASSOCIATES, LLP (703) 293-9707  
SUBSURFACE UTILITY BY: DATE: SO DEEP, INC. (703) 361-6005, DECEMBER 23, 2014

# SIGNING & PAVEMENT MARKING PLAN


## PAVEMENT MARKING LEGEND

- (A) 4" WHITE SOLID LINE, TYPE B CLASS I  
(B) 4" WHITE DOTTED LINE, TYPE B CLASS I (2" LINE, 4" SPACE)  
(C) 4" BROKEN WHITE LINE, TYPE B CLASS I (10' LINE, 30' SPACING)  
(D) 4" YELLOW LINE, TYPE B CLASS I  
(E) 24" WHITE SOLID LINE, TYPE B CLASS I  
(F) 6" WHITE SOLID LINE, TYPE B CLASS I  
(G) 4" BROKEN YELLOW LINE, TYPE B CLASS I (3' LINE, 9' SPACING)  
(H) 24" YELLOW SOLID LINE, TYPE B CLASS I (20' SPACING AT 45 DEGREES)  
(I) PAVEMENT MESSAGE MARKING ELONGATED ARROW SINGLE  
(J) 8" WHITE SOLID LINE, TYPE B CLASS I (5' SPACING)  
(K) ERADICATE EXISTING PAVEMENT MARKINGS  
(L) 24" WHITE SOLID LINE, TYPE B CLASS I (10' LINE, SPACING 2'-5")  
(M) 18" WHITE SOLID LINE, TYPE B CLASS I  
(N) PAVEMENT MESSAGE MARKING "STOP", TYPE B CLASS I



## NOTES:

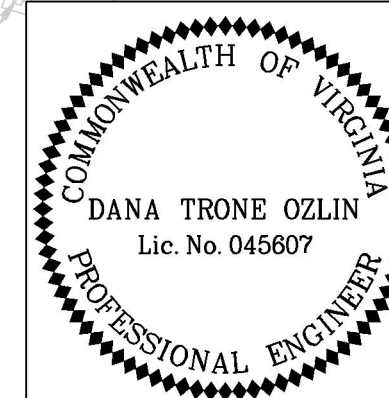- 1) ALL PROPOSED SIGNING AND PAVEMENT MARKINGS SHALL BE IN ACCORDANCE WITH THE MOST CURRENT EDITION OF EACH OF THE FOLLOWING MANUALS, OR THE MOST RECENT REVISION THEREOF:  
A. MANUAL ON UNIFORM TRAFFIC CONTROL DEVICES.  
B. THE VIRGINIA SUPPLEMENT TO THE MANUAL ON UNIFORM TRAFFIC CONTROL DEVICES.  
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- 4) ALL SIGNS TO BE PLACED ON A STP-1-2 IN.14 GA. POST UNLESS OTHERWISE NOTED.
- 5) SEE SHEET 7(4) FOR SIGN PANEL DETAILS.
- 6) ONE PARKING SPACE SHALL BE ERADICATED FROM VDOT PARK AND RIDE LOT AT STA 114+65 AS SHOWN ON THE PAVEMENT MARKING PLAN.



Whitman Requardt & Associates  
Richmond, Virginia  
TRAFFIC ENGINEER


EMERGENCY POLICE - FIRE - RESCUE 911			
FAIRFAX COUNTY, VIRGINIA			
DEPARTMENT OF PUBLIC WORKS AND ENVIRONMENTAL SERVICES			
12000 GOVERNMENT CENTER PARKWAY, SUITE 449 FAIRFAX, VA., 22035-0052			
OFFICE OF CAPITAL FACILITIES 703-324-5800			
WIEHLE AVENUE (RTE 828) AT W&OD TRAIL SIGNING AND PAVEMENT MARKING PLAN PROJECT NO: 1400102-2013			
SCALE 1"=25'	DESIGNED: NDD CHECKED: RBH	SHEET 7(2)	
FUND # 500-C5000			

#	DESCRIPTION	BY	APPROVED	DATE
APPROVED BY THE TRANSPORTATION DESIGN DIVISION				




PROJECT MANAGER: SCOTT BUFFNER, P.E. (703) 877-5736  
SURVEYED BY, DATE: FAIRFAX COUNTY, NOVEMBER 28, 2014  
DESIGN BY: WHITMAN, REQUARDT & ASSOCIATES, LLP (703) 293-9717  
SUBSURFACE UTILITY BY, DATE: SO DEEP, INC. (703) 361-6005, DECEMBER 23, 2014
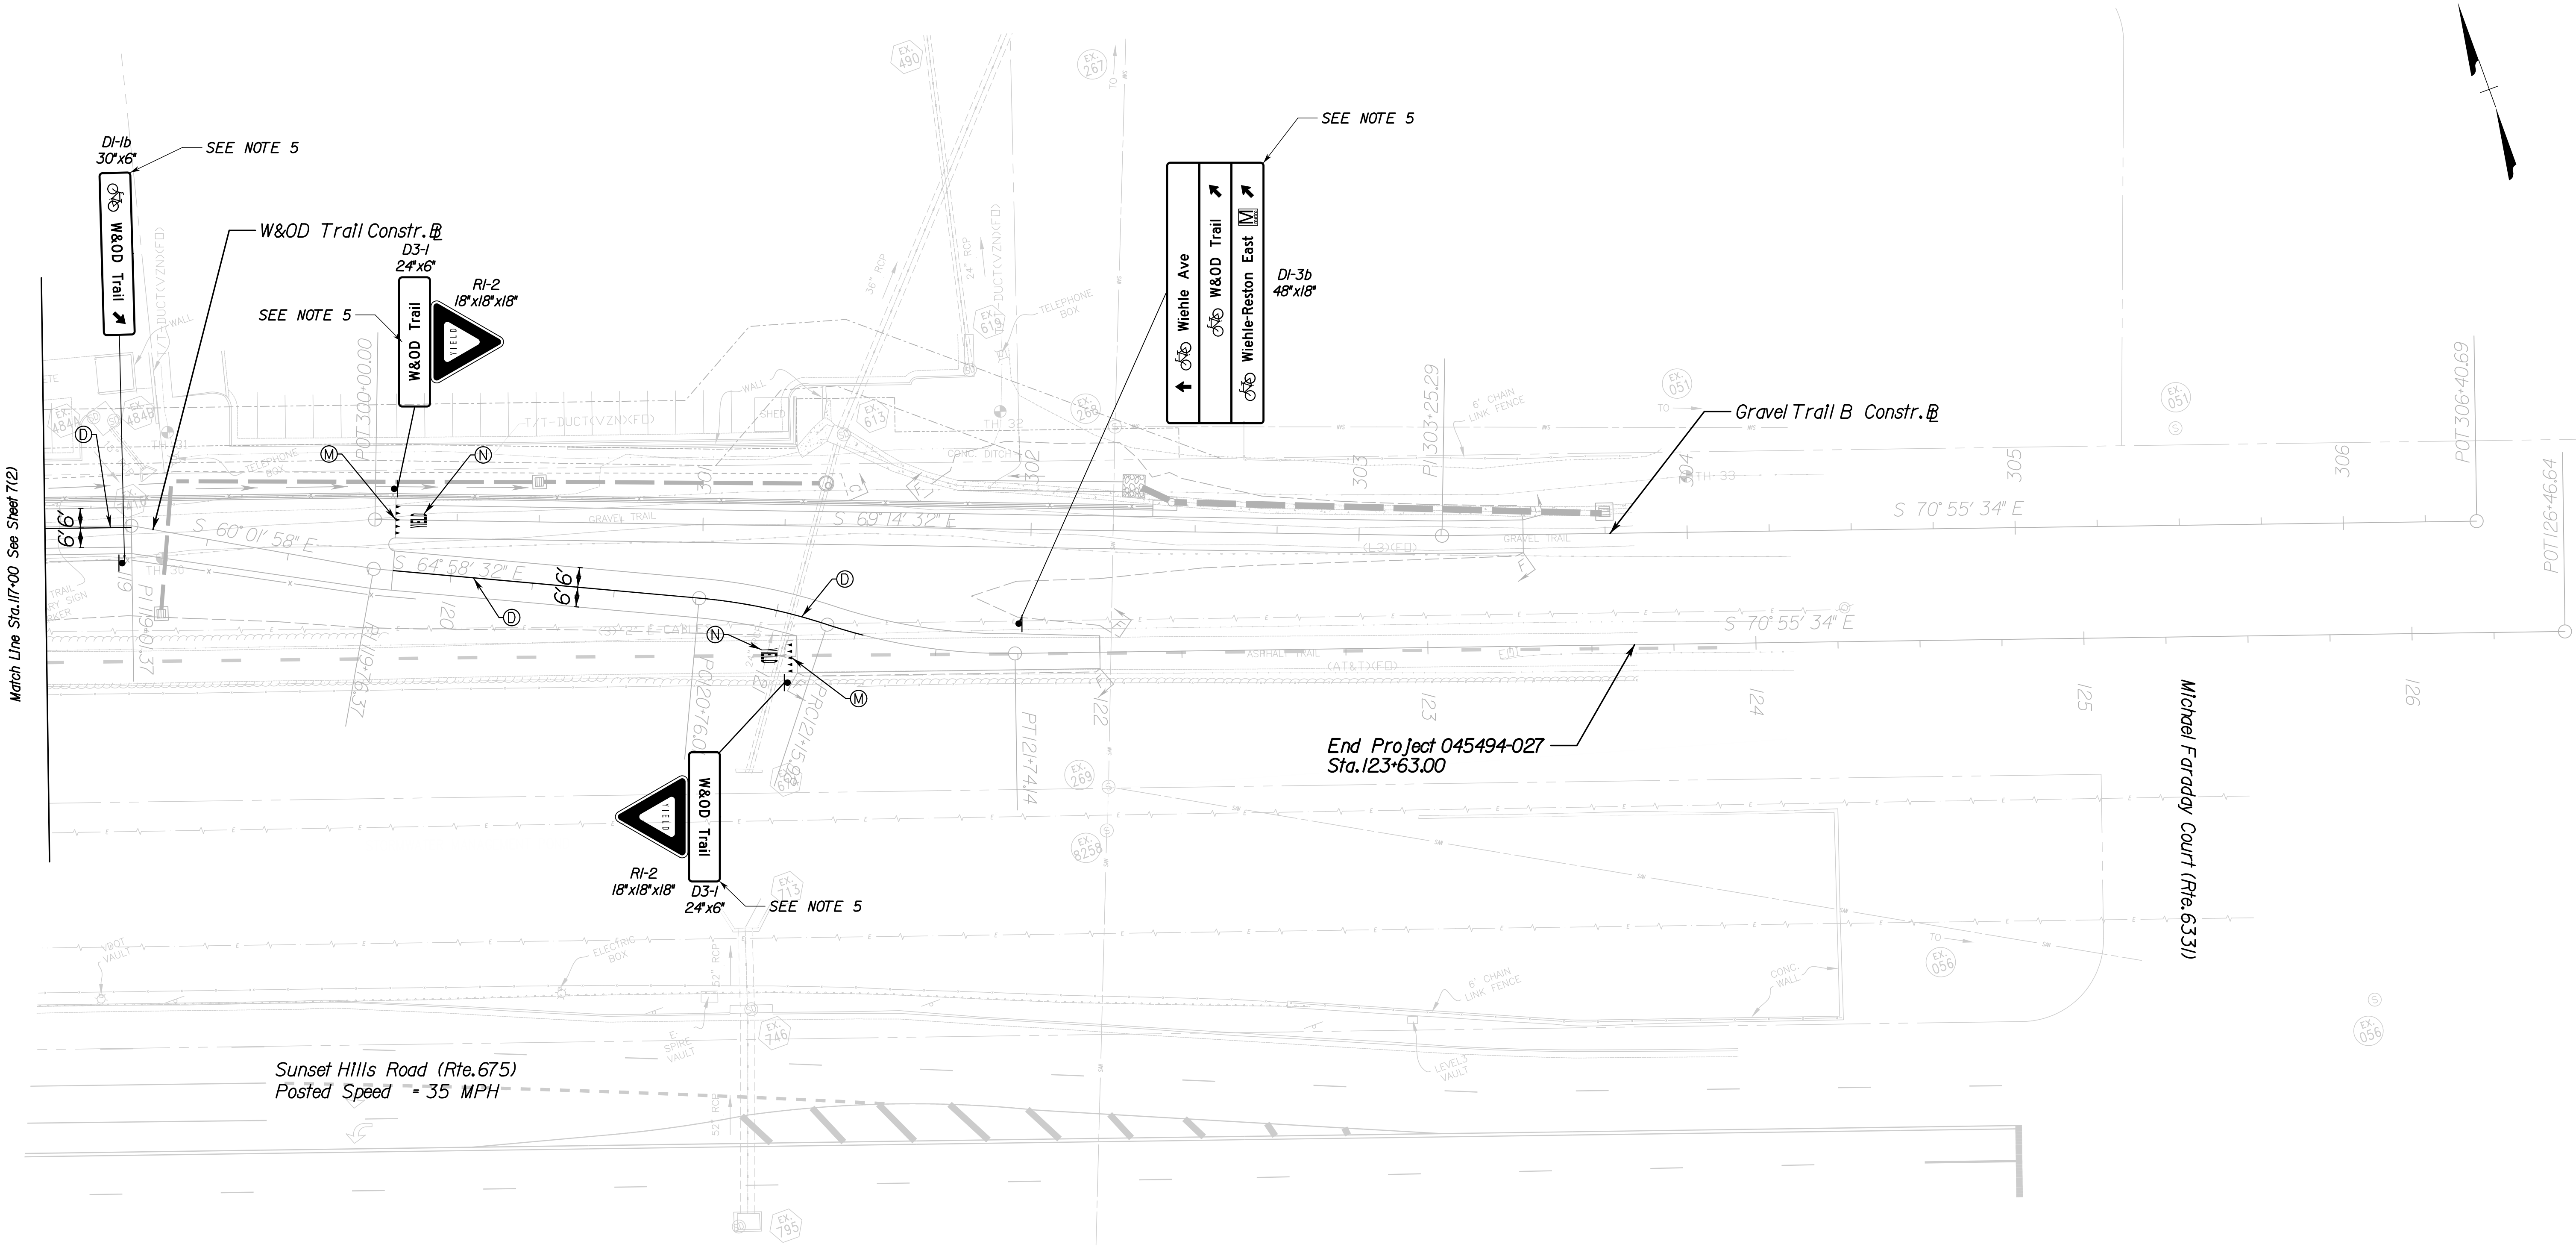
# SIGNING & PAVEMENT MARKING PLAN




Match Line Sta. 117+00 See Sheet 7(2)

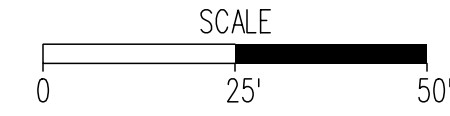End Project 045494-027  
Sta. 123+63.00



- NOTES:**
- 1.) ALL PROPOSED SIGNING AND PAVEMENT MARKINGS SHALL BE IN ACCORDANCE WITH THE MOST CURRENT EDITION OF EACH OF THE FOLLOWING MANUALS, OR THE MOST RECENT REVISION THEREOF:  
A. MANUAL ON UNIFORM TRAFFIC CONTROL DEVICES.  
B. THE VIRGINIA SUPPLEMENT TO THE MANUAL ON UNIFORM TRAFFIC CONTROL DEVICES.  
C. THE VIRGINIA DEPARTMENT OF TRANSPORTATION ROAD AND BRIDGE SPECIFICATIONS.  
D. THE VIRGINIA DEPARTMENT OF TRANSPORTATION ROAD AND BRIDGE STANDARDS.
  - 2.) EXISTING SIGNS WITHIN THE LIMITS OF THE CONTRACT WHICH HAVE NOT BEEN ACCOUNTED FOR IN THE PLAN SHALL BE RELOCATED OR REMOVED AS DIRECTED BY THE ENGINEER.
  - 3.) ALL COMPONENTS OF AN EXISTING SIGN INSTALLATION WHICH ARE REMOVED SHALL BE PROPERLY DISPOSED OF BY THE CONTRACTOR AT AN OFF-SITE LOCATION.
  - 4.) ALL SIGNS TO BE PLACED ON A STP-1-2 IN.14 GA. POST UNLESS OTHERWISE NOTED.
  - 5.) SEE SHEET 7(4) FOR SIGN PANEL DETAILS.

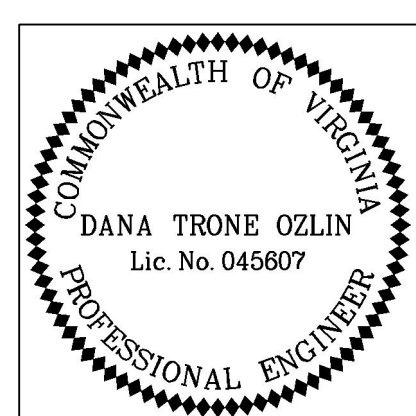- PAVEMENT MARKING LEGEND**
- (A) 4" WHITE SOLID LINE, TYPE B CLASS I
  - (B) 4" WHITE DOTTED LINE, TYPE B CLASS I (2' LINE, 4' SPACE)
  - (C) 4" BROKEN WHITE LINE, TYPE B CLASS I (10' LINE, 30' SPACING)
  - (D) 4" YELLOW LINE, TYPE B CLASS I
  - (E) 24" WHITE SOLID LINE, TYPE B CLASS I
  - (F) 6" WHITE SOLID LINE, TYPE B CLASS I
  - (G) 4" BROKEN YELLOW LINE, TYPE B CLASS I (3' LINE, 9' SPACING)
  - (H) 24" YELLOW SOLID LINE, TYPE B CLASS I (20' SPACING AT 45 DEGREES)
  - (I) PAVEMENT MESSAGE MARKING ELONGATED ARROW SINGLE
  - (J) 8" WHITE SOLID LINE, TYPE B CLASS I (15' SPACING)
  - (K) ERADICATE EXISTING PAVEMENT MARKINGS
  - (L) 24" WHITE SOLID LINE, TYPE B CLASS I (10' LINE, SPACING 2'-5')
  - (M) 18" WHITE YIELD LINE, TYPE B CLASS I
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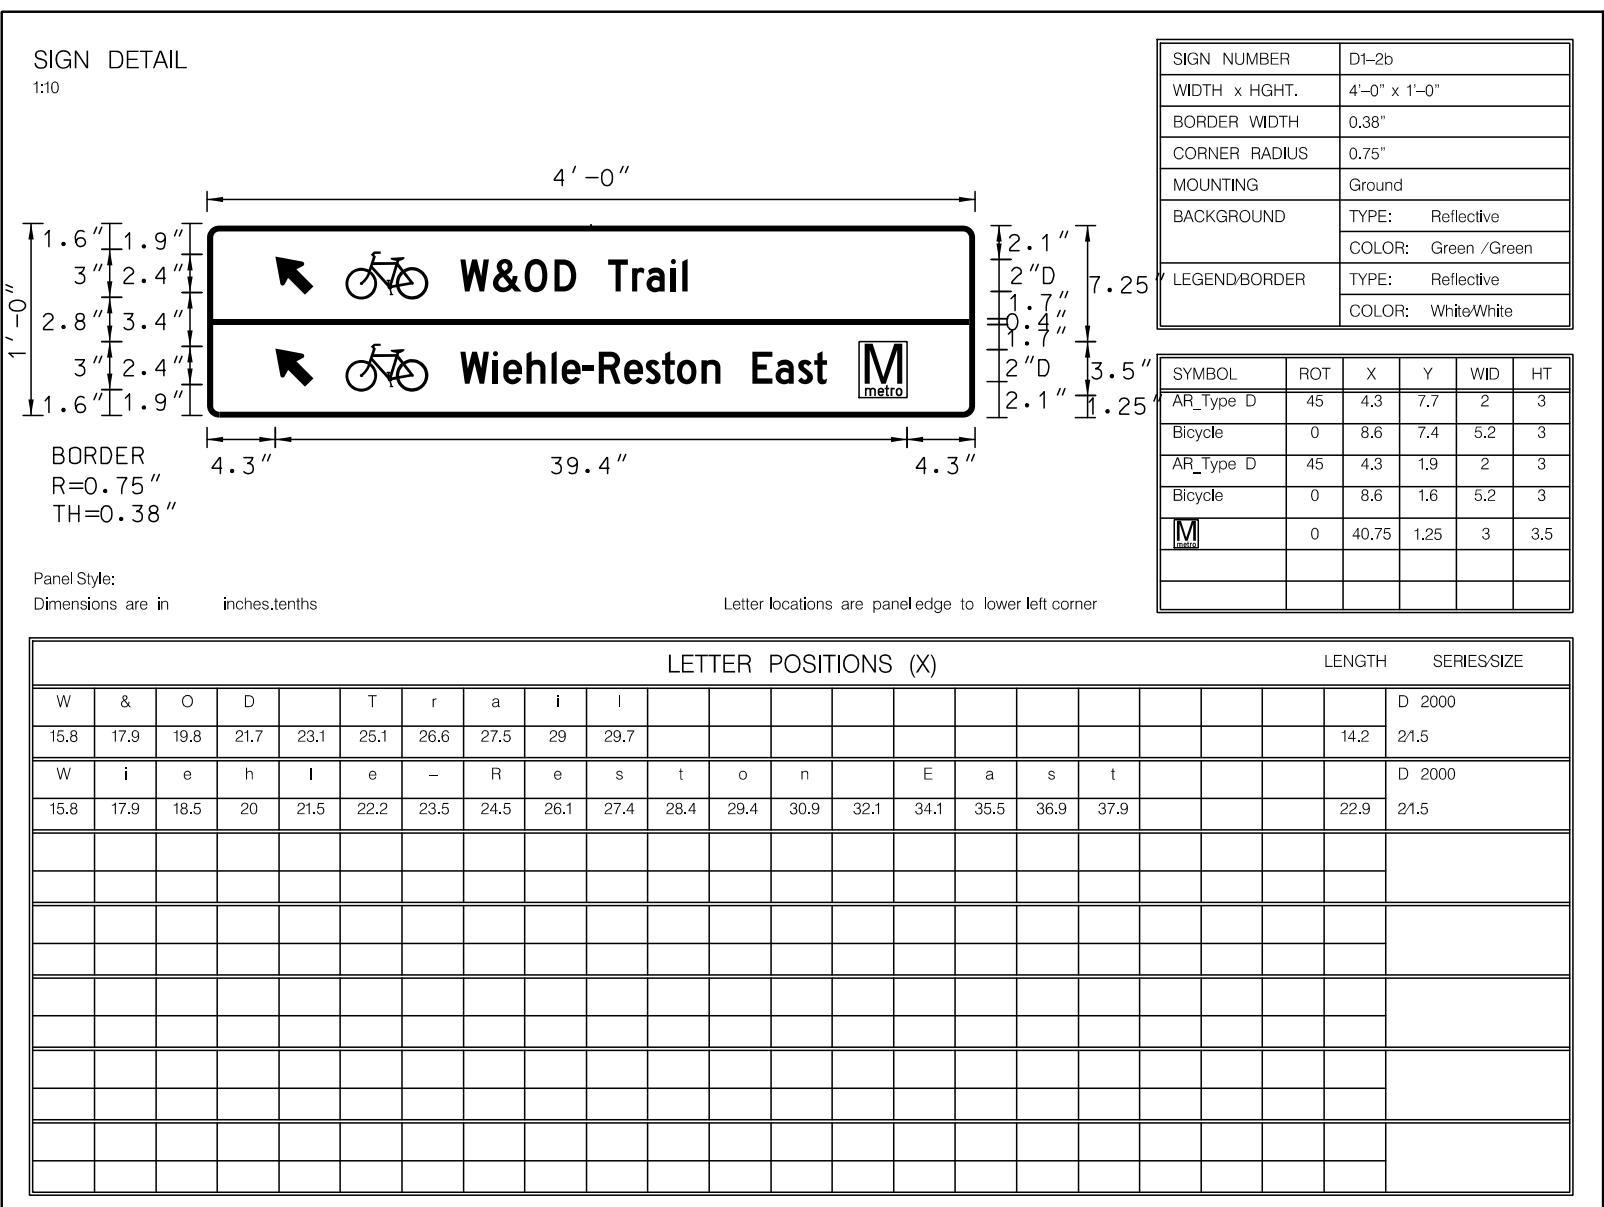
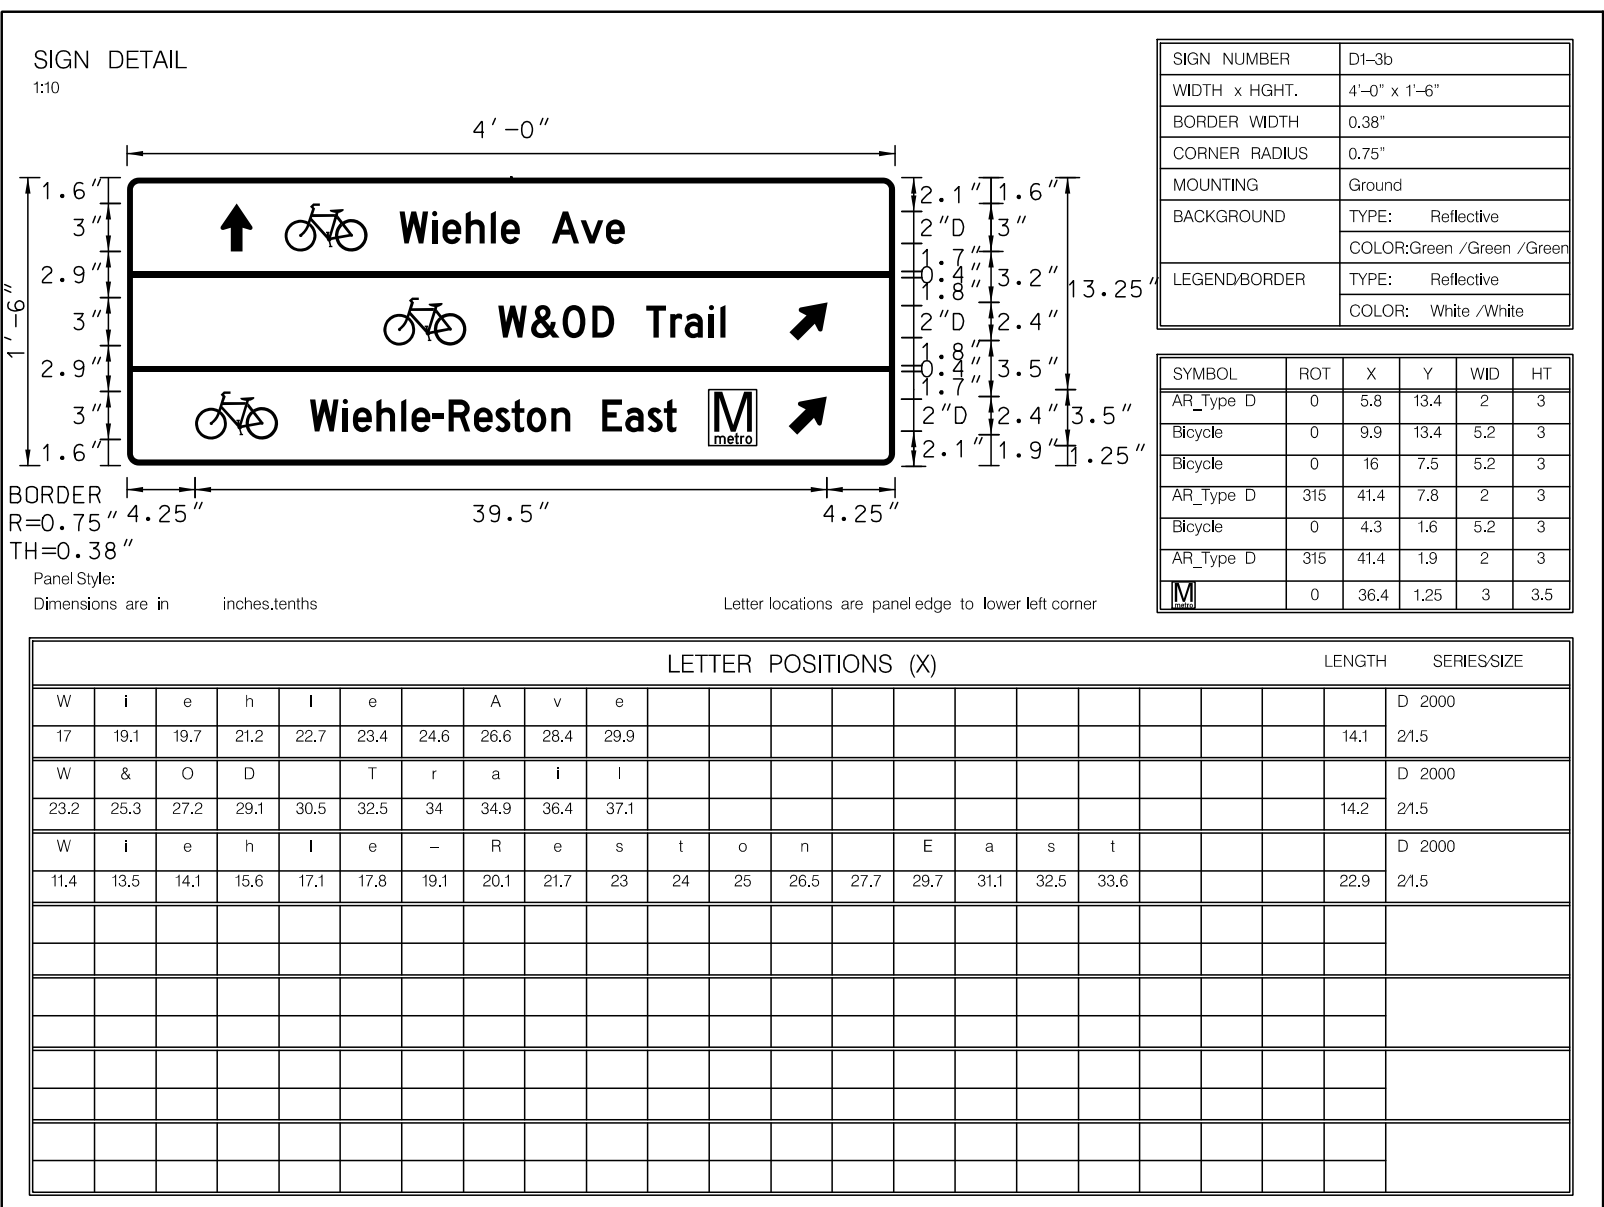
Whitman Requardt & Associates  
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TRAFFIC ENGINEER

EMERGENCY POLICE - FIRE - RESCUE 911			
FAIRFAX COUNTY, VIRGINIA			
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OFFICE OF CAPITAL FACILITIES 703-324-5800			
WIEHLE AVENUE (RTE 828) AT W&OD TRAIL SIGNING AND PAVEMENT MARKING PLAN PROJECT NO: 1400102-2013			
SCALE 1"=25'		DESIGNED: NDD	SHEET 7(3)
APPROVED BY THE TRANSPORTATION DESIGN DIVISION		CHECKED: RBH	

FUND # 500-C5000



## SIGN PANEL DETAILS



FUND # 500-C5000



PROJECT MANAGER SCOTT RUFFNER, P.E. (703) 877-5736  
SURVEYED BY, DATE FAIRFAX COUNTY, NOVEMBER 28, 2014  
DESIGN BY WHITMAN, REQUARDT & ASSOCIATES, LLP (703) 293-9717  
SUBSURFACE UTILITY BY, DATE SO DEEP, INC. (703) 361-6005 DECEMBER 23, 2014

## GENERAL NOTES - SIGNAL

1. ALL WORK SHALL BE IN ACCORDANCE WITH THE CURRENT EDITION OF THE MANUAL ON UNIFORM TRAFFIC CONTROL DEVICES (MUTCD), THE CURRENT EDITION OF THE VIRGINIA SUPPLEMENT TO THE MUTCD, THE CURRENT EDITION OF THE VDOT ROAD AND BRIDGE STANDARDS, THE CURRENT EDITION OF VDOT ROAD AND BRIDGE SPECIFICATIONS, AND SPECIAL PROVISIONS.
2. THE CONTRACTOR SHALL BE RESPONSIBLE FOR CONTACTING MISS UTILITY AND VDOT FOR SCHEDULING THE LOCATION OF UNDERGROUND UTILITIES. ALL UTILITIES MUST BE MARKED PRIOR TO INITIATION OF ANY CONSTRUCTION.
3. PRIOR TO BEGINNING ANY SIGNALIZATION WORK, THE CONTRACTOR SHALL NOTIFY THE ENGINEER IN WRITING FIVE WORKING DAYS PRIOR TO COMMENCING ANY WORK AT AN EXISTING SIGNAL AND PROVIDE THE FOLLOWING:
  - a. CONTRACTOR DAYTIME AND EMERGENCY TELEPHONE NUMBERS.
  - b. LOCATION OF INTERSECTION WHERE WORK IS TAKING PLACE.
4. THE CONTRACTOR SHALL MAINTAIN ALL EXISTING TRAFFIC SIGNAL EQUIPMENT (INCLUDING POWER AND COMMUNICATIONS) UNLESS OTHERWISE NOTED ON THE PLANS. INSTALLATION OF EQUIPMENT SHALL NOT DISRUPT OPERATION OF EXISTING SIGNAL UNLESS APPROVED BY THE ENGINEER.
5. ALL PROPOSED SIGNAL EQUIPMENT SHALL BE INSTALLED PRIOR TO DEACTIVATION OF EXISTING SIGNAL FOR WIRING SWITCH OVER. THE CONTRACTOR SHALL MAKE ARRANGEMENTS TO HAVE VDOT'S NROIC PERSONNEL PRESENT DURING SWITCHOVER (703-334-0882, BETWEEN 5:00 AM AND 7:00 PM, MONDAY-FRIDAY). A MINIMUM OF 48 HOURS ADVANCE NOTICE IS REQUIRED. THE CONTRACTOR SHALL HAVE HIS QUALIFIED REPRESENTATIVE PRESENT TO MONITOR TRAFFIC FLOW AND ADJUST TIMINGS AS NECESSARY, OR AS DIRECTED BY THE ENGINEER.
6. THE CONTRACTOR SHALL BE RESPONSIBLE FOR MAINTAINING DETECTION ON ALL APPROACHES TO THE INTERSECTION AT ALL TIMES AND THROUGHOUT ALL PHASES OF CONSTRUCTION. COORDINATED SIGNAL OPERATIONS SHALL BE MAINTAINED AT ALL TIMES, ONCE MODIFICATIONS ARE STARTED, IT IS THE SOLE RESPONSIBILITY OF THE CONTRACTOR UNTIL THE TRAFFIC SIGNAL IS ACCEPTED INTO THE VDOT SIGNAL SYSTEM.
7. THE PROJECT SHALL BE RESPONSIBLE FOR MAINTAINING COMMUNICATION TO THE TRAFFIC SIGNAL CONTROLLER AT ALL TIMES. THE PROJECT IS RESPONSIBLE FOR ALL COSTS ASSOCIATED WITH MAINTAINING COMMUNICATION TO THE TRAFFIC SIGNAL. THE PROJECT SHALL CONTACT VDOT'S NORTHERN REGION OPERATIONS COMMUNICATIONS GROUP AT NOVATFOCOMM@VDOT.VIRGINIA.GOV NINETEEN (90) DAYS PRIOR TO THE START OF THE TRAFFIC SIGNAL CONSTRUCTION TO IDENTIFY THE DESIGNATED COMMUNICATION PROVIDER AND TO INITIATE THE BROADBAND CIRCUIT ORDERING PROCESS.
8. THE CONTRACTOR IS RESPONSIBLE FOR ALL NOT ASSOCIATED WITH THE INSTALLATION OF THE PROPOSED TRAFFIC SIGNAL EQUIPMENT.
9. EXISTING CCTV SHALL REMAIN OPERATIONAL AND FULLY FUNCTIONAL WITHOUT INTERRUPTION FOR THE DURATION OF CONSTRUCTION.

# TRAFFIC SIGNAL MODIFICATION PLAN

## SIGNAL NOTES

## A. POLES AND FOUNDATIONS

1. MAST ARM LENGTHS ARE TO BE INSTALLED AS SHOWN ON PLAN AND ALL MAST ARMS ARE TO BE FIELD DRILLED ONLY. MAST ARM LENGTH IS SHOWN NEXT TO EACH MAST ARM IN THE PLAN VIEW.
  2. SIGNAL POLES TO BE INSTALLED WITH EIGHT BOLT BASE FLANGES ON EIGHT BOLT CONCRETE FOUNDATIONS.
  3. ALL BREAKAWAY POLES SHALL HAVE BREAKAWAY FUSES.
  4. ALL PEDESTAL POLES, STD PF-2, FOR PEDESTRIAN EQUIPMENT, SHALL BE 12 FT.
  5. ALL PROPOSED MAST ARMS, MAST ARM POLES, AND PEDESTAL POLES SHALL BE PAINTED TO MATCH EXISTING POLES.
- B. CONTROLLER AND FOUNDATION
1. THE CONTRACTOR SHALL BE RESPONSIBLE FOR MAINTAINING POWER TO THE CONTROLLER AT ALL TIMES. THE CONTRACTOR IS RESPONSIBLE FOR ANY COSTS RELATED TO MAINTAINING POWER TO THE TRAFFIC SIGNAL.
  2. THE FINAL SIGNAL TIMING PLAN INCLUDES EIGHT (8) TIME-OF-DAY TIMING PLANS TO REFLECT CYCLE LENGTHS NECESSARY TO ACCOMMODATE CHANGES IN TRAFFIC PATTERNS FOR WEEKDAYS AND WEEKENDS. THE EIGHT TIMING PLANS CONSIST OF FOUR TIMING PLANS FOR WEEKDAYS (AM, MID, PM, OFF-PEAK) AND FOUR TIMING PLANS FOR WEEKENDS (SATURDAY PEAK, SUNDAY PEAK, WEEKEND BEFORE PEAK, AND WEEKEND AFTER PEAK). THESE TIMING PLANS SHALL BE FIRST SUBMITTED TO THE VDOT PERMITS SECTION. THE PERMIT SECTION WILL THEN NOTIFY THE NRTD TRAFFIC SIGNAL OPERATIONS SECTION FOR REVIEW AND APPROVAL NO MORE THAN SIX (6) MONTHS PRIOR TO PROJECT COMPLETION AND NO LESS THAN SIXTY (60) DAYS PRIOR TO THE ACTIVATION OF THE TRAFFIC SIGNAL.

### C. TRAFFIC SIGNAL HEADS

1. ALL TRAFFIC SIGNAL HEADS SHALL BE CAST ALUMINUM.
  2. ALL SIGNAL HEADS SHALL HAVE POLYCARBONATE BACKPLATES. BACKPLATE HARDWARE SHALL BE STAINLESS STEEL.
  3. PEDESTRIAN SIGNAL HEADS SHALL BE INSTALLED IN ACCORDANCE WITH STANDARD SMB-3.
  4. PEDESTRIAN PUSHBUTTONS SHALL BE ACCESSIBLE PEDESTRIAN SYSTEM (APS) EQUIPMENT MEETING ALL OF THE REQUIREMENTS OF THE MUTCD, VIRGINIA SUPPLEMENT TO THE MUTCD, ADA, AND THE CONTRACT SPECIAL PROVISIONS. PEDESTRIAN PUSHBUTTONS SHALL BE INSTALLED IN ACCORDANCE WITH PA-2 OR PA-4 AS SPECIFIED AND SHALL BE IN ACCORDANCE WITH MUTCD, ADA, AND VDOT SPECIFICATIONS.
- D. DETECTORS
1. 6'X40' LOOP DETECTORS SHALL BE INSTALLED IN ACCORDANCE WITH ST'D. TD-1C AND SHALL BE PLACED 5' IN FRONT OF THE STOP BAR. 6'X6' LOOP DETECTORS SHALL BE INSTALLED IN ACCORDANCE WITH VDOT ST'D TD-1B AND SHALL BE PLACED 40' BEHIND THE STOP BAR (UNLESS OTHERWISE DIMENSIONED ON THE PLAN).
  2. 14'/ENCLOSED CONDUCTOR CABLE LEAD IN REQUIRES A 5/8" SAW CUT.
  3. LOOP DETECTOR AMPLIFIERS SHALL BE ONE FOR EACH LOOP EXCEPT THAT WHEN THERE ARE SETS OF 6'X 6' LOOPS, ONLY THE SET FARTHEST FROM THE STOP BAR SHALL HAVE SEPARATE AMPLIFIER UNITS. ALL OTHER 6'X6' SETS SHALL BE SPICES IN SERIES.

### E.CONDUIT, CONDUCTORS, AND ELECTRICAL

1. THE PROJECT SHALL BE RESPONSIBLE FOR MAINTAINING ELECTRICAL SERVICE TO THE CONTROLLER AT ALL TIMES. THE PROJECT SHALL BE RESPONSIBLE FOR ANY COSTS ASSOCIATED WITH MAINTAINING ELECTRICAL SERVICE TO THE TRAFFIC SIGNAL. THE NOVA SPEC. SE-5 ELECTRICAL SERVICE SHALL BE INSTALLED IN ACCORDANCE WITH STANDARD SE-5 SHOWN ON THE PLAN AND SECTION 238.02(H) OF THE VDOT ROADS AND BRIDGES SPECIFICATIONS. ELECTRICAL SERVICE SHALL BE METERED.
2. JUNCTION BOX COVERS SHALL HAVE THE LETTERS "TRAF" CAST IN THE TOP SURFACE. DEPRESSION FOR ALL THE SIGNAL RELATED JUNCTION BOXES CONTAINING CABLE WITH LESS THAN 50 VOLTS. ALL OTHER JUNCTION BOX COVERS SHALL HAVE THE LETTERS "ELEC" CAST IN THE TOP SURFACE DEPRESSION.
3. ALL JUNCTION BOXES SHALL BE INSTALLED IN ACCORDANCE WITH ST'D JB-S2 UNLESS OTHERWISE NOTED.
4. NO JB-S1, S2, OR S3 SHALL BE INSTALLED IN A PAVED SHOULDER, SIDEWALK, OR MULTI-PURPOSE TRAIL.
5. (S) DENOTES SHIELDED CABLE. (M) DENOTES METAL CONDUIT. (EGC) DENOTES EQUIPMENT GROUNDING CONDUCTOR. (E) DENOTES EXISTING)
6. ALL UNDERGROUND CONDUITS SHALL BE INSTALLED IN ACCORDANCE WITH ST'D. ECH-1.
7. FOR INSTALLATION OF CONDUIT, NO OPEN CUT WILL BE ALLOWED IN ROADWAY SURFACE.
8. ALL EXISTING CONDUIT NOT SHOWN FOR REUSE SHALL BE CAPPED AND ABANDONED.
9. ALL EXISTING WIRING NOT SHOWN FOR REUSE SHALL BE COMPLETELY REMOVED.
10. ALL PULL ROPE SHALL BE RATED AT 1100 LBS.
11. THE TRAFFIC SIGNAL WIRING AND ROADWAY LIGHTING WIRING SHALL USE SEPARATE CONDUITS AND JUNCTION BOXES. CONDUITS MAY SHARE COMMON TRENCHES AND BORE AS SHOWN ON THE PLAN.

## F. SIGNS AND PAVEMENT MARKINGS

1. ALL MAST ARM MOUNTED SIGNS SHALL BE MOUNTED IN ACCORDANCE WITH STD. SMD-2.
2. PAVEMENT MARKINGS SHALL BE MODIFIED TO REFLECT THE MARKINGS SHOWN ON THE PLAN WHEN THE SIGNAL IS INSTALLED.
3. ANY EXISTING PAVEMENT MARKINGS THAT ARE IN CONFLICT WITH PROPOSED PAVEMENT MARKINGS SHALL BE COMPLETELY ERADICATED.
4. LIMITS SHOWN ON PROPOSED MARKING ARE APPROXIMATE AND SHALL BE MODIFIED IN THE FIELD TO ENSURE THAT PROPOSED PAVEMENT MARKINGS CONTINUE UNTIL EXISTING PAVEMENT MARKINGS CAN BE MATCHED.

## LABELS

<i>Proposed Signal Head</i>	②
<i>Existing Signal Head</i>	②
<i>Proposed Pedestrian Signal Head</i>	Ⓟ
<i>Existing Pedestrian Signal Head</i>	Ⓟ
<i>Signal Pole or Controller</i>	△
<i>Cable and Conduit</i>	◇
<i>Construction Notes</i>	△
<i>Signal Phasing</i>	Ø 2
<i>Sign</i>	S-1

## SIGN PANEL DETAILS


[illegible][illegible]

## MOT NOTES

1. ALL TEMPORARY TRAFFIC CONTROL DEVICES SHALL BE INSTALLED PRIOR TO THE START OF CONSTRUCTION AND SHALL BE REMOVED OR RELOCATED AS THE WORK IS COMPLETED OR WORK CONDITIONS CHANGE. THE CONTRACTOR SHALL ENSURE THAT ALL TEMPORARY TRAFFIC CONTROL DEVICES REMAIN IN PLACE AND OPERATING AT ALL TIMES.
2. THE CONTRACTOR SHALL VERIFY PROPOSED GEOMETRICS PRIOR TO INSTALLING SIGNAL EQUIPMENT.
3. ALL JUNCTION BOXES SHALL BE INSTALLED AT FINAL GRADE.
4. THE CONTRACTOR SHALL REPAIR ANY DAMAGE TO EXISTING SIDEWALKS CAUSED BY THE INSTALLATION OF THE SIGNAL EQUIPMENT.
5. ALL EXISTING SIGNS NOT RELOCATED OR REMOVED SHALL REMAIN UNLESS OTHERWISE APPROVED BY THE ENGINEER.
6. THE CONTRACTOR SHALL INSTALL CONDUIT AT SUFFICIENT DEPTH TO AVOID DISTURBANCE DURING ROADWAY CONSTRUCTION. CONDUIT SHALL BE INSTALLED PRIOR TO BEGINNING ROADWAY CONSTRUCTION.
7. NEW TRAFFIC SIGNAL HEADS AND OVERHEAD TRAFFIC SIGNAL SIGNAGE SHALL BE COVERED WITH DURABLE NON-TRANSPARENT COVER UPON INSTALLATION. THE CONTRACTOR SHALL MAINTAIN THE COVERS UNTIL THE NEW TRAFFIC SIGNAL SYSTEM IS OPERATIONAL.
8. THE CONTRACTOR SHALL NOT BLOCK THE VIEW OF EXISTING SIGNAL INDICATIONS DURING INSTALLATION OF THE MAST ARMS.
9. THE CONTRACTOR SHALL BE RESPONSIBLE FOR MAINTAINING DETECTION ON ALL APPROACHES OF THE INTERSECTION AT ALL TIMES, AND THROUGHOUT ALL PHASES OF CONSTRUCTION UNLESS OTHERWISE NOTED ON THE PLANS.
10. MAINTENANCE AND REPAIR OF THE TRAFFIC SIGNAL AND ANY NECESSARY MODIFICATIONS DURING CONSTRUCTION SHALL BE THE SOLE RESPONSIBILITY OF THE CONTRACTOR.

PLAN ITEM	PLAN SYMBOL	
	PROPOSED	EXISTING
Metal Signal Pole & Foundation and Mast Arm (As noted In Signal Pole Legend)		
Pedestal Pole and Foundation (Std.PF-2)		
Pedestal Pole and Foundation (Std.PA-3)		
Traffic Signal Head w/ Backplate		
Traffic Signal Head w/o Backplate		
Pedestrian Signal Head		
Pedestrian Pushbutton & Sign		
Traffic Signal Sign Mast Arm or Span Wire Mt'd. Pole Mounted		
Video Detection Camera		
Emergency Vehicle Pre-emption (EVP) Sensor w/ Conf.Light		
Controller Cabinet & Foundation (Std.CF-3)		
Junction Box (Std.as noted on plans)		
Signal Luminaire (250 W) and Arm		
Signal Luminaire (400 W) and Arm		
Loop Detector (Size as noted on plans)		
Video Detection Zone (Size as noted on plans)		
Conduit		



 Whitman Requardt & Associates Richmond, Virginia TRAFFIC ENGINEER	<b>EMERGENCY POLICE – FIRE – RESCUE 911</b>						
	<b>FAIRFAX COUNTY, VIRGINIA</b>						
	<b>DEPARTMENT OF PUBLIC WORKS AND ENVIRONMENTAL SERVICES</b>						
	<b>12000 GOVERNMENT CENTER PARKWAY, SUITE 449 FAIRFAX, VA., 22035-0052</b>						
	R					<b>OFFICE OF CAPITAL FACILITIES</b> <b>703-324-5800</b>  <b>WIEHLE AVENUE (ROUTE 828) AT W&amp;OD TRAIL</b> <b>WIEHLE AVE. (ROUTE 828) AT SUNSET HILLS RD.</b> <b>(ROUTE 675) SIGNAL PLAN</b>  <b>PROJECT NO: 1400102-2013</b>	
	E						
	V						
	I						
	S						
	O						
I							
N							
S							
#/	DESCRIPTION	BY	APPROVED	DATE	SCALE		DESIGNED: NDD DRAFTED: WRA CHECKED: RBH
<b>APPROVED BY THE TRANSPORTATION DESIGN DIVISION</b>							

**FUND # 500-C5000**



PROJECT MANAGER: SCOTT BUFFNER, P.E. (703) 877-5736  
SURVEYED BY: DATE: FAIRFAX COUNTY, NOVEMBER 28, 2014  
DESIGN BY: WHITMAN, REQUARDT & ASSOCIATES, LLP (703) 293-9707  
SUBSURFACE UTILITY BY: DATE: SO DEEP, INC. (703) 366-6005, DECEMBER 23, 2014

### Signal Pole & Controller Legend

(ALL DIMENSIONS ARE TO CENTER OF POLE)

- A** MAST ARM POLE, TYPE E (MP-3)  
75.2' LT. of Wiehle Ave. (Rte. 828) Constr. @ Sta. 402+58  
65' Arm 180° Angle to Wiehle Ave. (Rte. 828) Constr. @  
Signal Placement: 28.5', 39.5', 50.5', 61.5'  
Sign Placement: 15.5', 24.5', 46.5', 57.5'  
18' Luminaire Arm 135° Angle to Wiehle Ave. (Rte. 828) Constr. @
- B** MAST ARM POLE, TYPE E (MP-3)  
60.8' RT. of Wiehle Ave. (Rte. 828) Constr. @ Sta. 402+75  
65' Arm 270° Angle to Wiehle Ave. (Rte. 828) Constr. @  
Signal Placement: 22.5', 37.5', 52.5', 64.5'  
Sign Placement: 11.5', 18.5'  
18' Luminaire Arm 205° Angle to Wiehle Ave. (Rte. 828) Constr. @
- C** PEDESTAL POLE (PF-2), 12'  
84.9' LT. of Wiehle Ave. (Rte. 828) Constr. @ Sta. 402+41
- D** PEDESTAL POLE (PF-2), 12'  
55.4' LT. of Wiehle Ave. (Rte. 828) Constr. @ Sta. 402+65
- E** PEDESTAL POLE (PF-2), 12'  
43.8' RT. of Wiehle Ave. (Rte. 828) Constr. @ Sta. 402+68
- F** PEDESTAL POLE (PF-2), 12'  
79.0' RT. of Wiehle Ave. (Rte. 828) Constr. @ Sta. 402+45

NOTE: Luminaire(s) on combination signal pole(s) shall be 400 W H.P.S.

### SIGNAL NOTES

- A** REMOVE EXISTING SIGNAL POLES, MAST ARMS, SIGNS, SIGNAL HEADS AND REMOVE FOUNDATIONS 24" BELOW GRADE.
- A** REMOVE EXISTING PEDESTAL POLES, PEDESTRIAN SIGNAL HEADS, SIGNS, AND REMOVE FOUNDATIONS 24" BELOW GRADE.
- A** REMOVE EXISTING JUNCTION BOX.
- A** FOR EXISTING CONDUITS THAT ARE NOT SCHEDULED FOR REUSE, REMOVE ALL CABLES AND CAP AND ABANDON CONDUITS.
- A** REPLACE EXISTING PUSHBUTTON WITH ACCESSIBLE PEDESTRIAN SIGNAL (APS) PUSHBUTTON.

INITIAL TIMING CHART								
PHASE	1	2	3	4	5	6	7	8
MOVEMENT	WIEHLE AVE NB LEFT	WIEHLE AVE SB	SUNSET HILLS RD WB LEFT	SUNSET HILLS RD EB	WIEHLE AVE SB LEFT	WIEHLE AVE NB	SUNSET HILLS RD EB LEFT	SUNSET HILLS RD WB
PHASE ON	X	X	X	X	X	X	X	X
PHASE OFF								
INTERVAL	PHASE TIMINGS							
MIN GR	5.0	15.0	8.0	8.0	5.0	15.0	5.0	8.0
AMBER	3.5	4.5	3.2	4.4	4.5	4.5	4.4	4.4
RED	3.3	3.6	4.4	3.5	3.6	3.6	3.5	3.5
MAX	30.0	40.0	30.0	30.0	30.0	40.0	30.0	30.0
PASSAGE	2.0	4.0	4.0	3.0	2.0	3.0	3.0	3.0
MIN GAP	0.0	0.0	0.0	0.0	0.0	0.0	0.0	0.0
PED WALK	-	7.0	-	8.0	-	7.0	-	7.0
PED FDW	-	22.0	-	30.0	-	15.0	-	23.0
MODE	NON LOCK	MIN RECALL	NON LOCK	NON LOCK	NON LOCK	MIN RECALL	NON LOCK	NON LOCK

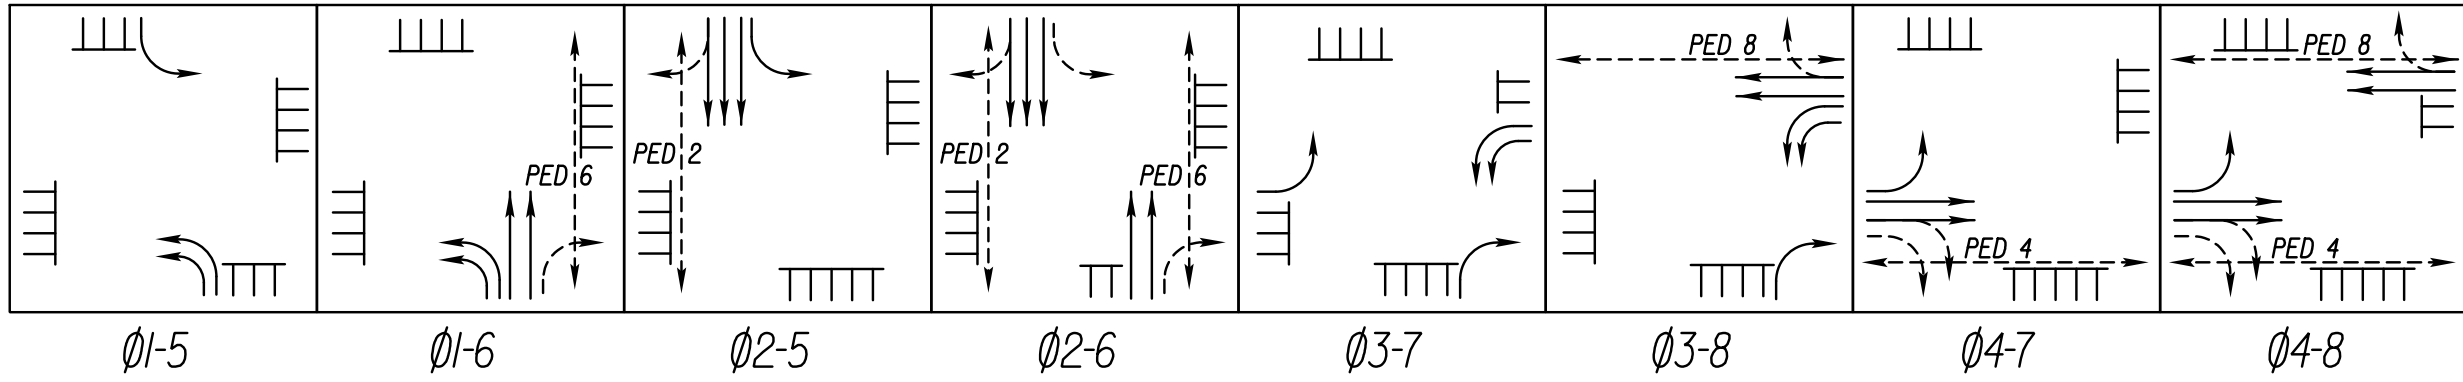
### Color Sequence Chart

SIGNAL	PHASES								COMBINATIONS								FLASH
	1	2	3	4	5	6	7	8	1-5	1-6	2-5	2-6	3-7	3-8	4-7	4-8	
1	-G								-G	-G							
2		G									G	G					Y
3			-G										-G	-G			
4				G					R		G	G			G	G	
5		G			-G				-G	R	-G						Y
6						G				G		G					Y
6a			R							G		G	R	G	R	G	Y
7				G			-G	R					-G	R	-G	G	
8								G						G		G	
P2		W									W	W					BLANK
P4				W								W			W		BLANK
P6					W					W		W				W	BLANK
P8							W						W		W		BLANK


Empty box denotes RED indication.  
Walk indication displayed after pedestrian call is serviced; otherwise "DON'T WALK" indication is displayed.

# TRAFFIC SIGNAL MODIFICATION PLAN



## PHASING DIAGRAM




## EXISTING SIGNING

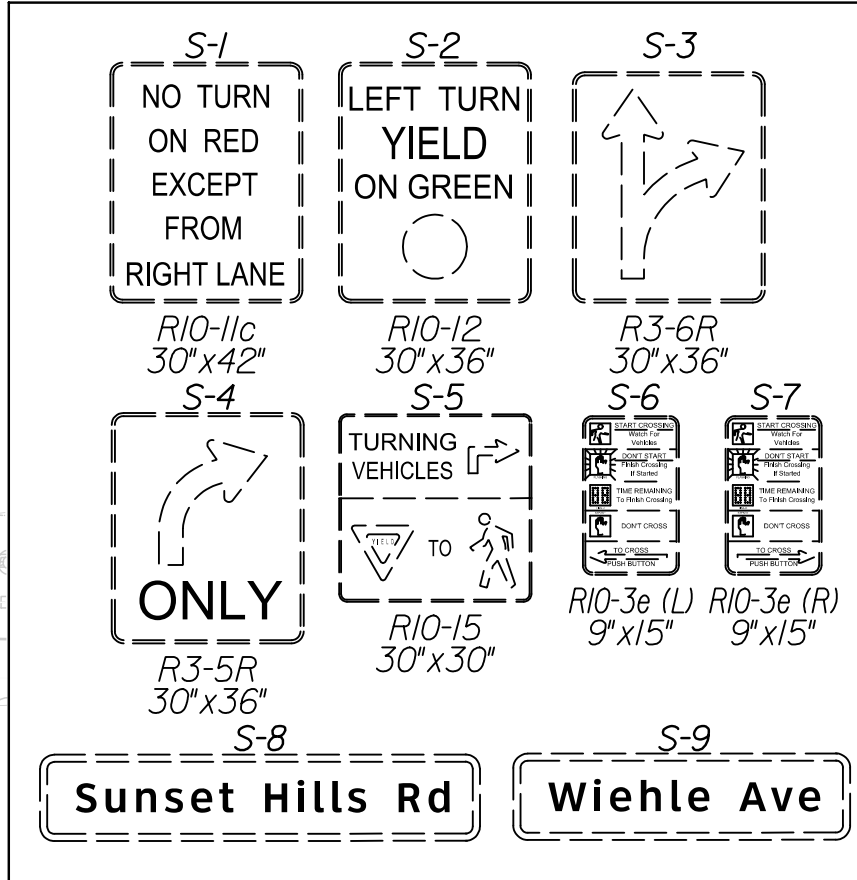


## EXISTING SIGNALS

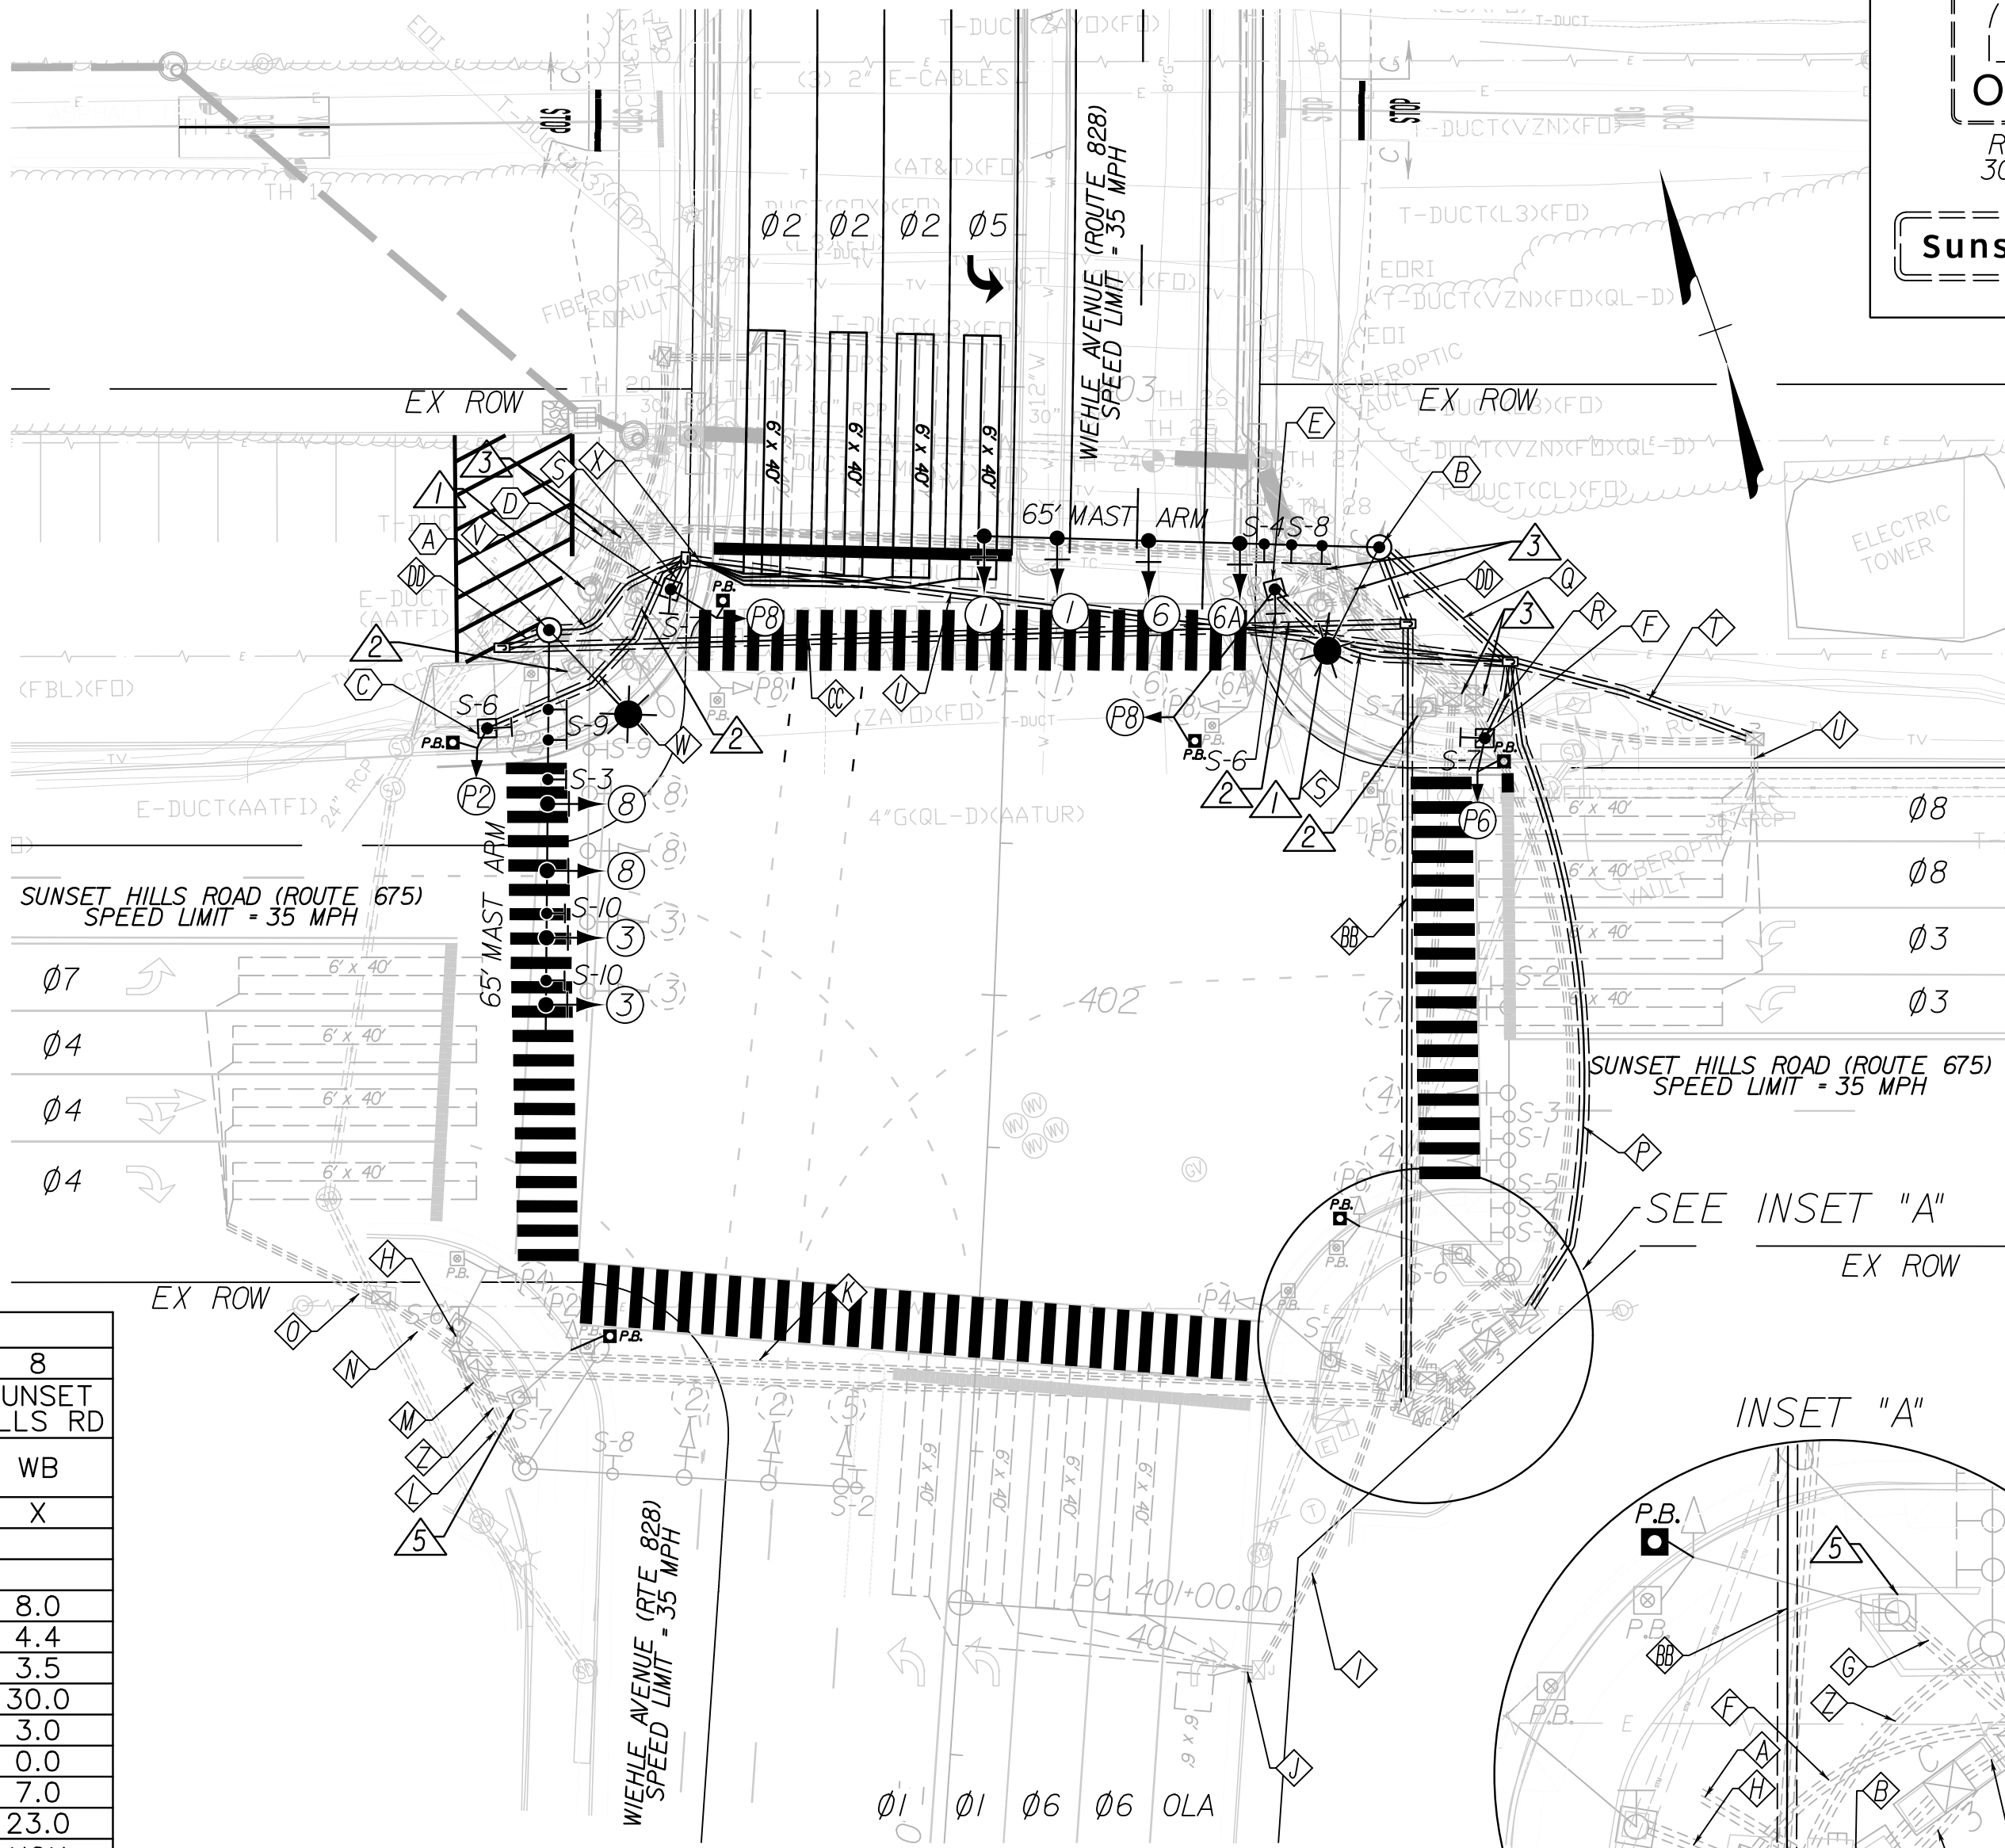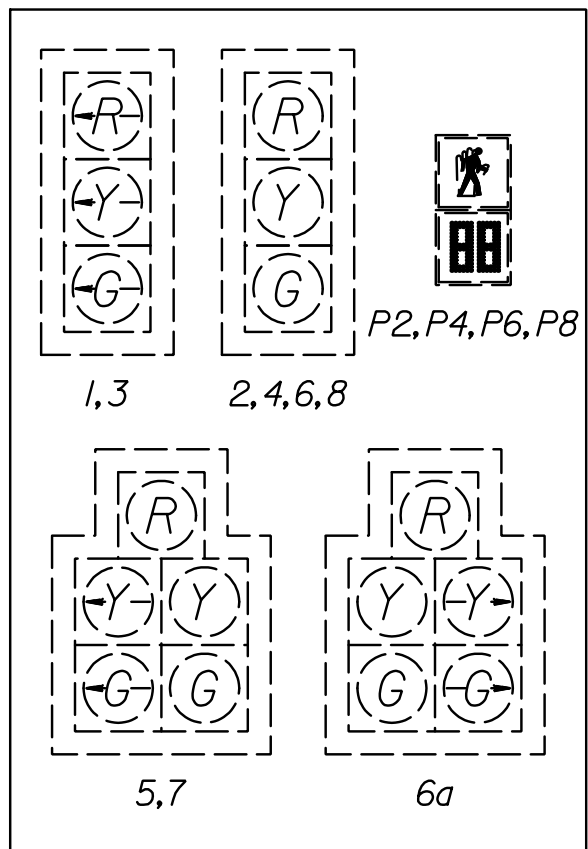

## PROPOSED SIGNING

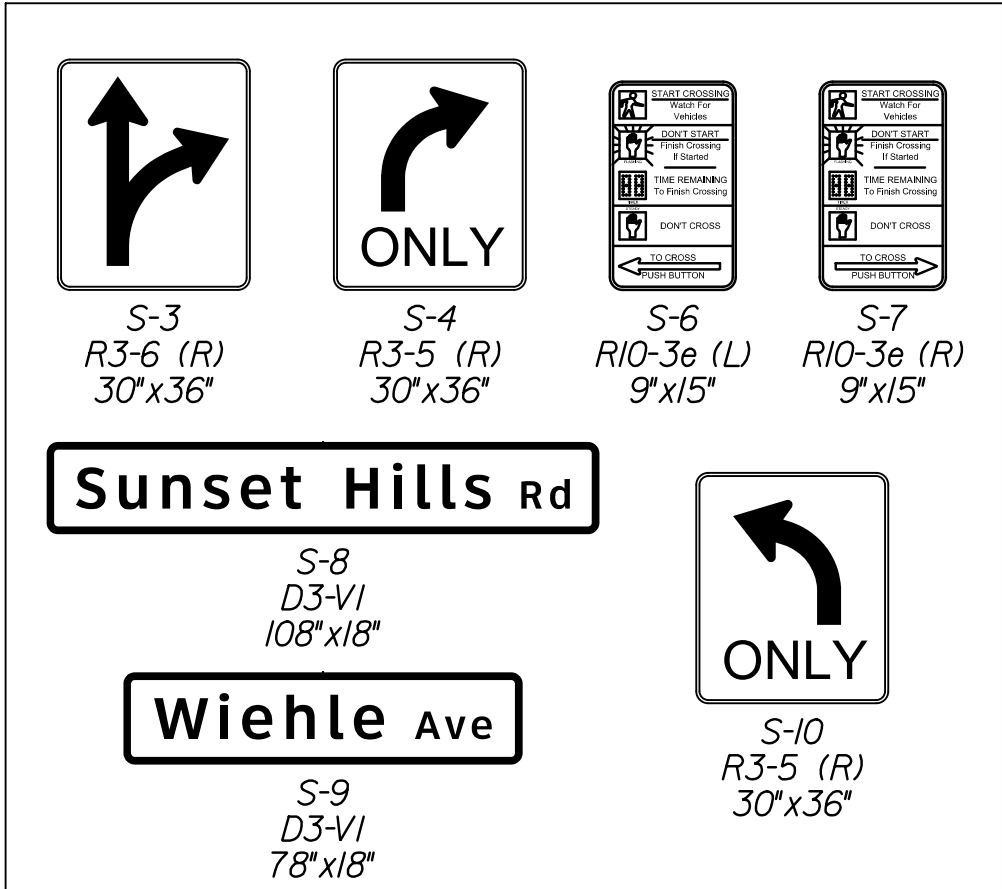

## PROPOSED SIGNALS

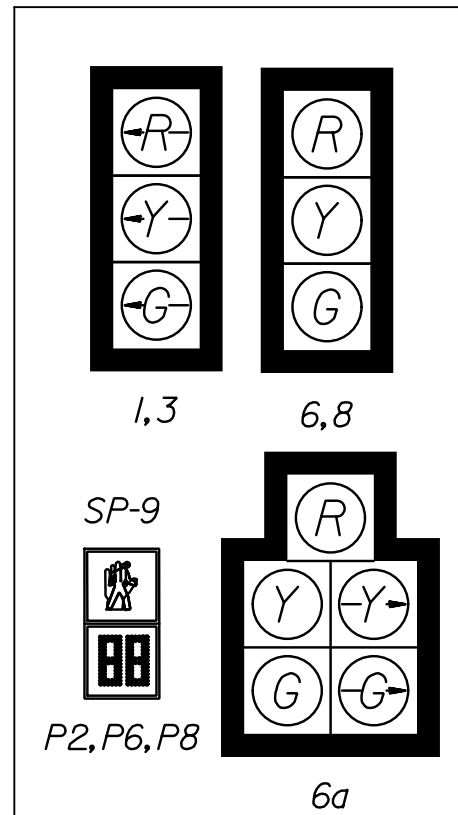

Whitman Requardt & Associates  
Richmond, Virginia  
TRAFFIC ENGINEER




SCALE  
0 25' 50'

EMERGENCY POLICE - FIRE - RESCUE 911			
FAIRFAX COUNTY, VIRGINIA			
DEPARTMENT OF PUBLIC WORKS AND ENVIRONMENTAL SERVICES			
12000 GOVERNMENT CENTER PARKWAY, SUITE 449 FAIRFAX, VA., 22035-0052			
OFFICE OF CAPITAL FACILITIES 703-324-5800			
WIEHLE AVENUE (ROUTE 828) AT W&OD TRAIL WIEHLE AVE. (ROUTE 828) AT SUNSET HILLS RD. (ROUTE 675) SIGNAL PLAN			
PROJECT NO: 1400102-2013			
SCALE 1"=25'		DESIGNED: NDD DRAFTED: WRA CHECKED: RBH	SHEET 8(2)
FUND # 500-C5000			



# UTILITY PLAN SHEET

FUND # 500-C5000

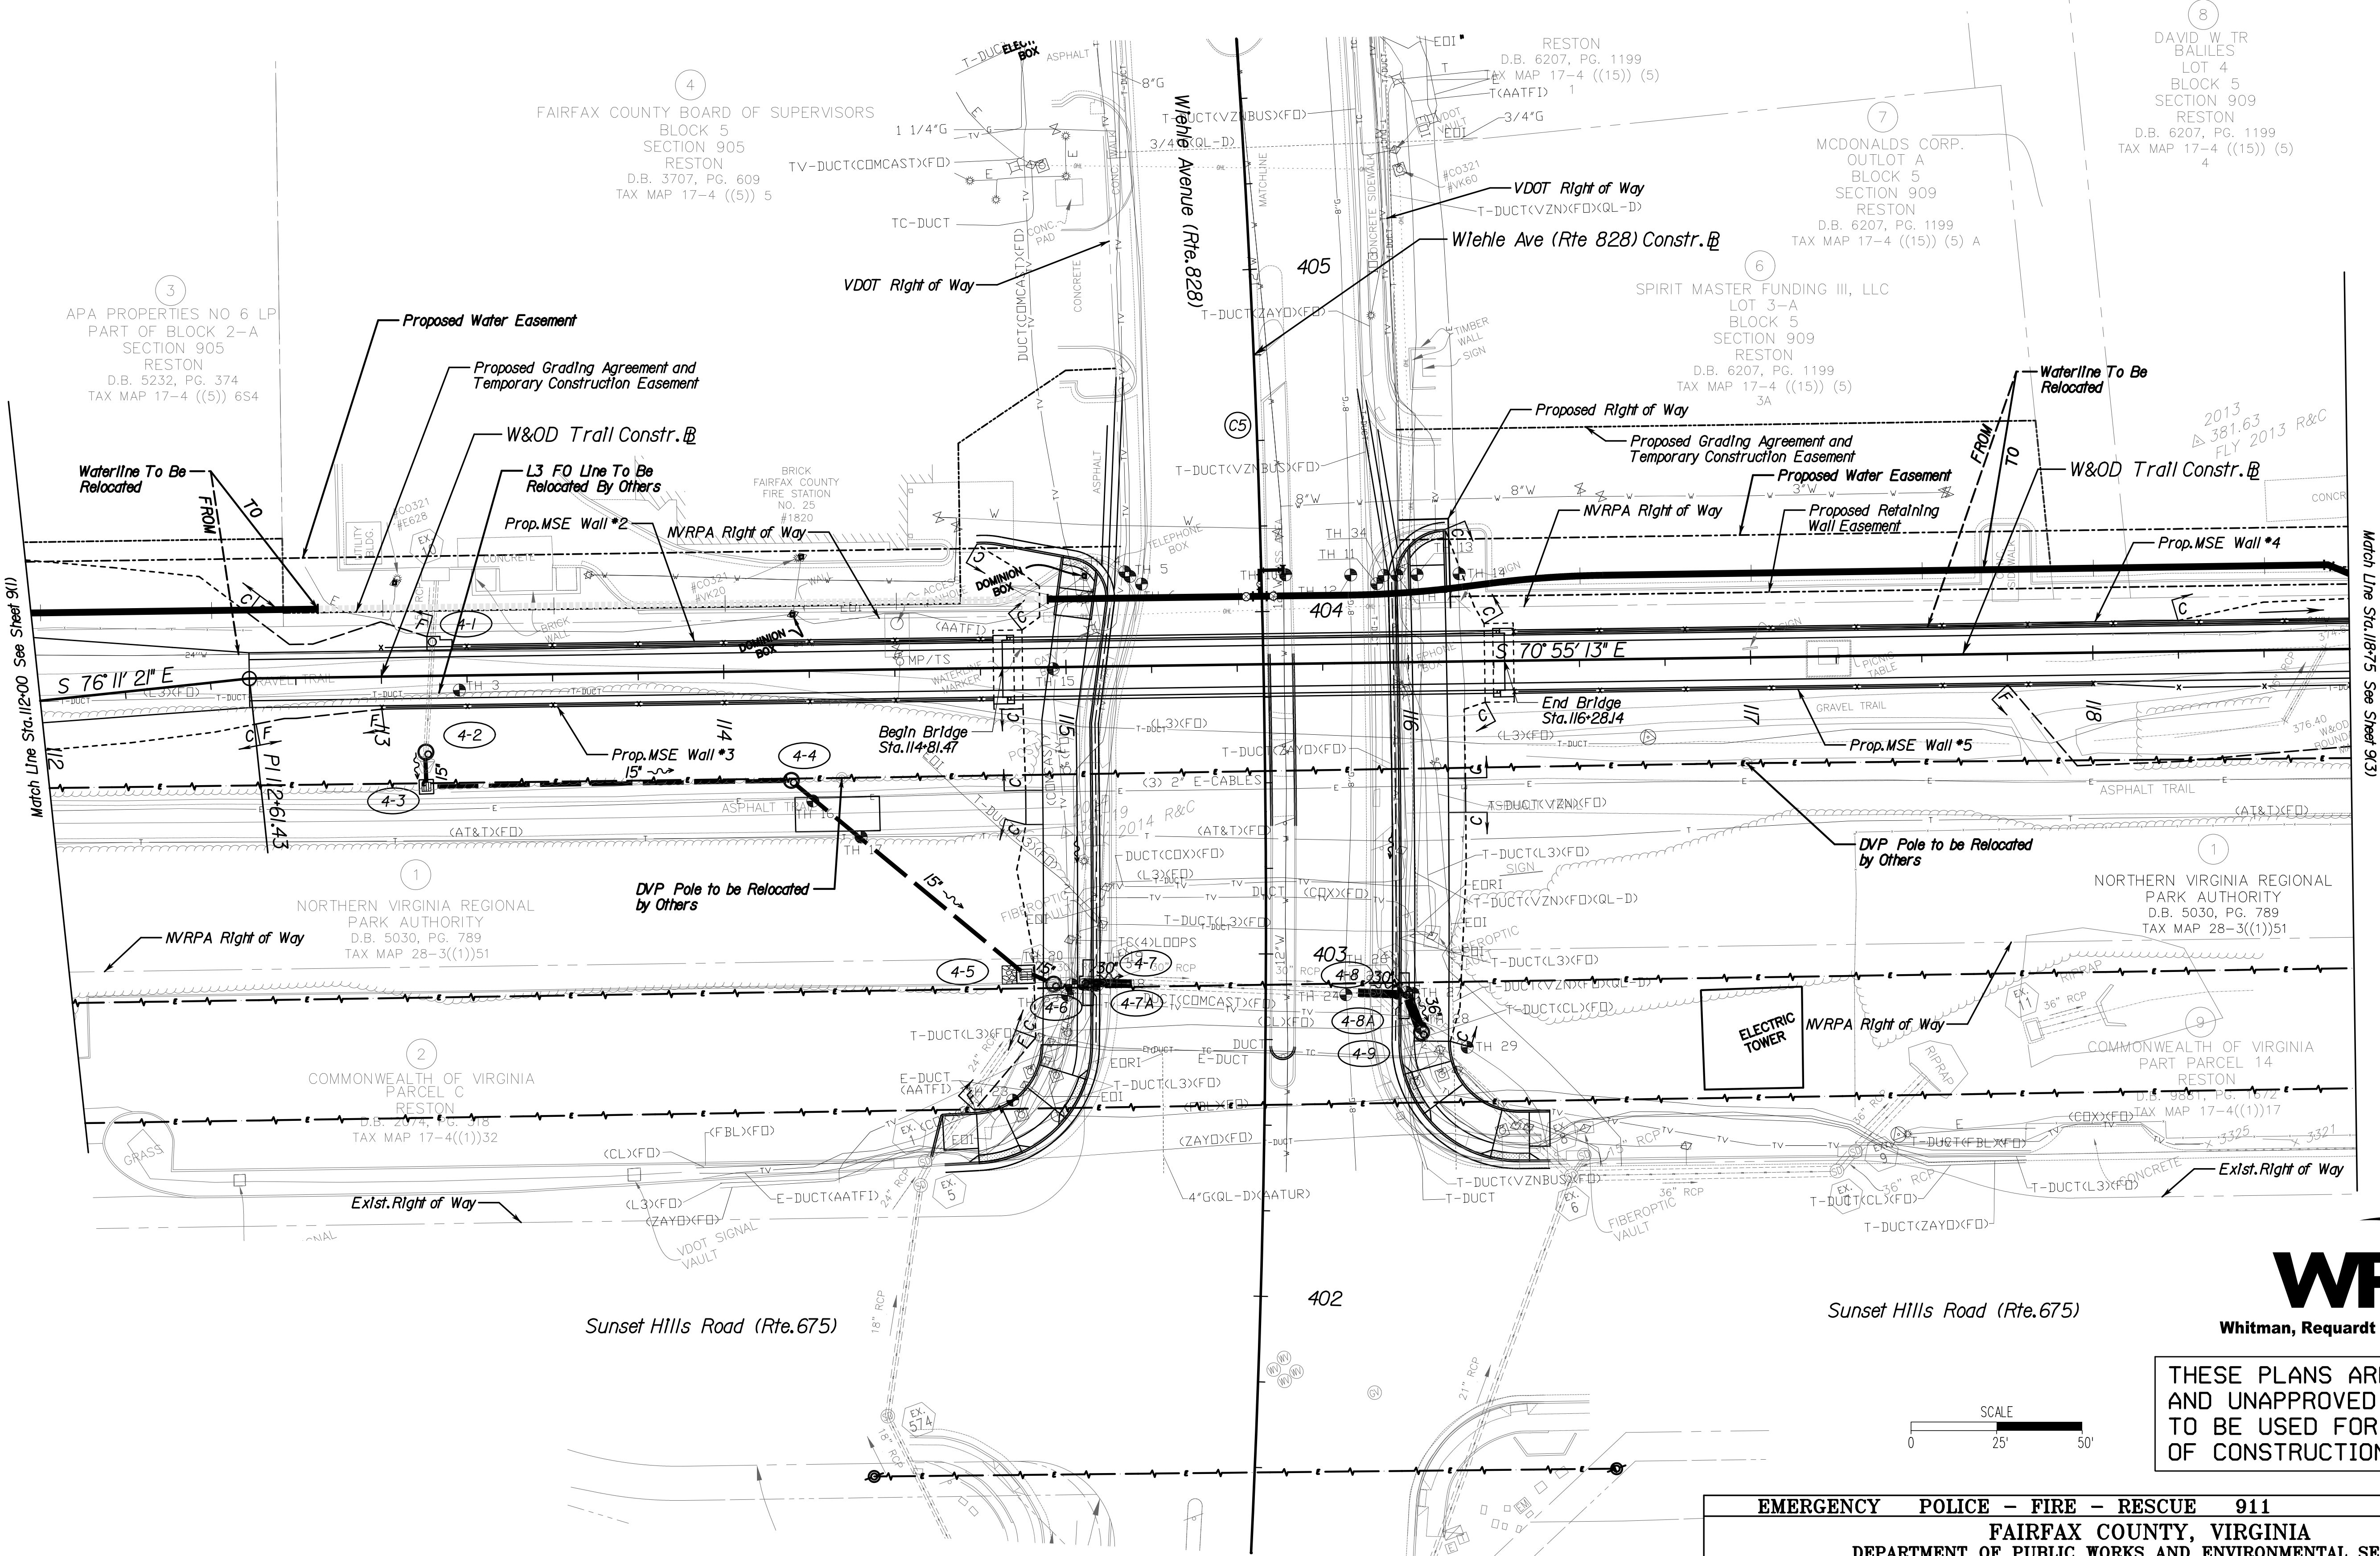
 Denotes Construction Limits In Cuts  
 Denotes Construction Limits In Fills  
 Denotes Proposed Graded "V" Ditch

(C2) Curve W0&D-2  
 $PI = 109^{\circ}48.44$   
 $DELTA = 8^{\circ}50'03.43''$  (RT)  
 $D = 32^{\circ}44'26''$   
 $T = 13.52'$   
 $L = 26.98'$   
 $R = 175.00'$   
 $PC = 109+34.92$   
 $PT = 109+61.90$




PROJECT MANAGER: SCOTT RUEFFNER, P.E. (703) 871-5736  
SURVEYED BY: DATE: FAIRFAX COUNTY, NOVEMBER 28, 2014  
DESIGN BY: WHITMAN, REQUARDT & ASSOCIATES, LLP (703) 293-9717  
SUBSURFACE UTILITY BY: DATE: SO DEEP, INC. (703) 361-6005 DECEMBER 23, 2014

UTILITY PLAN SHEET



Whitman, Requardt & Associates, LLP

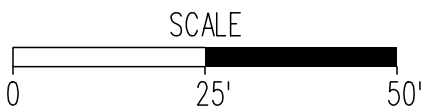THESE PLANS ARE UNFINISHED AND UNAPPROVED AND ARE NOT TO BE USED FOR ANY TYPE OF CONSTRUCTION.



LEGEND

- Denotes Construction Limits In Cuts
- Denotes Construction Limits In Fills
- Denotes Proposed Graded "V" Ditch
- (C5) Curve WIEHLE-1  
PI = 403+89.81  
DELTA = 8° 35' 10.7" (LT)  
D = 129' 03"  
T = 289.81'  
L = 578.53'  
PC = 386.50'  
PT = 406+78.53


EMERGENCY POLICE - FIRE - RESCUE 911			
FAIRFAX COUNTY, VIRGINIA			
DEPARTMENT OF PUBLIC WORKS AND ENVIRONMENTAL SERVICES			
12000 GOVERNMENT CENTER PARKWAY, SUITE 449 FAIRFAX, VA., 22035-0052			
OFFICE OF CAPITAL FACILITIES 703-324-5800			
WIEHLE AVENUE (RTE 828) AT W&OD TRAIL UTILITY PLAN SHEET			
PROJECT NO: 1400102-2013			
SCALE 1"=25'		DESIGNED: NDD DRAFTED: WRA CHECKED: RBH	SHEET 9(2)
APPROVED BY THE TRANSPORTATION DESIGN DIVISION			

FUND # 500-C5000




PROJECT MANAGER: SCOTT RUEFFNER, P.E. (703) 871-5736  
SURVEYED BY: DATE: FAIRFAX COUNTY, NOVEMBER 28, 2014  
DESIGN BY: WHITMAN, REQUARDT & ASSOCIATES, LLP (703) 293-9717  
SUBSURFACE UTILITY BY: DATE: SO DEEP, INC. (703) 361-6005 DECEMBER 23, 2014

# UTILITY PLAN SHEET

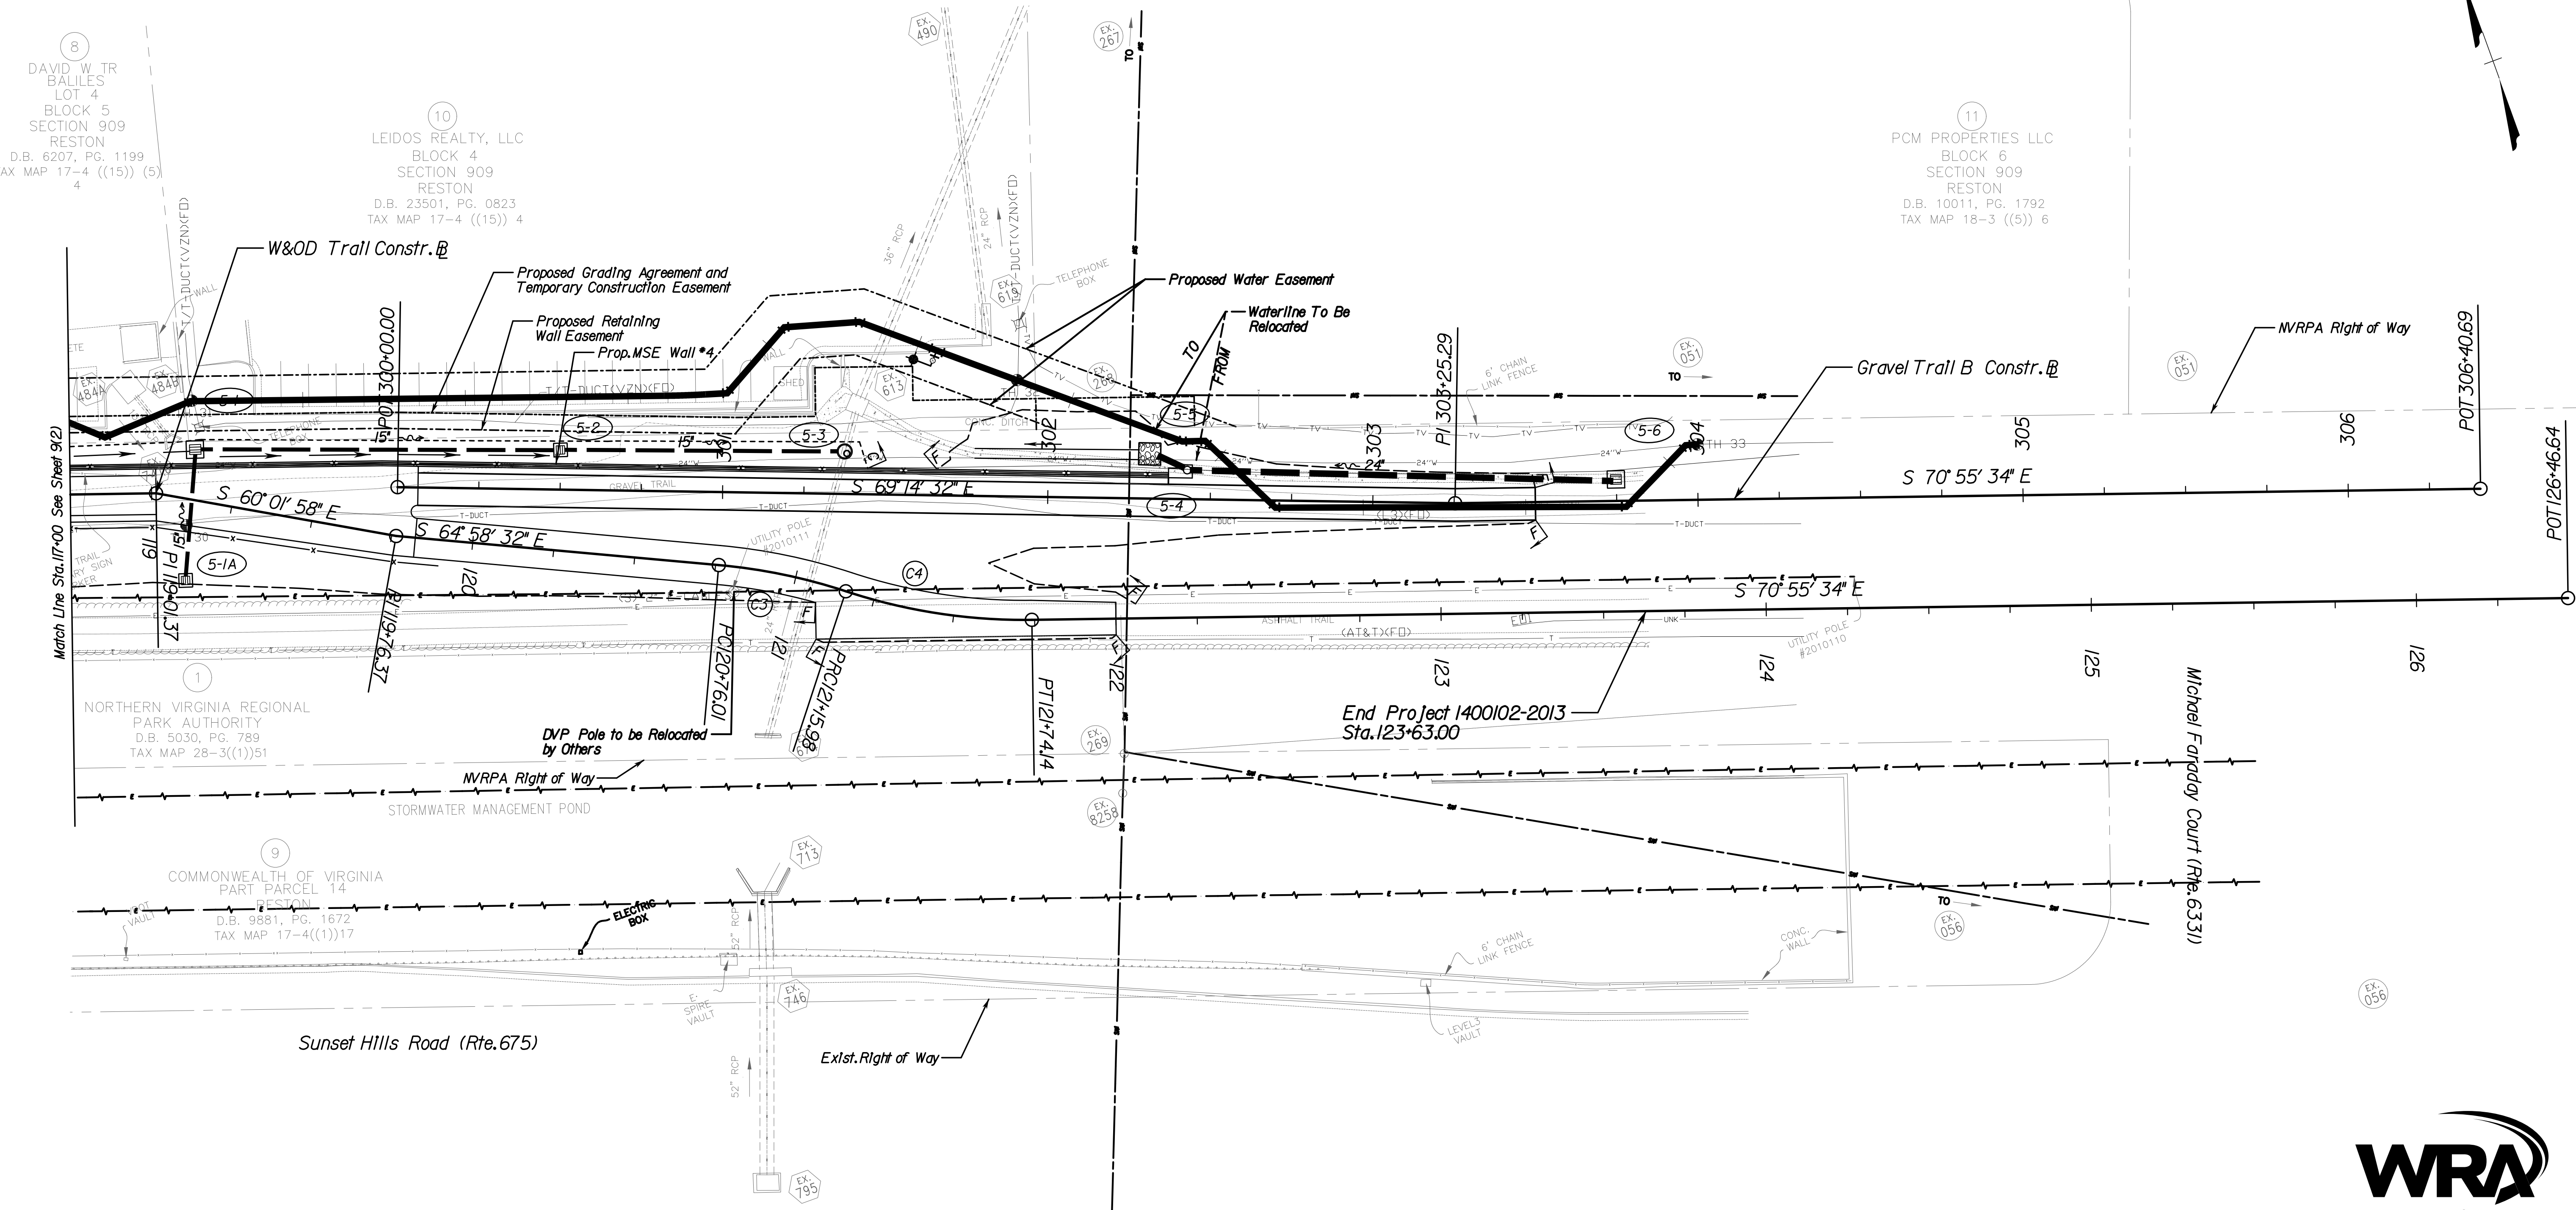

Whitman, Requardt & Associates, LLP

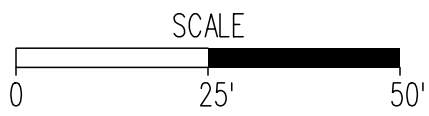THESE PLANS ARE UNFINISHED AND UNAPPROVED AND ARE NOT TO BE USED FOR ANY TYPE OF CONSTRUCTION.



- LEGEND**
- Denotes Construction Limits In Cuts
  - Denotes Construction Limits In Fills
  - Denotes Proposed Graded "V" Ditch
  - (C3) Curve W&D-3  
PI = 120+96.08  
DELTA = 13° 05' 20.8" (RT)  
D = 32' 44' 26"  
T = 20.08'  
L = 39.98'  
R = 175.00'  
PC = 120+76.01  
PT = 121+15.98
  - (C4) Curve W&D-4  
PI = 121+45.33  
DELTA = 19° 02' 22.55" (LT)  
D = 32' 44' 26"  
T = 29.35'  
L = 58.15'  
R = 175.00'  
PC = 121+15.98  
PT = 121+74.14

EMERGENCY POLICE - FIRE - RESCUE 911			
FAIRFAX COUNTY, VIRGINIA			
DEPARTMENT OF PUBLIC WORKS AND ENVIRONMENTAL SERVICES			
12000 GOVERNMENT CENTER PARKWAY, SUITE 449 FAIRFAX, VA., 22035-0052			
OFFICE OF CAPITAL FACILITIES 703-324-5800			
WIEHLE AVENUE (RTE 828) AT W&OD TRAIL			
UTILITY PLAN SHEET			
PROJECT NO: 1400102-2013			
SCALE 1"=25'		DESIGNED: NDD	SHEET 9(3)
APPROVED BY THE TRANSPORTATION DESIGN DIVISION		DRAFTED: WRA	CHECKED: RBH

FUND # 500-C5000



Beginning of wall  
Sta. 10+11.62  
Elev. 389.52

Elev. 390.16

Elev. 391.10

Coping

Elev. 392.04

Va. Drystack  
Architectural treatment

Elev. 392.70

Match line Sta. 11+61.62

Elev. 384.5

Elev. 383.0

Elev. 381.5

Step in 6" leveling pad typ.

Elev. 380.5

2'-6"  $\varnothing$  prebored hole typ.

Elev. 378.5

Soldier pile typ.

Elev. 376.5

Existing grade

Elev. 375.5


**SOLDIER PILE WALL I ELEVATION**

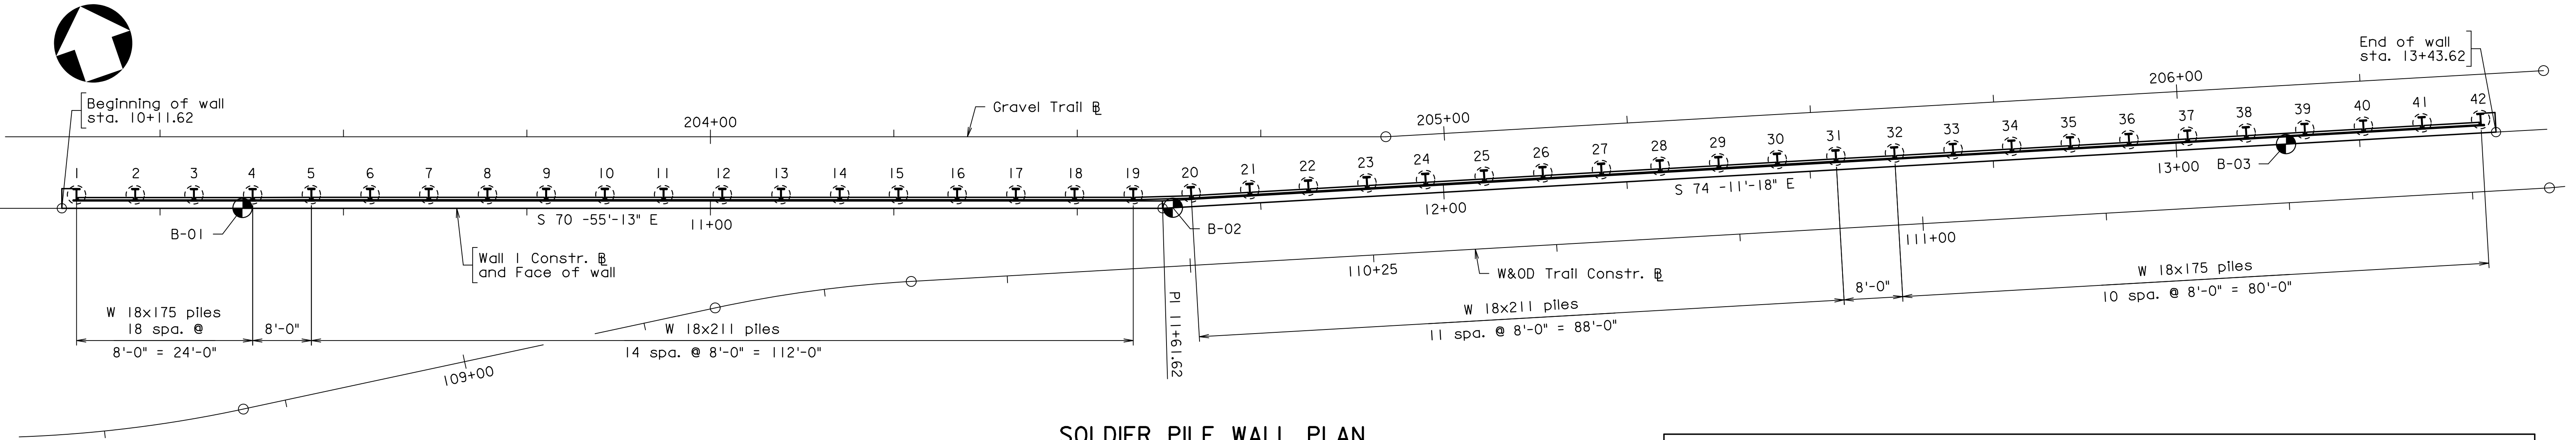Scale:  $\frac{1}{8}" = 1'-0"$






PROJECT MANAGER: SCOTT J. BUFFNER, P.E. (703) 877-5236  
SURVEYED BY, DATE: FAIRFAX COUNTY  
DESIGN BY: WHITMAN, REQUARDT & ASSOCIATES, LLP (703) 293-9717  
SUBSURFACE UTILITY BY, DATE: SO DEEP, INC. (703) 361-6005 December 23, 2014



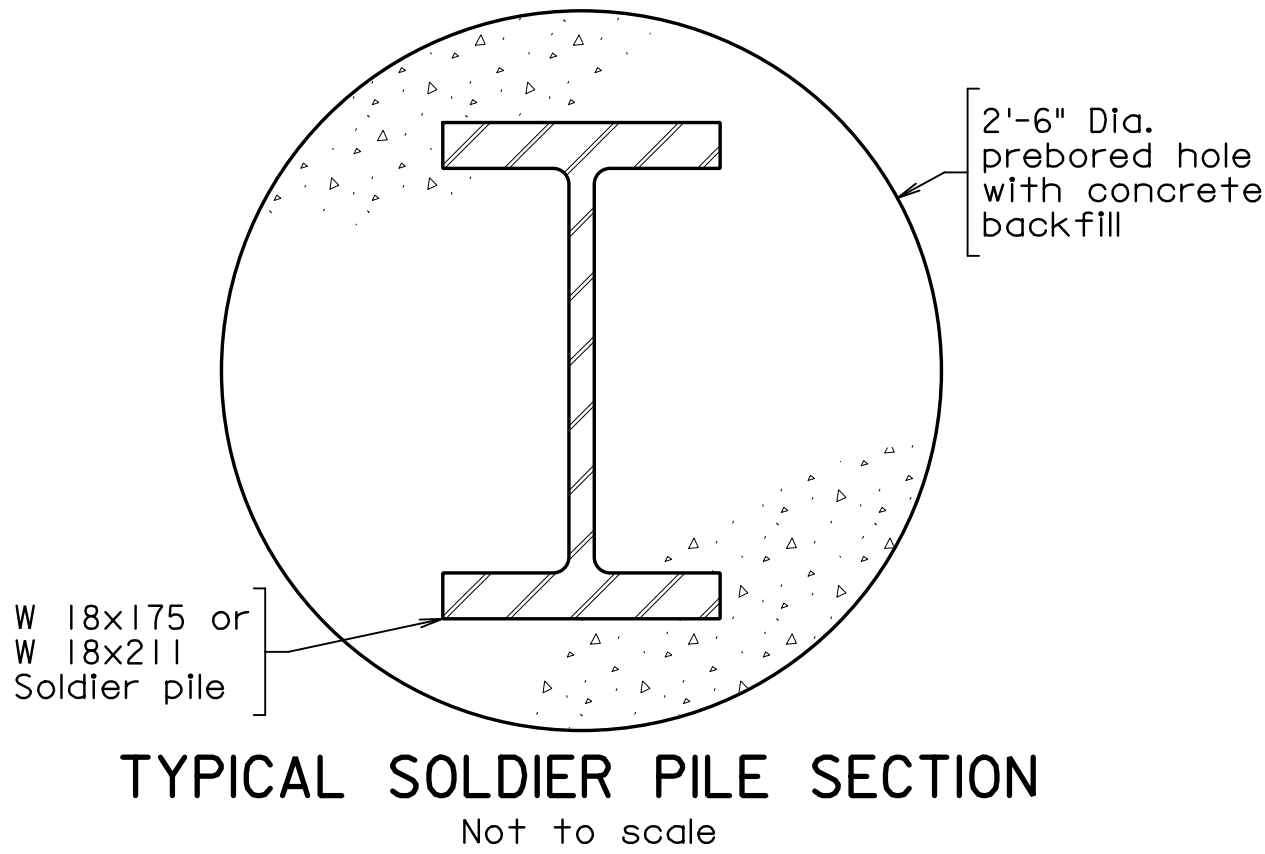SOLDIER PILE WALL PLAN  
Scale: 3/32" = 1'-0"



WALL 1 SUGGESTED SEQUENCE OF CONSTRUCTION AND GENERAL REQUIREMENTS:

- Clear and grub the area for the wall construction, taking care not to extend beyond established limits of disturbance or designated save areas
- Place all erosion and sediment perimeter controls in accordance with the approved erosion and sediment control plan. These controls shall remain in place and be continuously maintained during all construction.
- Grade a bench along the proposed wall alignment wide enough to accommodate the drilling equipment required to install the prebored holes and soldier piles for the retaining wall.
- Once the area has been prepared for the drilling of the prebored holes the Contractor may proceed with the drilling operation.
- The prebored holes shall be drilled as indicated in the plans. The hole may require a temporary casing to keep it open until the hole is poured. If used, casing shall be removed during the pouring operation.
- Once the prebored hole is drilled, the Contractor shall place the pile inside the prebored hole and prepare the hole for pouring of the concrete. Particular attention must be given to the placement of the pile to insure that the alignment of the proposed wall is maintained.
- The concrete and flowable backfill shall be placed in one continuous operation in accordance with the plans and Specifications. Concrete shall be placed to the bottom of 6" leveling pads and flowable backfill placed above that elevation.
- Once the prebored hole and soldier pile is placed, the Contractor shall exercise extreme care so as not to damage the pile or prebored hole. Any damage shall be repaired to the satisfaction of the Engineer at the sole expense of the Contractor.
- The flowable fill placed around piles shall be excavated as needed to accommodate the permanent wood lagging boards.
- The wall shall be constructed in a top down manner to continually support the earth and roadway adjacent to the wall. For no reason shall an open unsupported excavation face be left unprotected.
- Fill any voids behind the timber lagging with #68 stone backfill.
- All excavation material shall be removed to an approved stockpile or disposal site.
- If necessary, the top of the soldier piles shall be cut off to proper elevation prior to the placing of form work for the wall facing. Any piles damaged by the Contractor during the operation shall be repaired and/or replaced to the satisfaction of the Engineer at the Contractor's expense.
- Prior to placing the cast-in-place wall facing, the leveling pad shall be installed to provide a level working surface for the support of the form work and wall facing.
- Weld 6" studs to front of soldier piles if not already in place.
- Install geocomposite wall drain and reinforcing steel for cast-in-place wall facing.
- The cast-in-place wall facing shall be placed in one vertical pour from the top of concrete leveling pad to the bottom of the concrete coping. No horizontal joints will be allowed. The only vertical construction joints allowed along the length of the wall will be those located at the expansion or contraction joints. No other vertical joints will be allowed. Aesthetic treatment of wall face shall be in accordance with special provisions and approved patterns, materials, and procedures.
- The Contractor may cast the wall coping separately to the finished line and grade shown.
- Complete final grading in front of and behind wall. Extreme care shall be taken so not ot damage the concrete wall construction.

SOLDIER PILE LOCATION DATA							
Soldier Pile No.	Station	Offset	Bottom Tip Elev.	Soldier Pile No.	Station	Offset	Bottom Tip Elev.
1	10+13.62	1.84 Lt.	371.5	22	11+81.62	1.86 Lt.	358.5
2	10+21.62	1.84 Lt.	370.0	23	11+89.62	1.86 Lt.	358.5
3	10+29.62	1.84 Lt.	368.5	24	11+97.62	1.86 Lt.	358.5
4	10+37.62	1.84 Lt.	367.5	25	12+05.62	1.86 Lt.	358.5
5	10+45.62	1.86 Lt.	359.0	26	12+13.62	1.86 Lt.	359.5
6	10+53.62	1.86 Lt.	359.0	27	12+21.62	1.86 Lt.	359.5
7	10+61.62	1.86 Lt.	357.0	28	12+29.62	1.86 Lt.	359.5
8	10+69.62	1.86 Lt.	357.0	29	12+37.62	1.86 Lt.	360.5
9	10+77.62	1.86 Lt.	357.0	30	12+45.62	1.86 Lt.	360.5
10	10+85.62	1.86 Lt.	356.0	31	12+53.62	1.86 Lt.	360.5
11	10+93.62	1.86 Lt.	356.0	32	12+61.62	1.84 Lt.	366.5
12	11+01.62	1.86 Lt.	356.0	33	12+69.62	1.84 Lt.	366.5
13	11+09.62	1.86 Lt.	356.0	34	12+77.62	1.84 Lt.	366.5
14	11+17.62	1.86 Lt.	356.0	35	12+85.62	1.84 Lt.	367.5
15	11+25.62	1.86 Lt.	356.0	36	12+93.62	1.84 Lt.	367.5
16	11+33.62	1.86 Lt.	356.0	37	13+01.62	1.84 Lt.	368.5
17	11+41.62	1.86 Lt.	356.0	38	13+09.62	1.84 Lt.	368.5
18	11+49.62	1.86 Lt.	356.0	39	13+17.62	1.84 Lt.	368.5
19	11+57.62	1.86 Lt.	356.0	40	13+25.62	1.84 Lt.	369.5
20	11+65.62	1.86 Lt.	356.0	41	13+33.62	1.84 Lt.	369.5
21	11+73.62	1.86 Lt.	358.5	42	13+41.62	1.84 Lt.	370.5

Notes:

For boring log, see sheets 10(5) and 10(6). Boring locations are approximate.

For geometric details of wall and trial baselines, see sheet 1F(2).

For details of nearby drainage elements, see sheet 3.

For soldier pile wall typical sections and details, see sheet 10(3).

LEGEND:


Indicates approximate location of boring.

PREFINAL PLANS			
EMERGENCY POLICE - FIRE - RESCUE 911			
FAIRFAX COUNTY, VIRGINIA			
DEPARTMENT OF PUBLIC WORKS AND ENVIRONMENTAL SERVICES			
12000 GOVERNMENT CENTER PARKWAY, SUITE 449 FAIRFAX, VA., 22035-0052			
OFFICE OF CAPITAL FACILITIES 703-324-5800			
WIEHLE AVENUE (RTE 828) AT W&OD TRAIL			
SOLDIER PILE WALL PLAN AND			
SUGGESTED SEQUENCE OF CONSTRUCTION			
PROJECT NO: 1400102-2013			
PLAN NO. XXX-XX		DESIGNED: WRA DRAFTED: WRA CHECKED: WRA	
SHEET 10(2)		FUND # 500-C5000	
WHITMAN REQUARDT & ASSOCIATES RICHMOND, VA STRUCTURAL ENGINEER		APPROVED BY THE TRANSPORTATION DESIGN DIVISION	


THESE PLANS ARE UNFINISHED AND UNAPPROVED AND ARE NOT TO BE USED FOR ANY TYPE OF CONSTRUCTION.



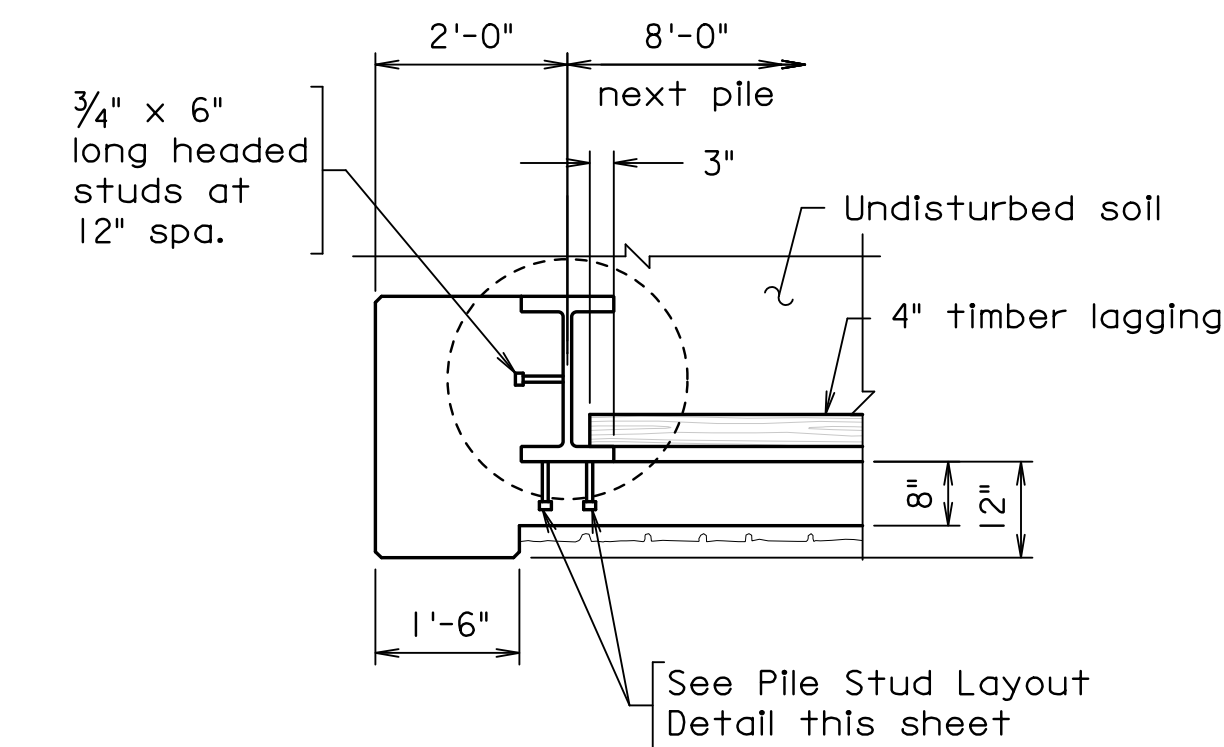PROJECT MANAGER, SCOTT RUFFNER, P.E. (703) 877-5736-----  
SURVEYED BY, DATE FAIRFAX COUNTY-----  
DESIGN BY WHITMAN, REQUARDT & ASSOCIATES, LLP (703) 293-9717-----  
SUBSURFACE UTILITY BY, DATE SO DEEP, INC. (703) 361-6005 December 23, 2014-----




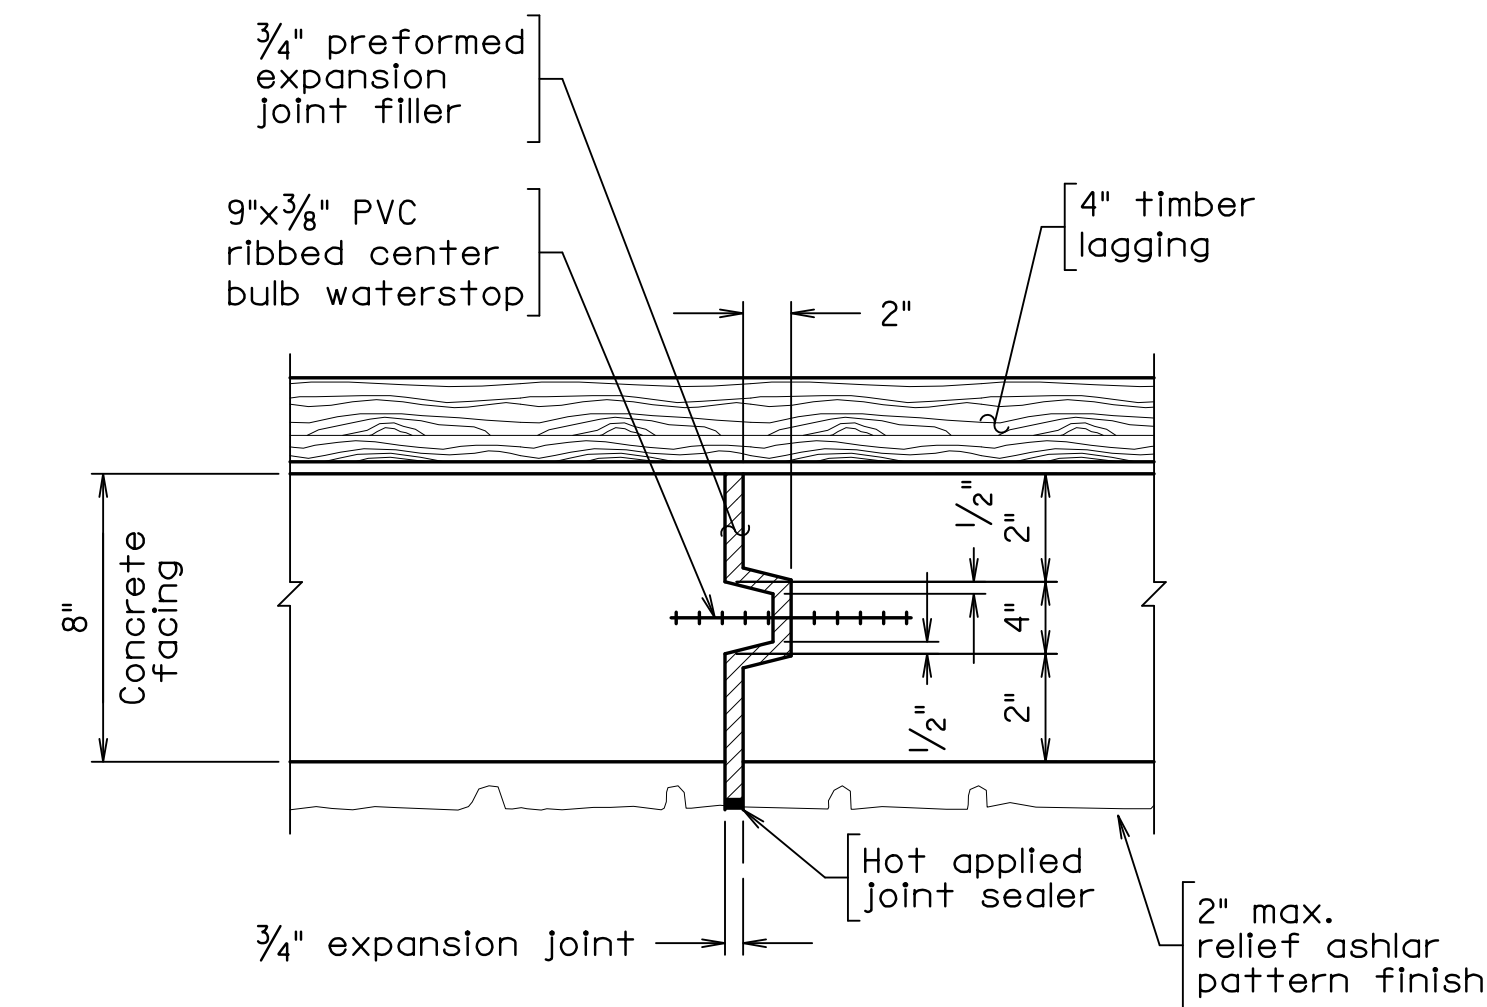TYPICAL PART PLAN END TREATMENT  
Scale: 1/2" = 1'-0"  
End of wall shown, beginning of wall similar opposite hand.




TYPICAL EXPANSION JOINT DETAIL  
IN CAST-IN-PLACE CONCRETE FACING PLAN

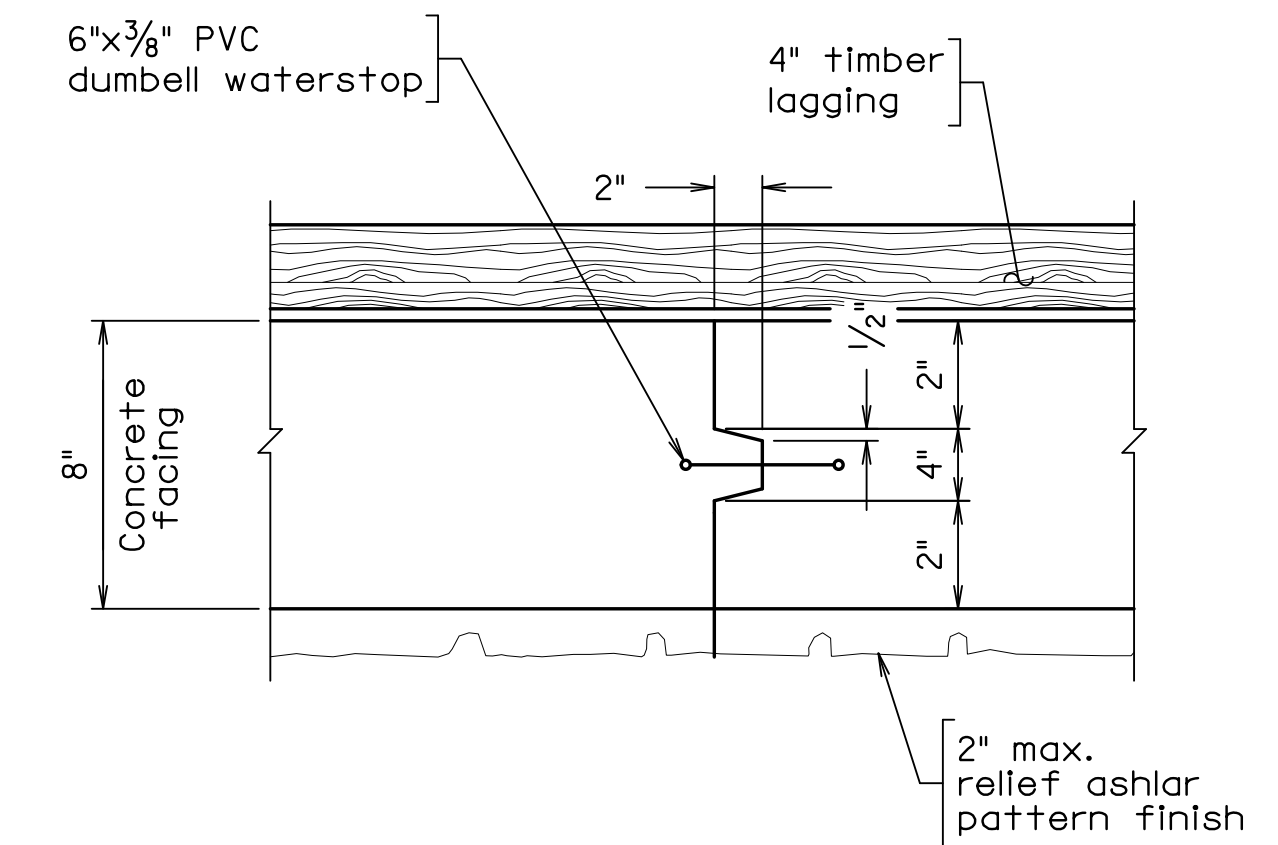
Not to Scale



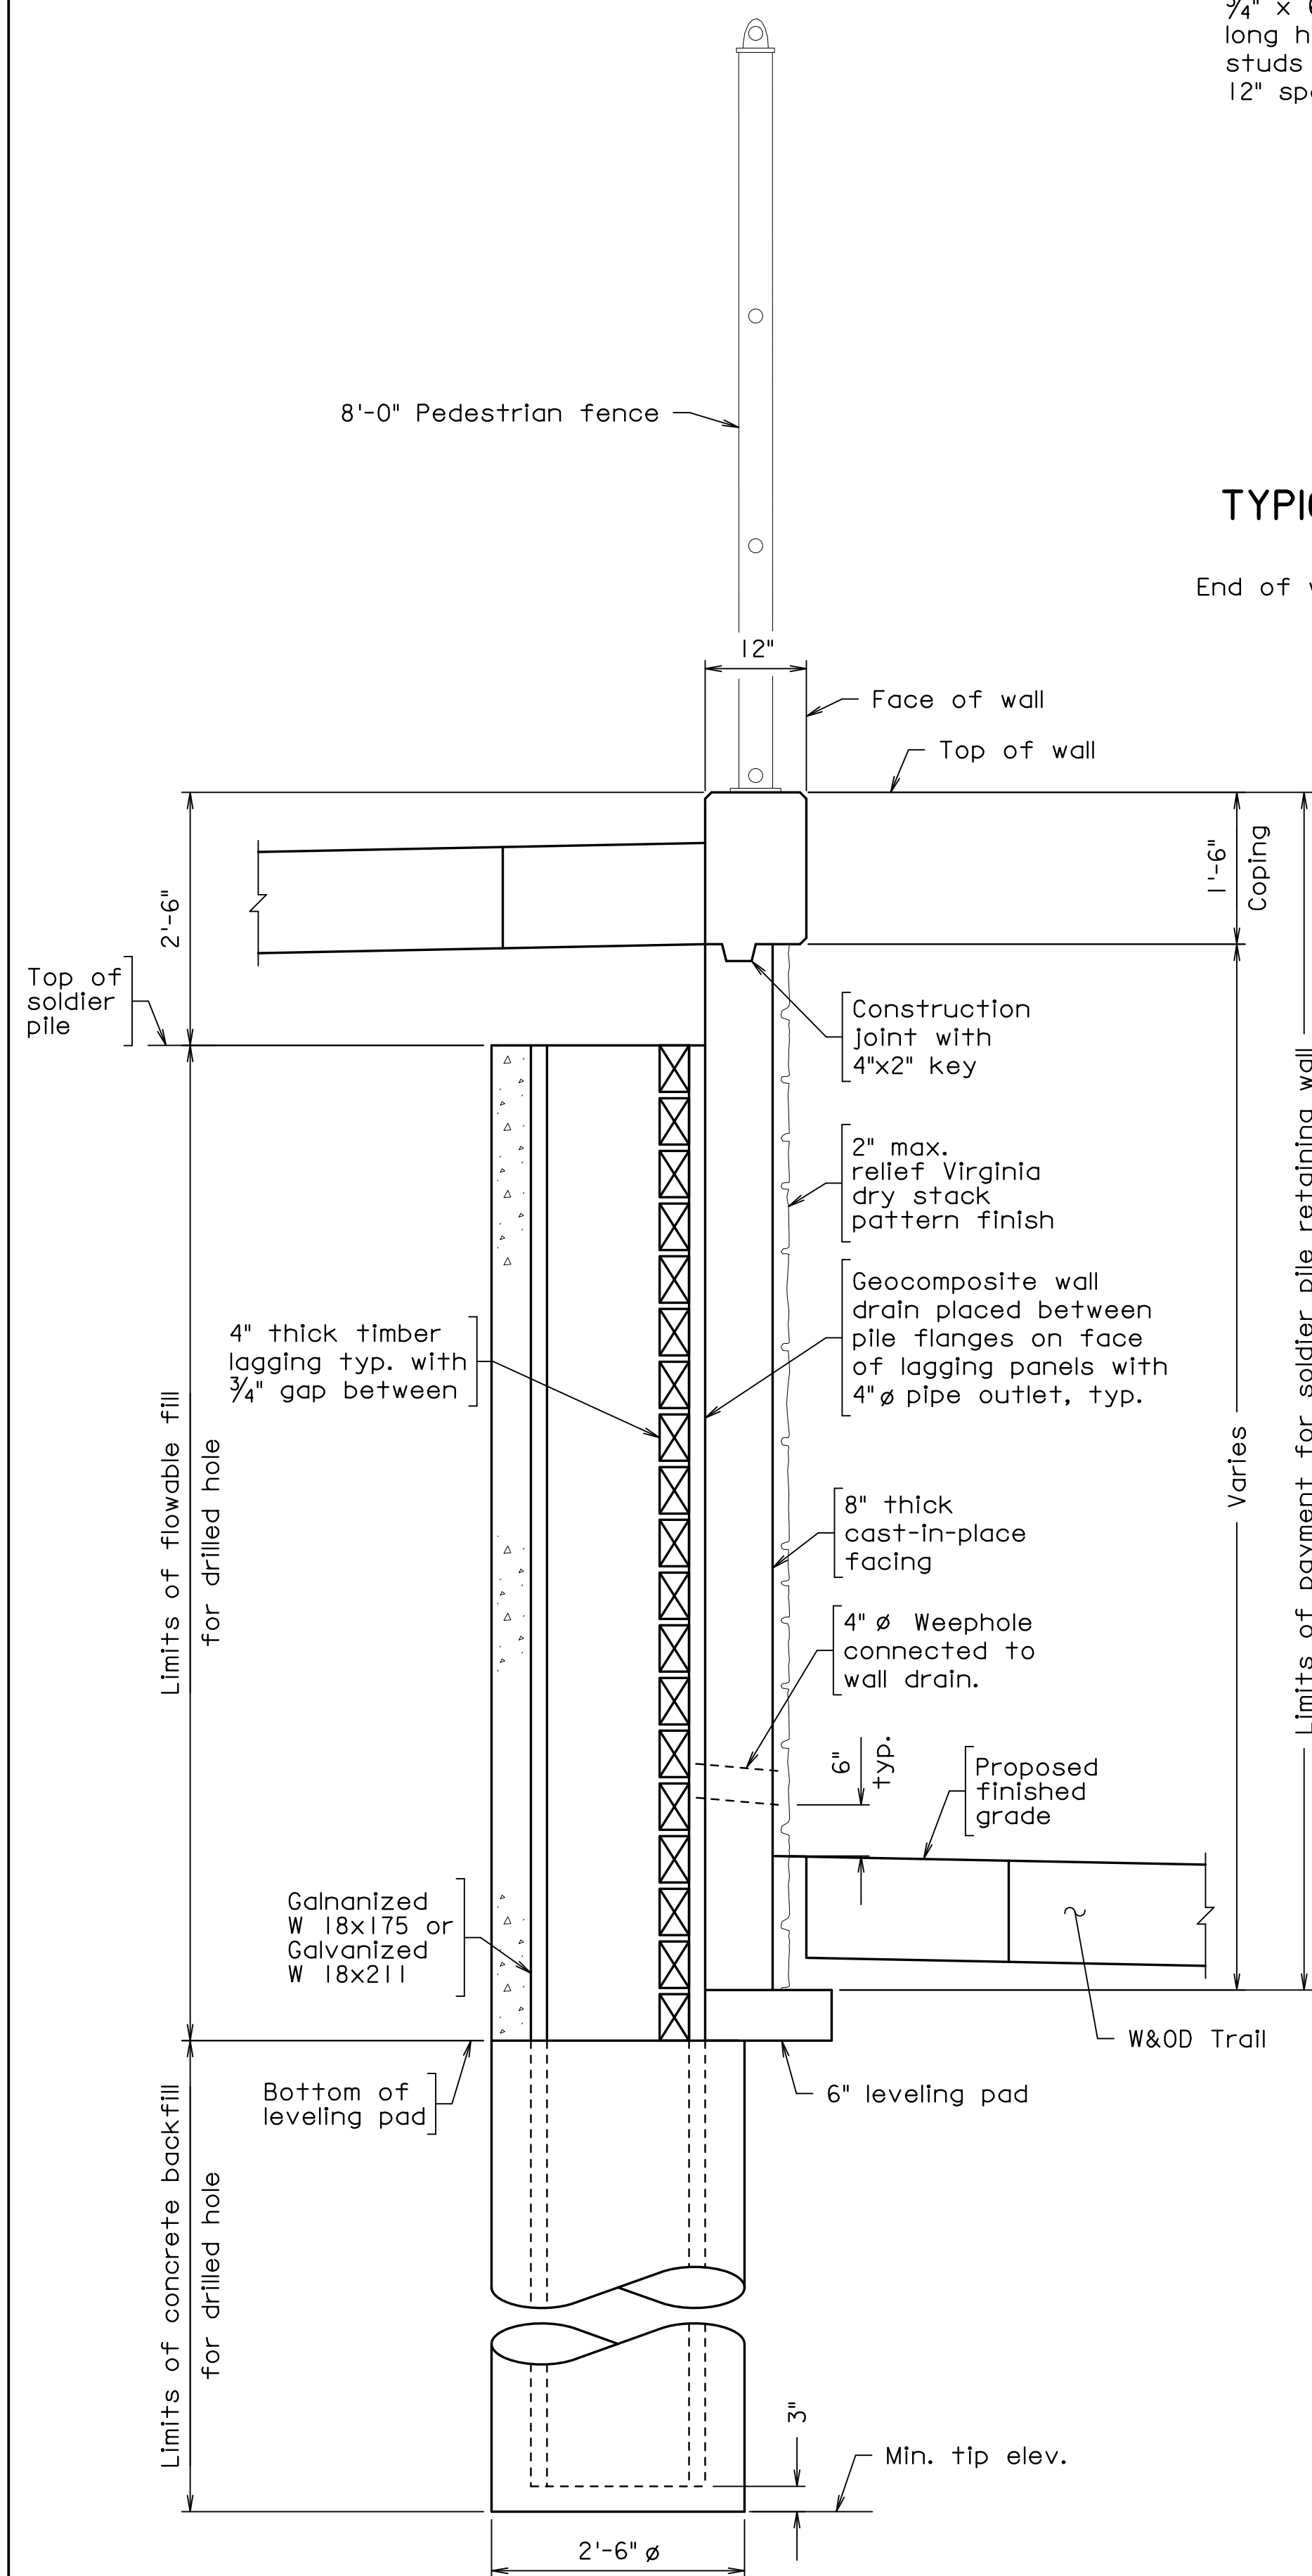
TYPICAL CONTRACTION JOINT DETAIL  
IN CAST-IN-PLACE CONCRETE FACING PLAN  
Not to Scale



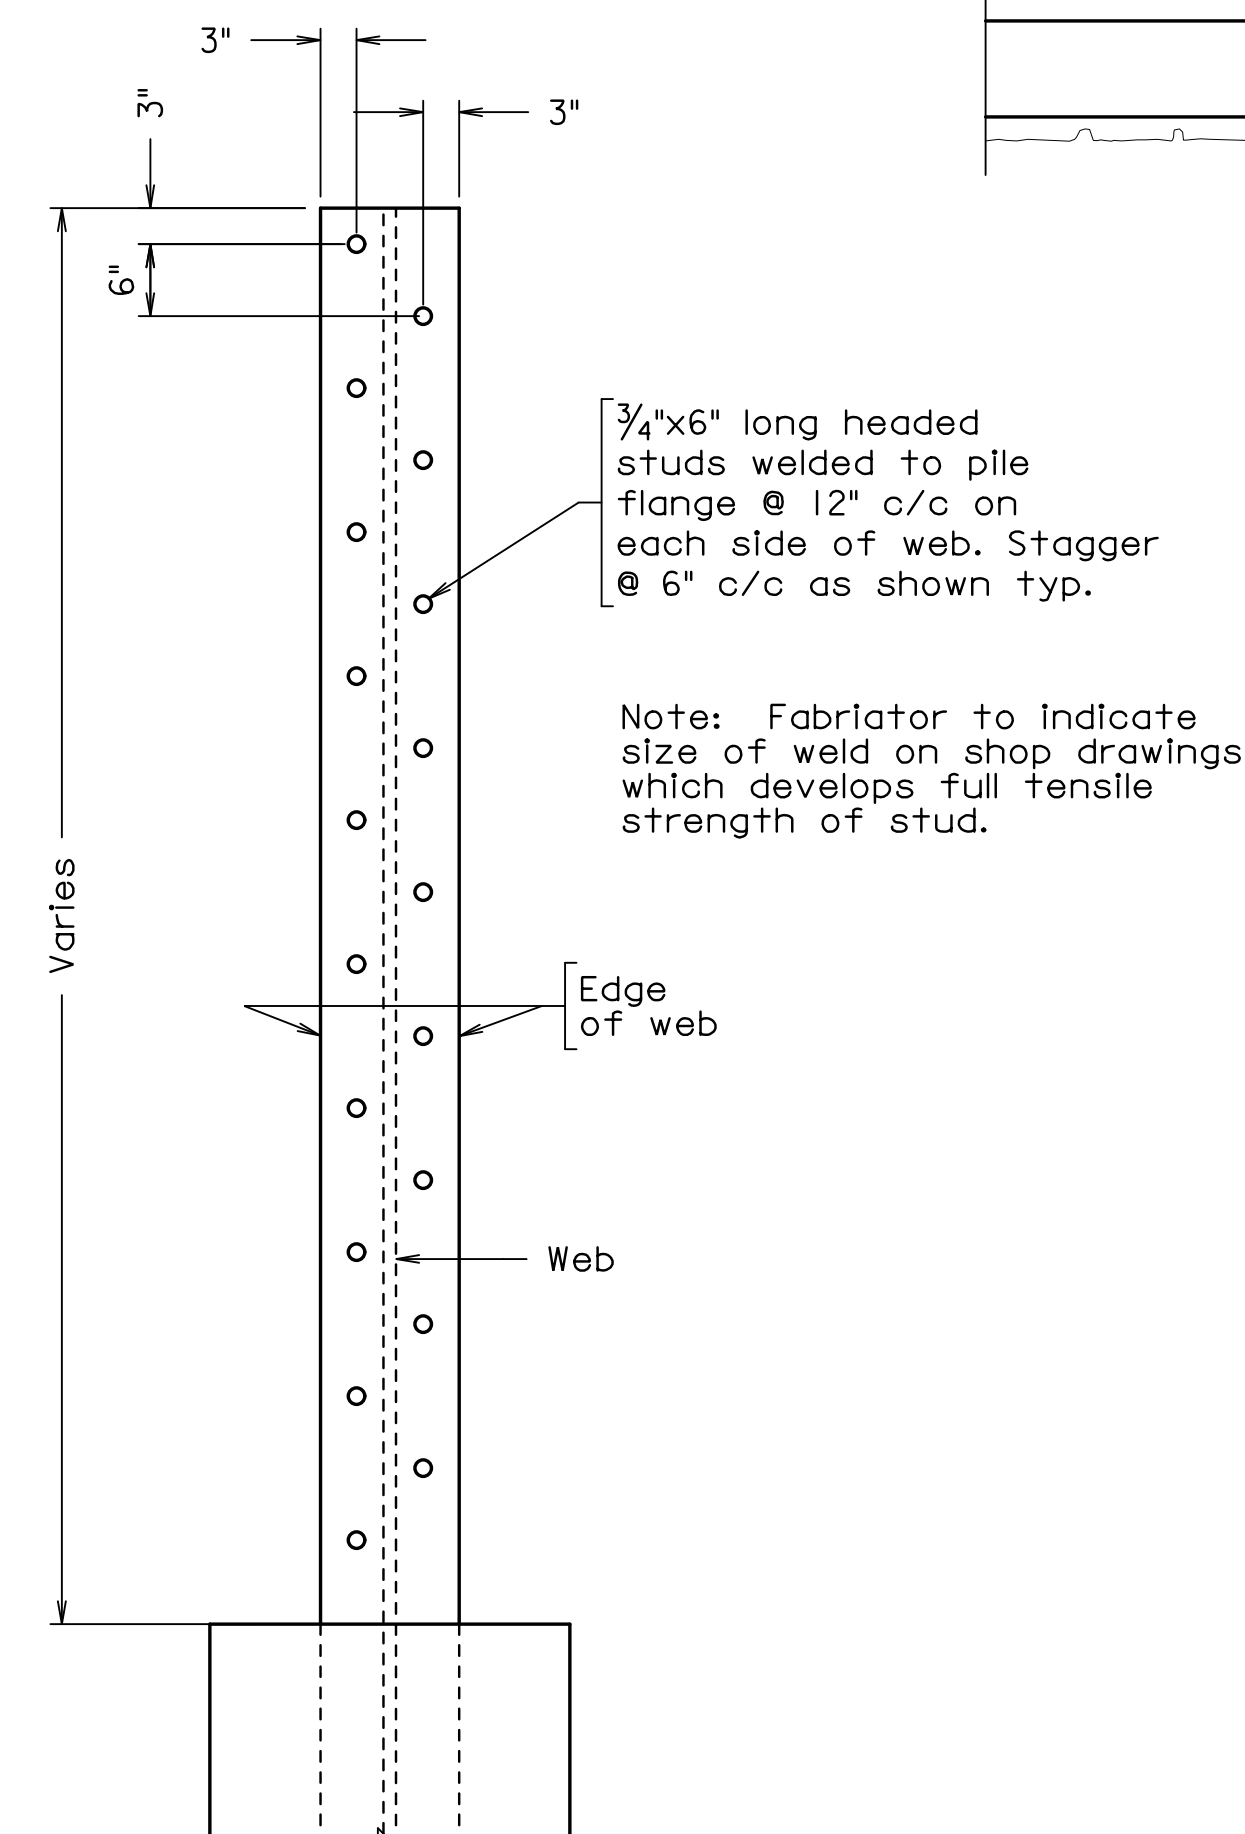
TYPICAL PILE WALL SECTION  
WALL 1  
Scale:  $\frac{3}{4}" = 1'-0"$



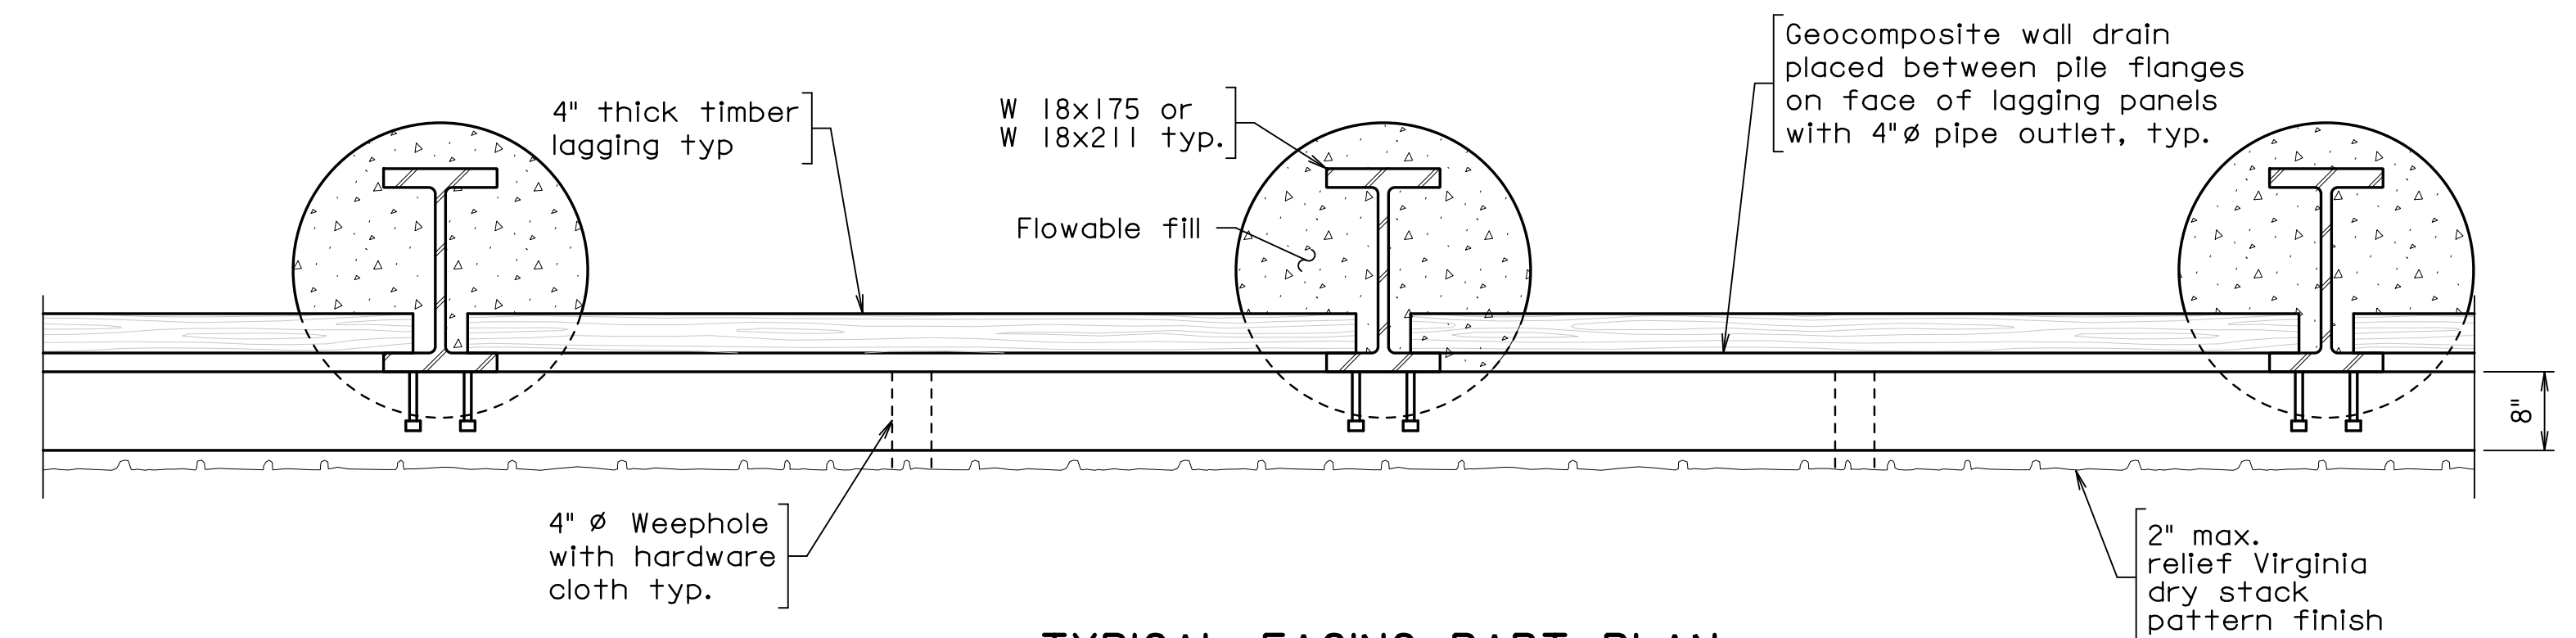TYPICAL PILE STUD LAYOUT DETAIL  
Not to scale



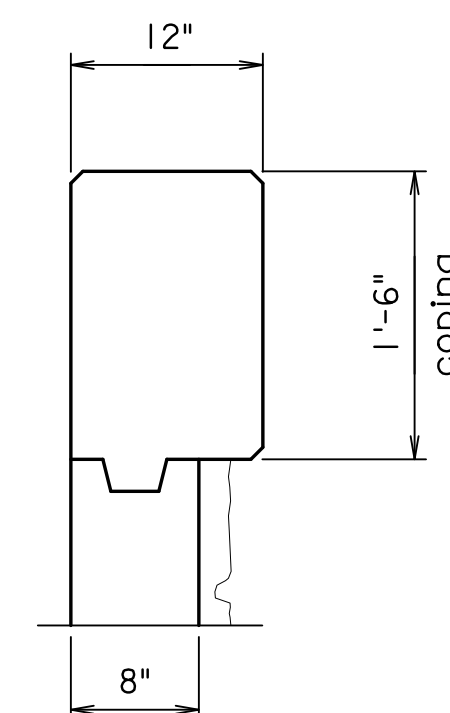TYPICAL FACING PART PLAN  
Scale:  $\frac{3}{4}" = 1'-0"$



COPING DETAIL  
Scale: 1" = 1'-0"



<div style="border: 1px solid black; padding: 5px; text-align: center;">         PREFINAL PLANS       </div>									
<b>EMERGENCY POLICE - FIRE - RESCUE 911</b>									
<b>FAIRFAX COUNTY, VIRGINIA</b> <b>DEPARTMENT OF PUBLIC WORKS AND ENVIRONMENTAL SERVICES</b> <b>12000 GOVERNMENT CENTER PARKWAY, SUITE 449 FAIRFAX, VA., 22035-0052</b>									
R E V I S I O N S						<b>OFFICE OF CAPITAL FACILITIES</b> <b>703-324-5800</b>			
						<b>WIEHLE AVENUE (RTE 828) AT W&amp;OD TRAIL</b> <b>TYPICAL SECTION AND</b> <b>WALL DETAILS</b>			
						<b>PROJECT NO: 1400102-2013</b>			
						<b>PLAN NO.</b> <b>XXX-XX</b>	<b>DESIGNED: WRA</b> <b>DRAFTED: WRA</b> <b>CHECKED: WRA</b>	<b>SHEET</b> <b>10(3)</b>	
						<b>APPROVED BY THE TRANSPORTATION DESIGN DIVISION</b>			

THESE PLANS ARE UNFINISHED AND UNAPPROVED AND ARE NOT TO BE USED FOR ANY TYPE OF CONSTRUCTION.



PROJECT MANAGER: SCOTT, BUFFNER, P.E., (703) 287-5236  
SURVEYED BY, DATE: FAIRFAX COUNTY  
DESIGN BY: WHITMAN, REQUARDT & ASSOCIATES, LLP, (703) 293-9717  
SUBSURFACE UTILITY BY, DATE: SO DEEP, INC., (703) 361-6005, December 23, 2014

STATE	ROUTE	FEDERAL AID	ROUTE	STATE
		PROJECT		PROJECT
VA.	—	—	828	0828-029-248, B-601

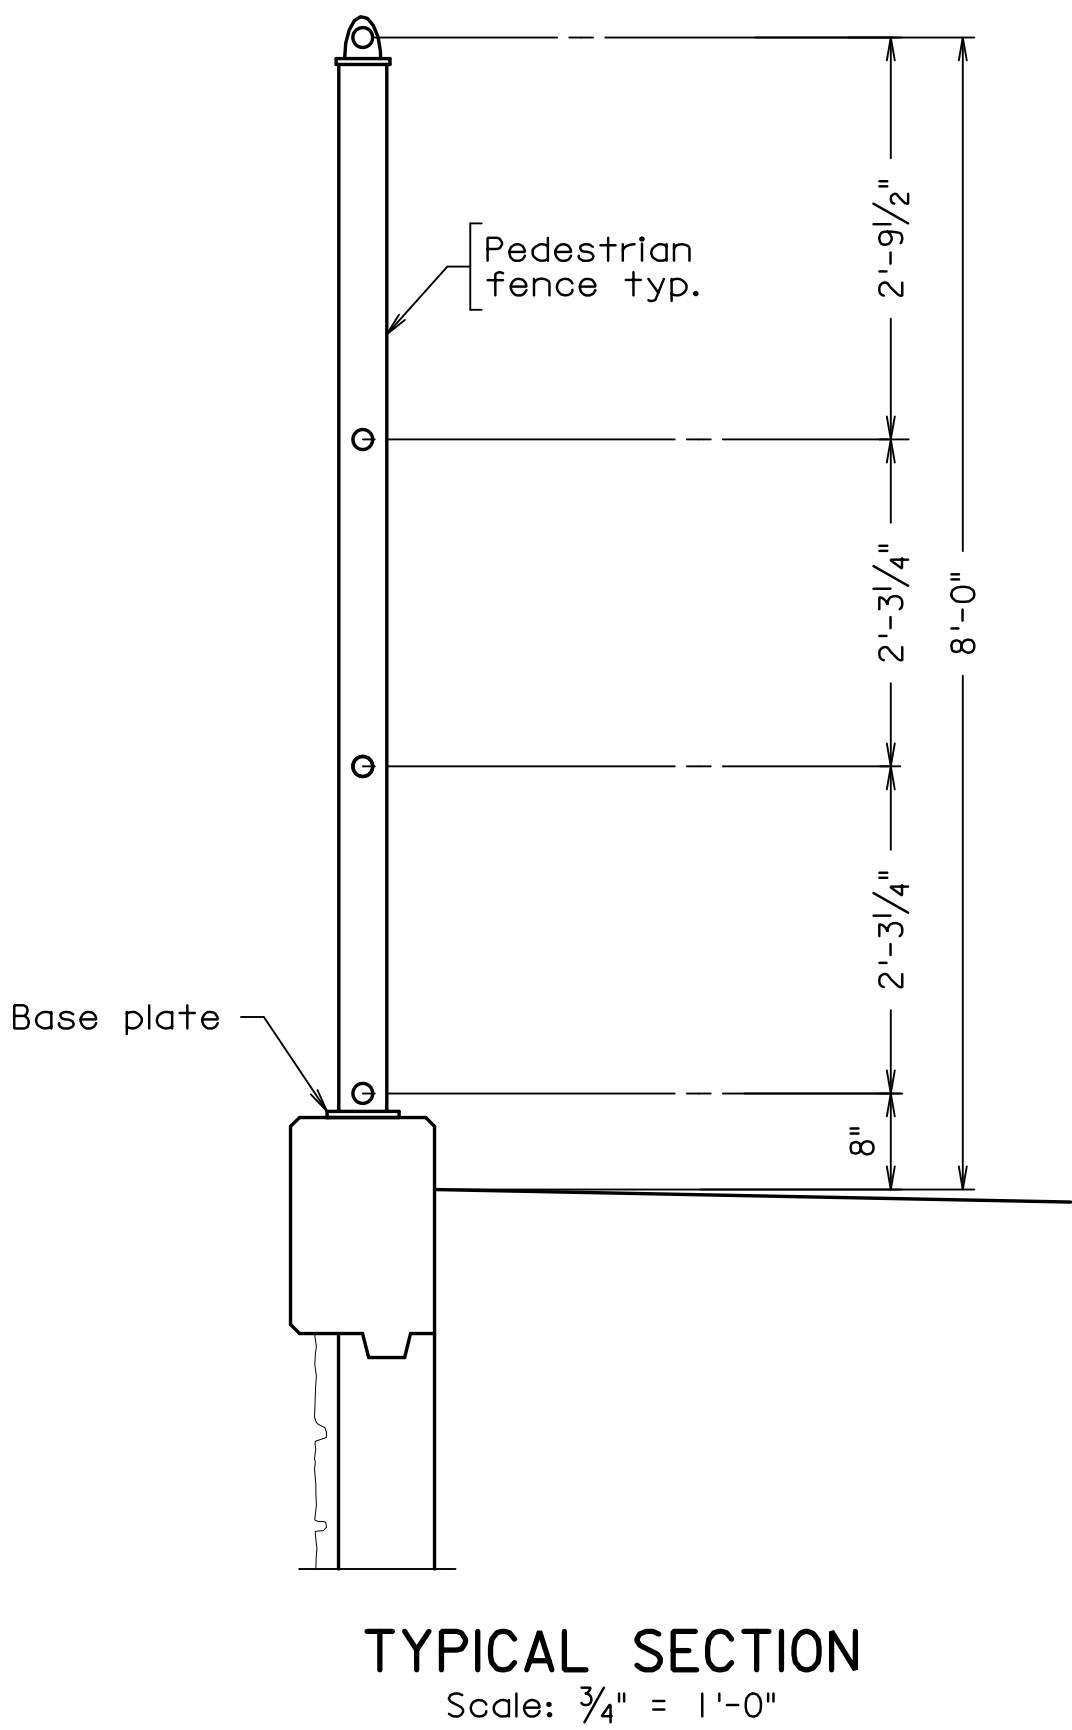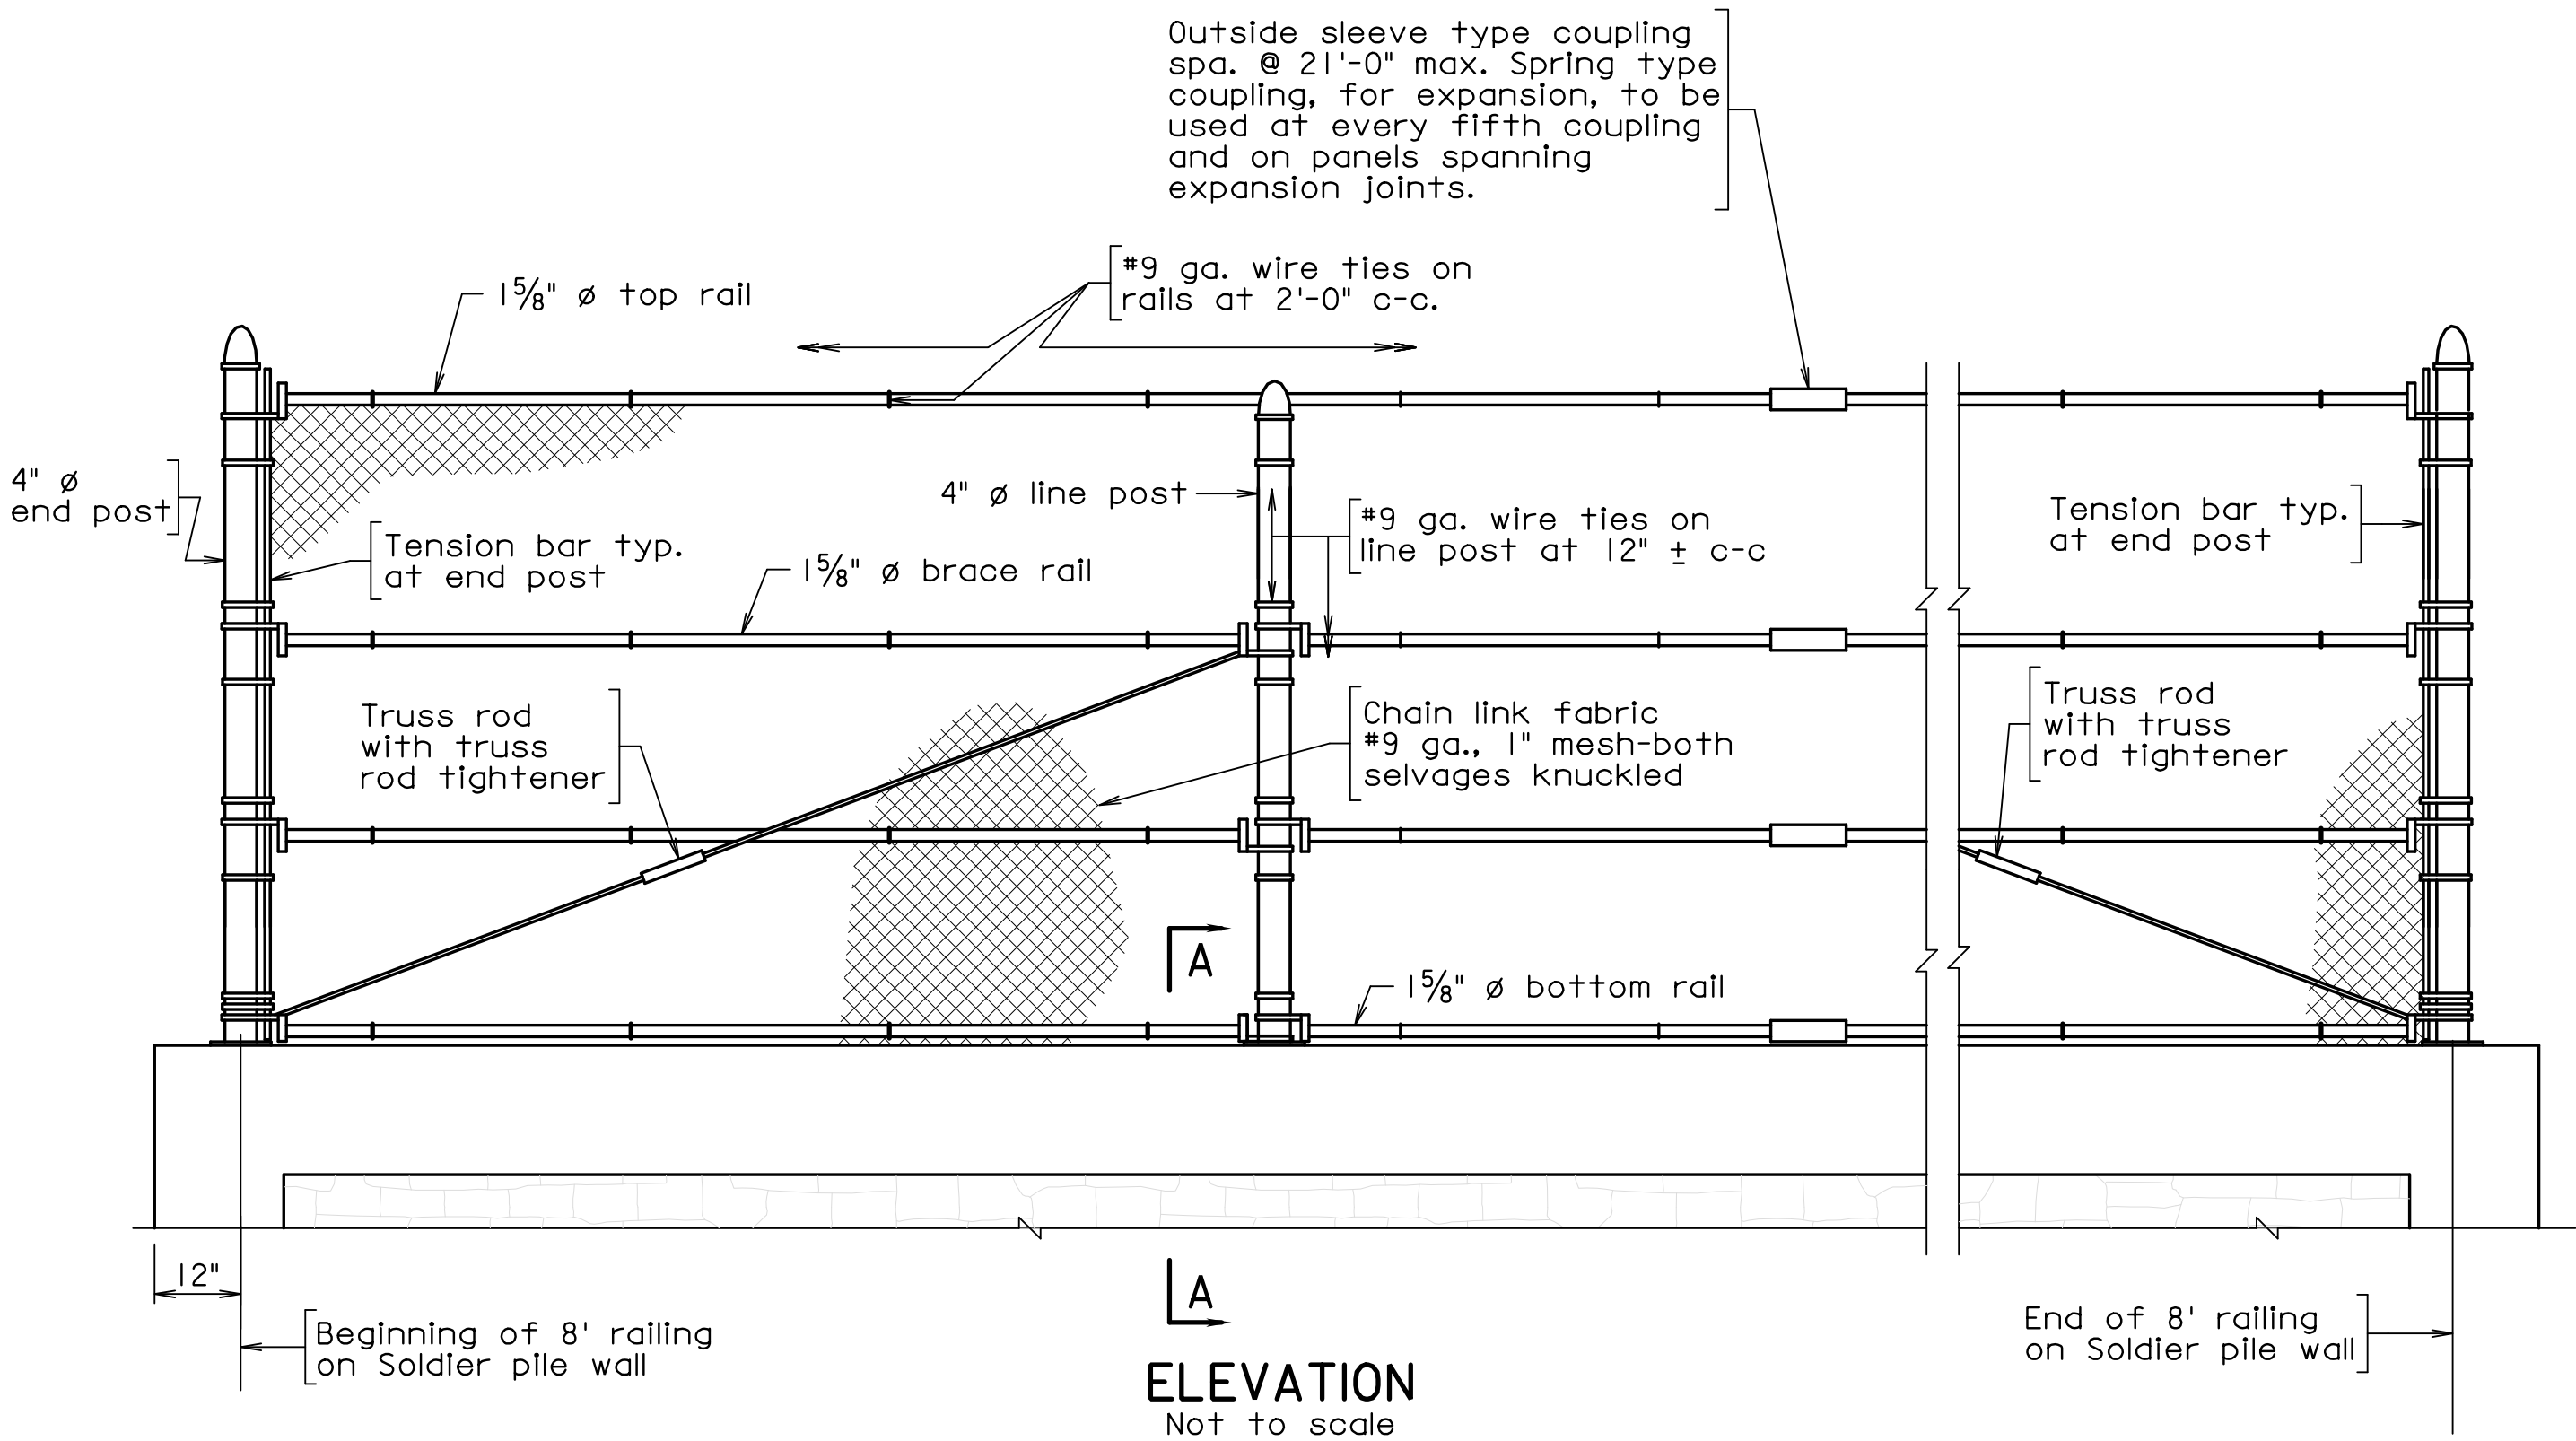

Notes:

The fence to be used on the Soldier pile wall shall be 8'-0" as shown in Typical Section.

Posts shall be set vertical. Rails shall be set parallel to the top of base of railing.

Spacing of posts to be equally spaced. Maximum spacing of posts shall not exceed 10'-0".

Chain link fabric shall be placed on inside of posts and rails.

Chain link fabric, posts, rails, bolts excluding threads, and other associated hardware shall be black vinyl coated.

Threaded inserts and bolt threads shall not be galvanized or coated.

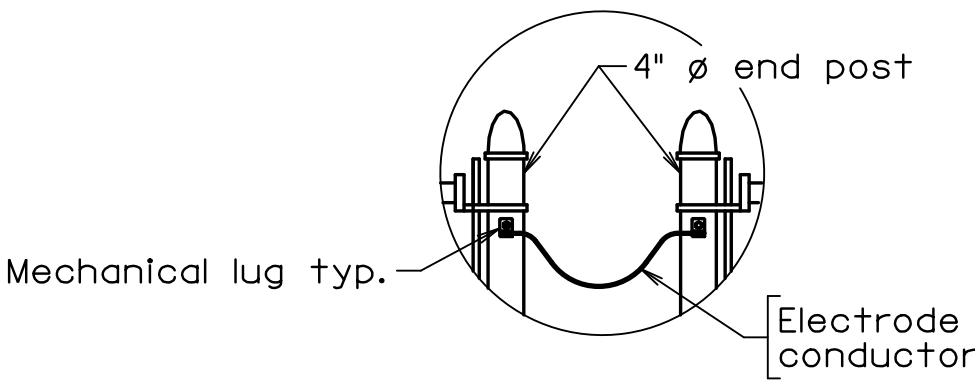
Ends of wire ties shall be turned to outside of fence to prevent injury to pedestrians.

Threaded inserts, when embedded as shown, shall develop full strength of threaded bolts. Embedment of insert per manufacturers recommendations or 5" whichever is greater.


All bolts shall be high strength (ASTM A325).

All welded or seamless steel galvanized pipe shall conform to ASTM F1083, Schedule 40.


Fence framing (posts and railing) shall be grounded in accordance with Section 507.



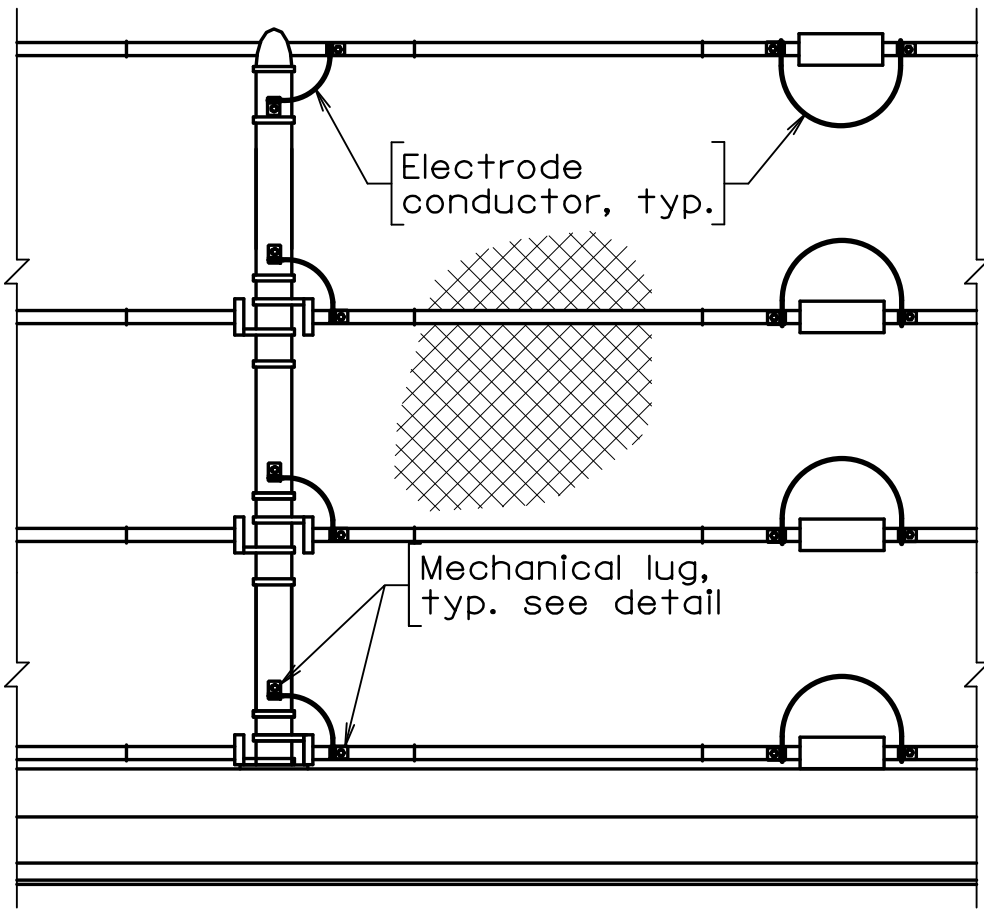
**ELECTRICAL CONTINUITY**  
(On Open Joint)  
Not to scale



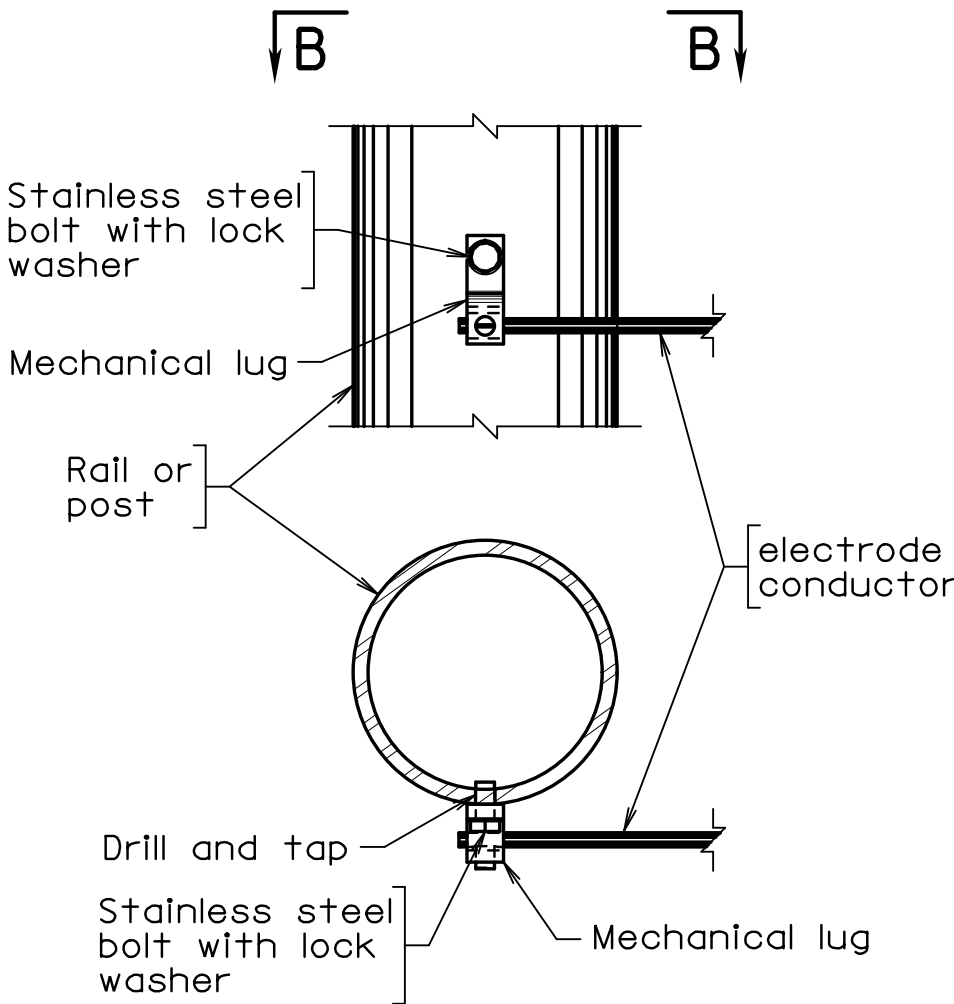
**ELECTRICAL CONTINUITY**  
FOR VINYL COATED STEEL PEDESTRIAN FENCE  
(Installed on the non-traffic side of the fence)  
Not to scale



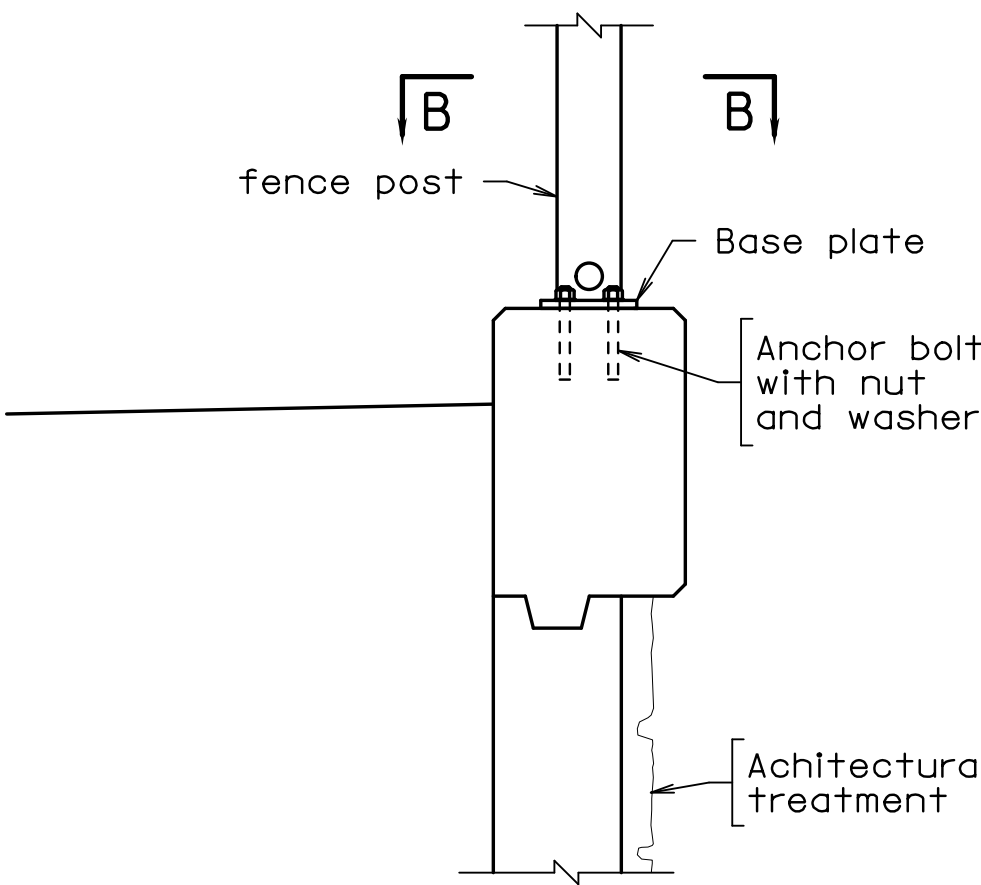**SECTION B-B**  
**MECHANICAL LUG DETAIL**  
Not to scale



**SECTION A-A**  
Scale: 1" = 1'-0"

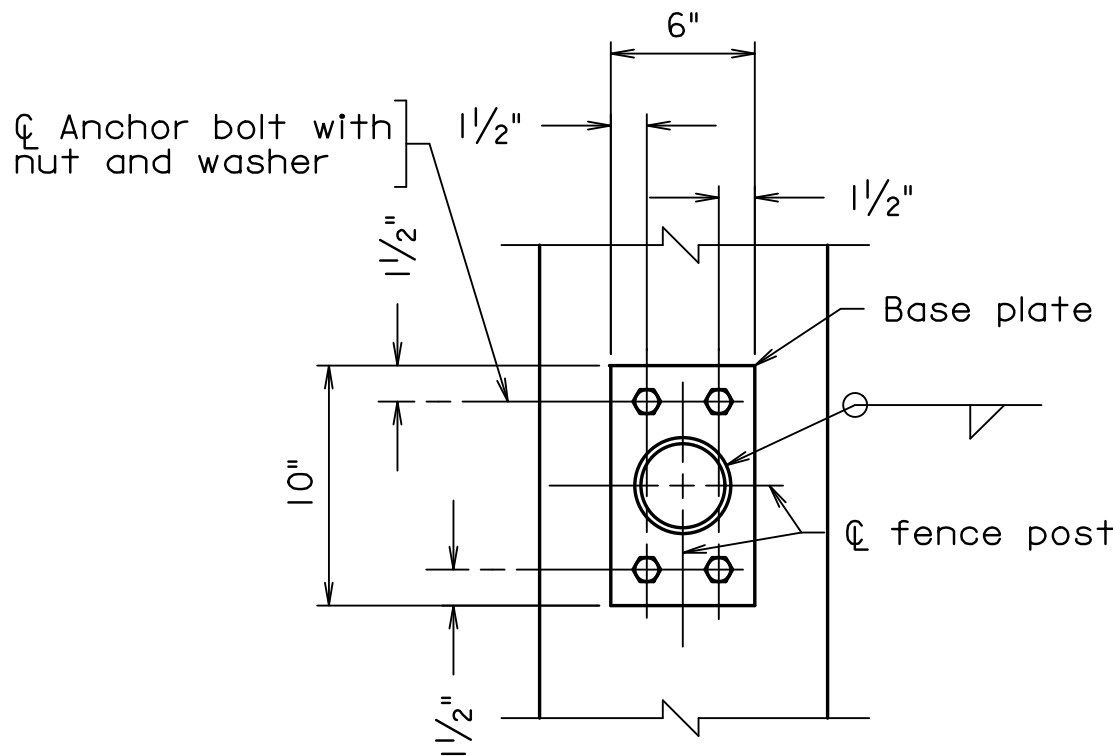

**VIEW B-B**  
Scale: 1 1/2" = 1'

Scale as noted.

PREFINAL PLANS


EMERGENCY POLICE - FIRE - RESCUE 911					
FAIRFAX COUNTY, VIRGINIA					
DEPARTMENT OF PUBLIC WORKS AND ENVIRONMENTAL SERVICES					
12000 GOVERNMENT CENTER PARKWAY, SUITE 449 FAIRFAX, VA., 22035-0052					
R E V I S I O N S					OFFICE OF CAPITAL FACILITIES 703-324-5800
					WIEHLE AVENUE (RTE 828) AT W&OD TRAIL 8' PEDESTRIAN FENCE DETAILS ON SOLDIER PILE WALL
					PROJECT NO: 1400102-2013
					PLAN NO. XXX-XX
					DESIGNED: JRM DRAFTED: CRR CHECKED: TAB
APPROVED BY THE TRANSPORTATION DESIGN DIVISION				SHEET 10(4)	
FUND # 500-C5000					


THESE PLANS ARE UNFINISHED AND UNAPPROVED AND ARE NOT TO BE USED FOR ANY TYPE OF CONSTRUCTION.




PROJECT MANAGER: SCOTT, BUFFNER, P.E., (703) 287-5236  
SURVEYED BY, DATE: FAIRFAX COUNTY  
DESIGN BY: WHITMAN, REQUARDT & ASSOCIATES, LLP, (703) 293-9717  
SUBSURFACE UTILITY BY, DATE: SO DEEP, INC., (703) 366-6005, December 23, 2014

STATE	FEDERAL AID		STATE	
	ROUTE	PROJECT	ROUTE	PROJECT
VA.	---	---	828	0828-029-248, B-60 I

 Virginia Department of Transportation										PROJECT #: 45494-027 LOCATION: W&OD Trail over Wiehle Avenue STRUCTURE: TRAIL				B-01 PAGE 1 OF 1	
STATION: 10874.79 NORTHING: 7031532.44 ft SURFACE ELEVATION: 386.0 ft										OFFSET: 26.82 ft LT Easting: 11813377.91 ft COORD. DATUM: VA North					
Date(s) Drilled: 10/24/2016 - 10/24/2016 Drilling Method(s): HSA SPT Method: Automatic Hammer Other Test(s): Driller: Raymond Logger: G Koepping										LAB DATA					
FIELD DATA										GROUND WATER					
FIELD DESCRIPTION OF STRATA										LL PI					
0.0 / 386.0 Gray, fine to coarse SAND with Silt, dry SM															
1.5 / 384.5 Orange, Clayey SILT with mica, dry ML															
5.0 / 381.0 Light orange, foliated, SILT with little fine Sand, dry ML															
13.5 / 372.5 Gray/brown, mottled, Clayey SILT, dry ML															
REMARKS: Rig Type: CME-45C-2 Truck Rig.										PAGE 1 OF 1 B-01					

 Virginia Department of Transportation										PROJECT #: 45494-027 LOCATION: W&OD Trail over Wiehle Avenue STRUCTURE: TRAIL				B-02 PAGE 1 OF 1	
STATION: 10996.96 NORTHING: 7031491.33 ft SURFACE ELEVATION: 389.0 ft										OFFSET: 8.00 ft LT Easting: 11813496.67 ft COORD. DATUM: VA North					
Date(s) Drilled: 10/24/2016 - 10/24/2016 Drilling Method(s): HSA SPT Method: Automatic Hammer Other Test(s): Driller: Raymond Logger: G Koepping										LAB DATA					
FIELD DATA										GROUND WATER					
FIELD DESCRIPTION OF STRATA										LL PI					
0.0 / 389.0 Orange/brown, Silty CLAY, dry CL-ML															
2.5 / 386.5 Tan, SILT with mica, dry ML															
8.5 / 380.5 Gray, brown, layered, Clayey SILT, dry ML										7.3 62.0					
REMARKS: Rig Type: CME-45C-2 Truck Rig.										PAGE 1 OF 1 B-02					

 Virginia Department of Transportation										PROJECT #: 45494-027 LOCATION: W&OD Trail over Wiehle Avenue STRUCTURE: TRAIL				B-03 PAGE 1 OF 1	
STATION: 11150.00 NORTHING: 7031449.63 ft SURFACE ELEVATION: 388.0 ft										OFFSET: 8.00 ft LT Easting: 11813643.92 ft COORD. DATUM: VA North					
Date(s) Drilled: 10/24/2016 - 10/24/2016 Drilling Method(s): HSA SPT Method: Automatic Hammer Other Test(s): Driller: Raymond Logger: G Koepping										LAB DATA					
FIELD DATA										GROUND WATER					
FIELD DESCRIPTION OF STRATA										LL PI					
0.0 / 388.0 Brown/orange, Clayey SILT with some Gravel, dry ML															
2.5 / 385.5 Orange with white deposits, SILT with some Clay, dry ML															
5.0 / 383.0 White/red, SILT with decomposing rock and latge Quartz gravel, dry ML															
13.5 / 374.5 Orange, brown, SILT with Quartz rock fragments, dry ML															
REMARKS: Rig Type: CME-45C-2 Truck Rig.										PAGE 1 OF 1 B-03					

A copy of the original signed geotechnical submittal is on file with the County.

The subsurface information shown on the boring logs in these plans was obtained with reasonable care and recorded in good faith solely for use by the County in establishing design controls for the project. The County has no reason to suspect that such information is not reasonably accurate as an approximate indication of the subsurface conditions at the sites where the borings were taken. The County does not in any way warrant or guarantee that such data can be projected as indicative of conditions beyond the limits of the borings shown; and any such projections by bidders are purely interpretive and altogether speculative. Further, the County does not in any way guarantee, either expressly or by implication, the sufficiency of the information for bid purposes.

The boring logs are made available to bidders in order that they may have access to subsurface data identical to that which is possessed by the County, and are not intended as a substitute for personal investigation, interpretation and judgment by the bidders.


PREFINAL PLANS									
EMERGENCY POLICE - FIRE - RESCUE 911									
FAIRFAX COUNTY, VIRGINIA DEPARTMENT OF PUBLIC WORKS AND ENVIRONMENTAL SERVICES 12000 GOVERNMENT CENTER PARKWAY, SUITE 449 FAIRFAX, VA., 22035-0052									
OFFICE OF CAPITAL FACILITIES 703-324-5800									
WIEHLE AVENUE (RTE 828) AT W&OD TRAIL ENGINEERING GEOLOGY 1 OF 2									
PROJECT NO: 1400102-2013									
PLAN NO. XXX-XX									
DESIGNED: JRM DRAFTED: CRR CHECKED: TAB									
SHEET 10(5)									
FUND # 500-C5000									

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PROJECT MANAGER: SCOTT, BUFFNER, P.E. (703) 877-5236  
SURVEYED BY, DATE: FAIRFAX COUNTY  
DESIGN BY: WHITMAN, REQUARDT & ASSOCIATES, LLP (703) 293-9717  
SUBSURFACE UTILITY BY, DATE: SO DEEP, INC. (703) 361-6005 December 23, 2014

STATE	ROUTE	FEDERAL AID	ROUTE	STATE
		PROJECT		PROJECT
VA.	—	—	828	0828-029-248, B-601



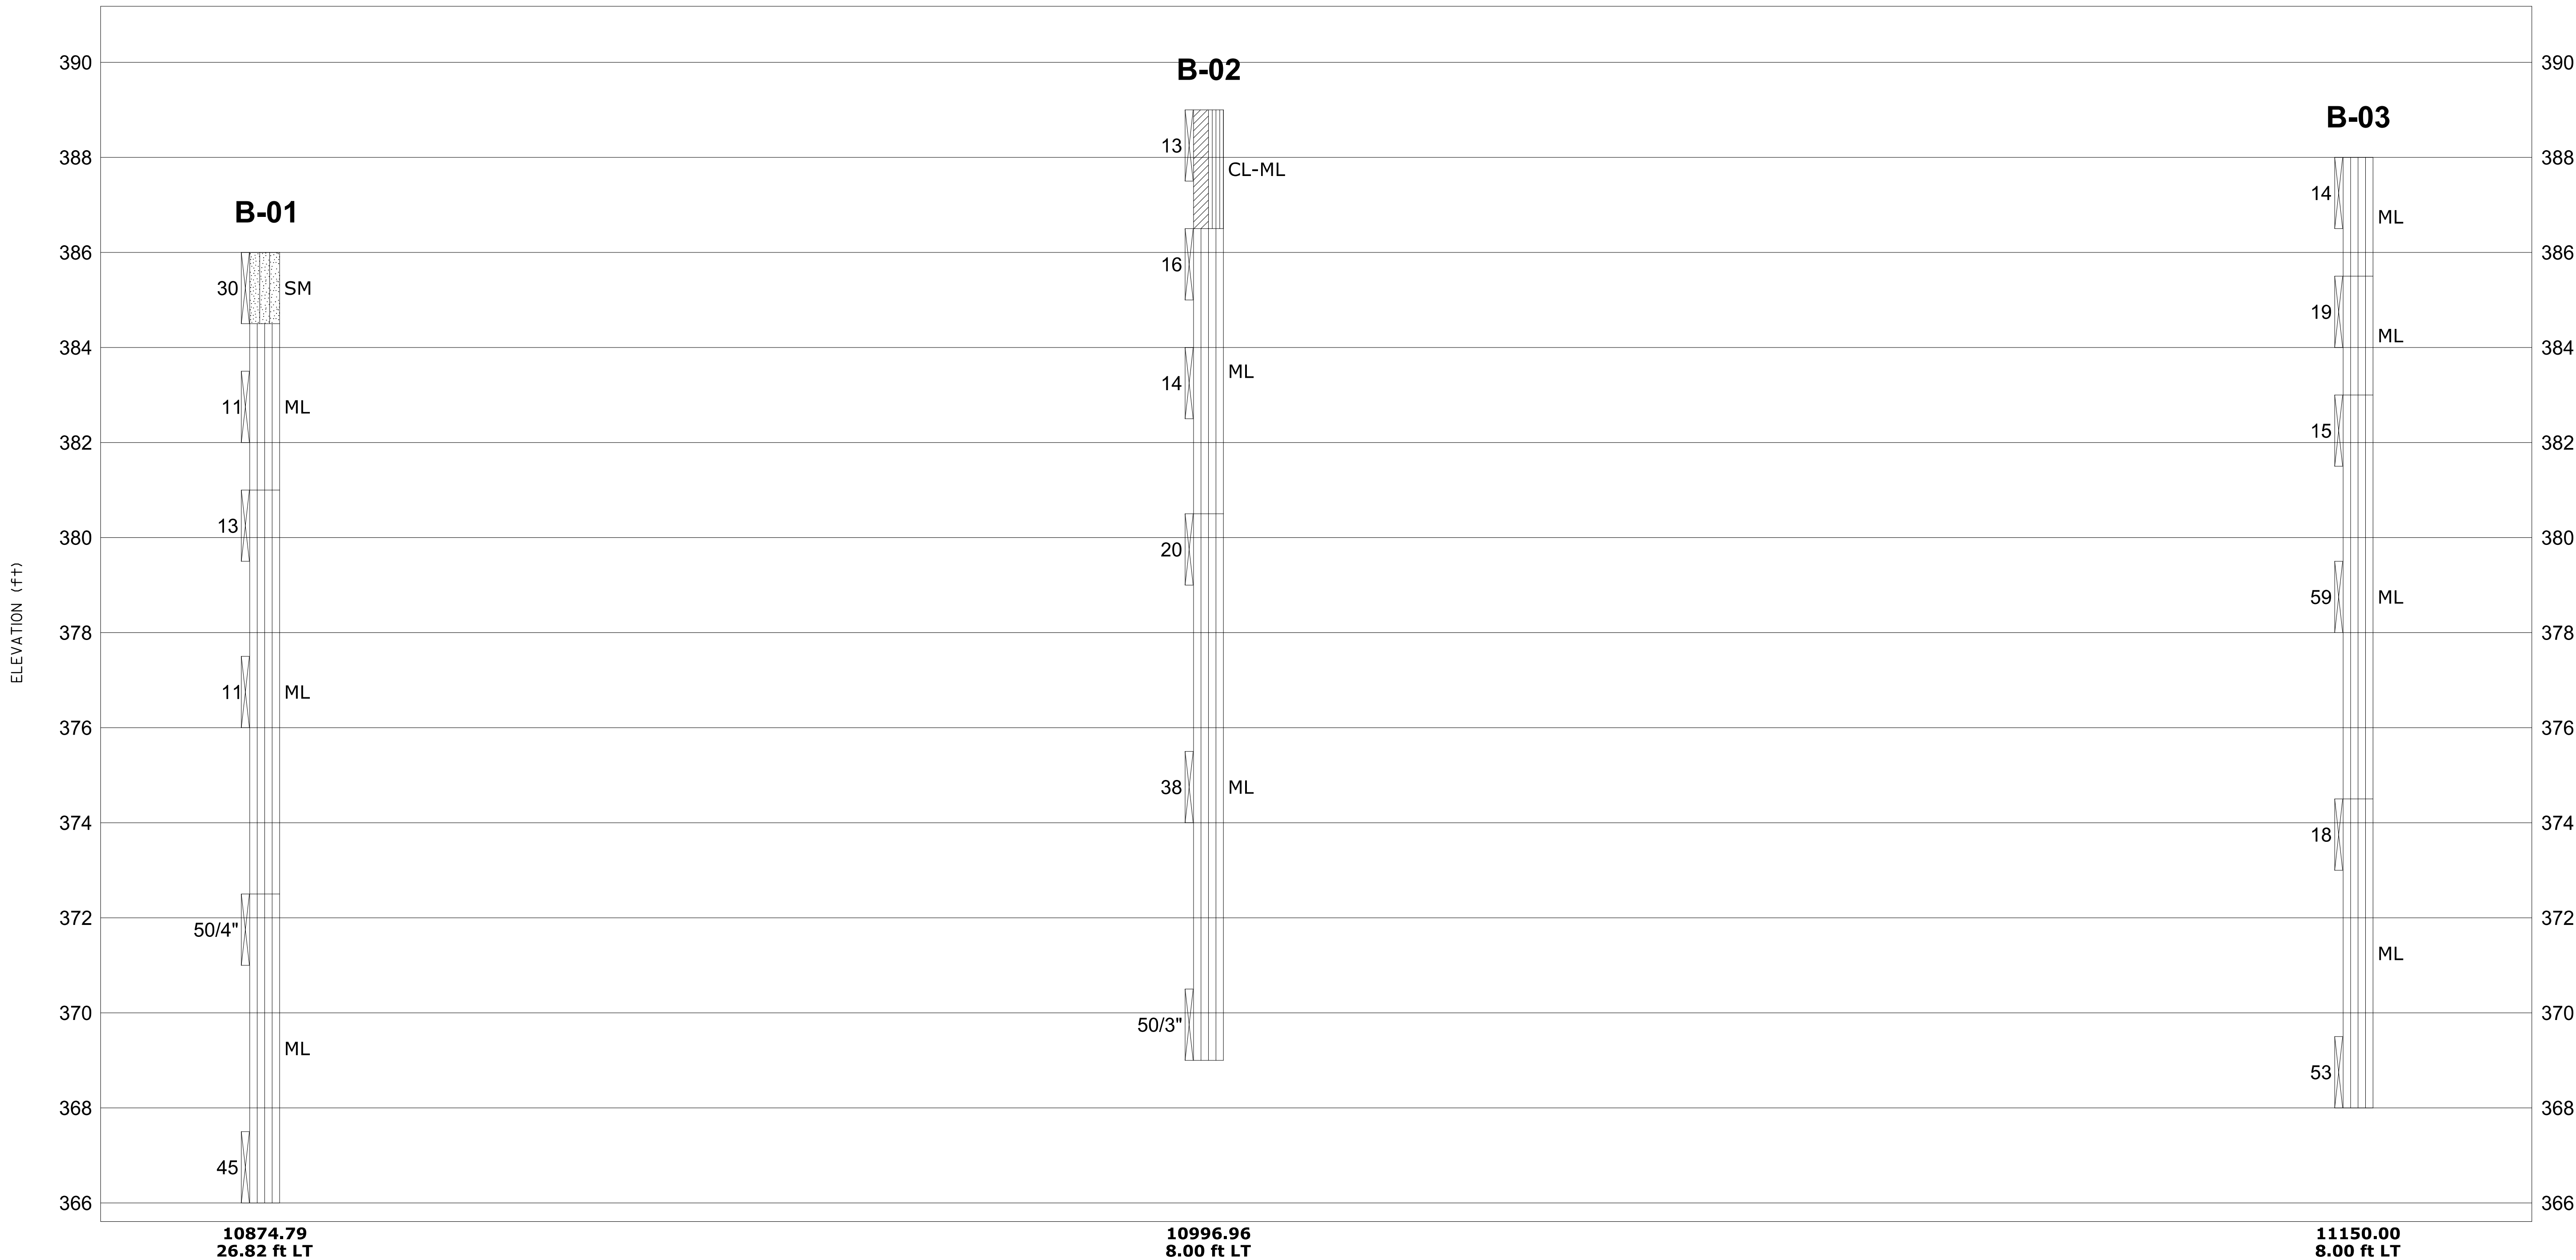A copy of the original signed geotechnical submittal is on file with the County.

The subsurface information shown on the boring logs in these plans was obtained with reasonable care and recorded in good faith solely for use by the County in establishing design controls for the project. The County has no reason to suspect that such information is not reasonably accurate as an approximate indication of the subsurface conditions at the sites where the borings were taken. The County does not in any way warrant or guarantee that such data can be projected as indicative of conditions beyond the limits of the borings shown; and any such projections by bidders are purely interpretive and altogether speculative. Further, the County does not in any way guarantee, either expressly or by implication, the sufficiency of the information for bid purposes.

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Notes: See borehole logs for complete data  
See Material and Sample Symbols List

EMERGENCY POLICE - FIRE - RESCUE 911				
FAIRFAX COUNTY, VIRGINIA				
DEPARTMENT OF PUBLIC WORKS AND ENVIRONMENTAL SERVICES				
12000 GOVERNMENT CENTER PARKWAY, SUITE 449 FAIRFAX, VA., 22035-0052				
OFFICE OF CAPITAL FACILITIES 703-324-5800				
WIEHLE AVENUE (RTE 828) AT W&OD TRAIL ENGINEERING GEOLOGY 2 OF 2				
PROJECT NO: 1400102-2013				
PLAN NO. XXX-XX		DESIGNED: JRM DRAFTED: CRR CHECKED: TAB		SHEET 10(6)
FUND # 500-C5000				

WHITMAN REQUARDT & ASSOCIATES RICHMOND, VA STRUCTURAL ENGINEER	APPROVED BY THE TRANSPORTATION DESIGN DIVISION
--	--

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DESIGN FEATURES RELATING TO CONSTRUCTION OR TO REGULATION AND CONTROL OF TRAFFIC MAY BE SUBJECT TO CHANGE AS DEEMED NECESSARY BY FAIRFAX COUNTY.

FOR FAIRFAX WATER ADJUSTMENTS ONLY

FAIRFAX WATER  
WATER SYSTEM ADJUSTMENTS  
FAIRFAX WATER PROJECT 2592 DIVISION 1

WATER MAIN CONSTRUCTION NOTES:

- AT LEAST 2 WEEKS IN ADVANCE TO BEGINNING ANY WATER MAIN CONSTRUCTION, THE WATER MAIN INSTALLATION CONTRACTOR SHALL SUBMIT TO FAIRFAX WATER, FOR REVIEW AND APPROVAL THE FOLLOWING:
  - EVIDENCE OF SATISFACTORY COMPLETION OF AT LEAST FIVE WATER MAIN INSTALLATION CONTRACTS SIMILAR IN QUANTITY AND COMPLEXITY, INCLUDING FOREMAN'S EXPERIENCE IN INSTALLING THE PIPE MATERIAL AND JOINT TYPES TO BE USED, PROJECT TITLES, PIPE DIAMETER AND LENGTH, LOCATIONS, REFERENCE CONTACTS, AND TELEPHONE NUMBERS. THE FOREMAN SHALL HAVE AT LEAST 5 YEARS EXPERIENCE IN THE INSTALLATION OF WATER MAINS, AND SHALL HAVE BEEN IN CHARGE OF INSTALLING AT LEAST 5,000 LINEAR FEET OF DUCTILE PIPE.
  - DATA SHALL BE SUPPLIED TO SHOW THAT STAFFING SCHEDULED FOR THE PROJECT POSSESS THE REQUIRED EXPERIENCE. SUCH DATA SHALL CONSIST OF A HISTORY OF THE EMPLOYMENT EXPERIENCE OF THE JOB FOREMAN, WHO WILL BE IN CHARGE OF THE WATER MAIN INSTALLATION WORK ON THE CONSTRUCTION SITE, TOGETHER WITH A DESCRIPTION OF ANY PARTICULAR CERTIFICATIONS OR SPECIAL CREDENTIALS HE MAY POSSESS.
- DURING THE CONSTRUCTION OF THE WATER MAIN, FAIRFAX WATER, UPON NOTICE TO THE CONTRACTOR, AND IN FAIRFAX WATER'S SOLE DISCRETION, WILL HAVE THE RIGHT TO DIRECT THE CONTRACTOR TO REMOVE AN EMPLOYEE PERMANENTLY FROM THE SITE FOR ANY REASON. IN ADDITION, IF ANY OF THE CONTRACTOR'S PERSONNEL ARE NOT SATISFACTORY TO FAIRFAX WATER THE CONTRACTOR SHALL REPLACE SAME WITH SATISFACTORY PERSONNEL.
- NOTICE OR COMMUNICATION TO THE FOREMAN SHALL BE EQUIVALENT TO NOTICE OR COMMUNICATION TO THE CONTRACTOR. THE FOREMAN SHALL FOLLOW WITHOUT DELAY ALL INSTRUCTIONS OF FAIRFAX WATER IN THE CONSTRUCTION AND COMPLETION OF THE WATER MAIN OR ANY WORK ASSOCIATED WITH OR IMPACTING FAIRFAX WATER INFRASTRUCTURE.
- FAIRFAX WATER SHALL HAVE THE RIGHT TO SUSPEND ANY PART OF THE WATER MAIN INSTALLATION WHENEVER IN THEIR JUDGMENT, SUCH SUSPENSION IS REQUIRED IN THE BEST INTEREST OF FAIRFAX WATER; OR TO TAKE OVER, USE, OCCUPY, OR OPERATE ANY PART OF THE COMPLETED OR PARTLY COMPLETED WATER MAIN INSTALLATION IF, BEFORE THE FINAL ACCEPTANCE OF THE WATER MAIN INSTALLATION, FAIRFAX WATER DEEMS IT NECESSARY.
- THE EXISTING UTILITIES, STRUCTURES, PROPERTY LINES, AND EASEMENTS SHOWN ARE BASED ON DATA AND CONSTRUCTION PLANS PROVIDED BY FAIRFAX COUNTY. THE WATER MAIN DESIGN HAS BEEN BASED ON THIS PROVIDED INFORMATION. THE CONTRACTOR SHALL VERIFY ALL INFORMATION TO HIS SATISFACTION AND SHALL DIG TEST PITS AS CALLED FOR IN THE CONSTRUCTION NOTES OR AS DEEMED NECESSARY BY THE ENGINEER.
- THE CONTRACTOR IS RESPONSIBLE FOR ENFORCING THE REQUIREMENTS OF CHAPTER 6-B, FAIRFAX COUNTY CODE-EXCAVATION AND UTILITY LINE INSTALLATION. IN PARTICULAR, THE CONTRACTOR IS DIRECTED TO SECTION 10, DEMOLITION OR EXCAVATION-PRIOR NOTICE OF THE AFORESAID CODE. THE CONTRACTOR SHALL CONTACT "MISS UTILITY" AT 1-800-257-7777 SUFFICIENTLY IN ADVANCE OF THE START OF CONSTRUCTION TO COMPLY WITH THIS REQUIREMENT.
- THE CONTRACTOR SHALL TAKE ALL NECESSARY PRECAUTIONS TO PROTECT EXISTING UTILITIES AND MAINTAIN UNINTERRUPTED SERVICE. ANY DAMAGE INCURRED SHALL BE REPAIRED IMMEDIATELY TO THE SATISFACTION OF THE ENGINEER AND UTILITY OWNER AT NO EXPENSE TO FAIRFAX COUNTY.
- ALL PIPE ELEVATIONS SHOWN ARE TOP OF PIPE UNLESS OTHERWISE SPECIFIED ON THE PLAN.
- THE CONTRACTOR IS REFERRED TO THE FAIRFAX COUNTY DRAWINGS AND STANDARDS FOR THE LATEST ROAD AND DRAINAGE DESIGN INFORMATION.
- NOTIFICATION OF PENDING WATER MAIN PRESSURE TESTS, DISINFECTION AND/OR CONNECTIONS; THE DESIRE TO HAVE AN EXISTING WATER SYSTEM VALVE OPENED OR CLOSED; AN EMERGENCY; ETC. SHALL BE DIRECTED TO:
  - 8:00 A.M. TO 4:00 P.M. MONDAY THROUGH FRIDAY  
MR. DAVE LAMBERT, SUPERVISOR, ENGINEERING INSPECTION  
8560 ARLINGTON BOULEVARD  
FAIRFAX, VA 22031  
TELEPHONE NO. (703) 289-6399  
CELL PHONE NO. (571) 722-7643
  - NIGHT, WEEKENDS AND HOLIDAYS  
DISPATCHER  
TELEPHONE NO. (703) 289-6395 OR (703) 289-6323
- THE CONTRACTOR **SHALL NOT** OPEN OR CLOSE ANY EXISTING WATER SYSTEM VALVES WITHOUT A FAIRFAX WATER INSPECTOR OVERSEEING THE WORK.
- THE WORKING PRESSURE OF THE EXISTING WATER SYSTEM IS APPROXIMATELY XX PSI.
- FAIRFAX WATER INSPECTOR WILL RECORD "AS BUILT" CONDITIONS FOR THE GENERAL WATER MAIN CONSTRUCTION.
- FAIRFAX WATER PUBLISHES AN "APPROVED PRODUCTS LIST" WHICH LISTS, BY CATEGORY, MANUFACTURER'S PRODUCTS APPROVED FOR USE IN FAIRFAX WATER'S SYSTEM. MANUFACTURER'S PRODUCTS COVERED BY THE CATEGORIES INCLUDED IN THIS DOCUMENT WHICH ARE NOT SPECIFICALLY LISTED ARE NOT APPROVED FOR USE. COPIES OF THIS DOCUMENT ARE AVAILABLE AT WWW.FAIRFAXWATER.ORG.
- ALL WATER MAIN INSTALLATION SHALL BE IN CONFORMANCE WITH FAIRFAX WATER'S STANDARD DETAILS, INCLUDED HEREIN, AND CONSTRUCTION PRACTICE MANUAL. BOTH DOCUMENTS CAN BE FOUND AT FAIRFAX WATER'S WEBSITE AT WWW.FAIRFAXWATER.ORG.
- FAIRFAX WATER WILL REVIEW AND APPROVE WATER MAIN LAYING SCHEDULES (FOR 24-INCH AND GREATER) AND WATER MAIN RELATED SHOP DRAWINGS FOR THIS PROJECT AS TRANSMITTED TO FAIRFAX WATER BY THE CONTRACTOR. SUBMITTALS TO FAIRFAX WATER SHALL CONSIST OF CATALOG CUTS, SUPPLIER CERTIFICATIONS AND ANY OTHER INFORMATION PERTINENT TO THE MATERIAL ITEM. ALL SUBMITTALS SHALL BE OF CLEAR AND READABLE QUALITY AND THE ITEM BEING SUBMITTED FOR REVIEW SHALL BE CLEARLY HIGHLIGHTED OR DEFINED SO THAT THE REVIEWER CAN READILY IDENTIFY IT. FAIRFAX WATER REQUIRES A MINIMUM OF FOUR (4) SETS OF SUBMITTALS FOR IN-HOUSE DISTRIBUTION. ADDITIONAL SETS OF SUBMITTALS TO BE RETURNED TO THE CONTRACTOR SHOULD BE PROVIDED AT THIS TIME. THE SUBMITTALS WILL BE PROVIDED TO FAIRFAX WATER WITH A TRANSMITTAL LETTER CLEARLY IDENTIFYING THE CONTENTS OF THE DOCUMENTS AND FAIRFAX WATER PROJECT NUMBER. SUBMITTALS SHALL BE REVIEWED AND RETURNED WITHIN TWENTY (20) WORKING DAYS OF THE DATE THE SUBMITTALS ARE RECEIVED BY FAIRFAX WATER. INFORMATION THAT IS MAILED OR DELIVERED BY COURIER SHOULD BE DIRECTED TO:

FAIRFAX WATER  
8560 ARLINGTON BOULEVARD  
FAIRFAX, VIRGINIA 22031  
MR. JERRY SCOTT, P.E., CCM  
CHIEF CONSTRUCTION ENGINEER

- THE CONTRACTOR SHALL NOT BE RELEASED FROM THE PROJECT UNTIL THE WATER MAIN INSTALLATION WORK AND FINAL WATER MAIN INSPECTION ARE COMPLETED TO THE SATISFACTION OF FAIRFAX WATER. A FAIRFAX WATER REPRESENTATIVE SHALL PROVIDE WRITTEN APPROVAL VERIFYING THAT THE WATER MAIN INSTALLATION WORK IS COMPLETE.
- AT EACH LOCATION WHERE A NEW WATER MAIN IS TO BE CONNECTED TO THE EXISTING WATER MAIN, THE CONTRACTOR SHALL NOT ORDER MATERIAL FOR THE CONNECTION UNTIL HE HAS DUG A TEST PIT AND VERIFIED THE EXACT LOCATION, SIZE, OUTSIDE DIAMETER, ROUNDNESS, ELEVATION, MATERIAL, JOINT LOCATION, AND TYPE AND DIRECTION OF THE EXISTING WATER MAIN. DIG TEST PITS ONLY IN THE PRESENCE OF AN AUTHORIZED REPRESENTATIVE OF FAIRFAX WATER.
- IF TEST PIT DATA OR FIELD CONDITIONS SHOW THERE IS A CONFLICT WITH AN EXISTING UTILITY OR THE WATER MAIN DESIGN HAS TO BE MODIFIED, SUBMIT THE TEST PIT DATA OR FIELD INFORMATION TO FAIRFAX WATER. FAIRFAX WATER WILL REVIEW AND MODIFY THE DRAWINGS AS REQUIRED.
- INSTALL EACH REPLACEMENT WATER MAIN UP TO BUT EXCLUDING THE CONNECTION(S) TO THE EXISTING WATER MAIN(S) TO THE LINES AND GRADES SHOWN ON THE DRAWINGS. INSTALL TEMPORARY PLUGS OR CAPS, AND SUCCESSFULLY PRESSURE TEST AND DISINFECT THE WATER MAIN. LEAKAGE LOSS (L) AS MEASURED IN GALLONS/HOUR, SHALL NOT EXCEED  $50(P)^{0.95}/148,000$  FOR TWO HOURS WHERE "S" IS THE LENGTH IN FEET OF WATER MAIN TESTED, "D" IS THE NOMINAL INSIDE DIAMETER OF THE PIPE IN INCHES, AND "P" IS THE TEST PRESSURE OF 150 PSI OR 125% (PIPE LESS THAN 20") 150% (PIPE EQUAL TO OR GREATER THAN 20") OF THE MAXIMUM EXPECTED WORKING PRESSURE, WHICHEVER IS GREATER, AT THE HIGH POINT OF THE WATER MAIN UNLESS OTHERWISE SHOWN OR DIRECTED BY FAIRFAX WATER. PRESSURE TESTS SHALL BE LIMITED TO 2,500 FEET FOR ANY INDIVIDUAL TEST. NO ADDITIONAL PAYMENT FOR TEMPORARY BLOW OFFS OR AIR RELEASES.
- AT LEAST SEVEN WORKING DAYS PRIOR TO THE DATE THE CONTRACTOR ANTICIPATES INSTALLING THE CONNECTION(S) TO THE EXISTING WATER SYSTEM, THE CONTRACTOR SHALL MEET WITH A FAIRFAX WATER REPRESENTATIVE AND REVIEW HIS PROPOSED SCHEDULING AND CONSTRUCTION PROCEDURES FOR THE CONNECTION(S). SYSTEM DEMANDS AND OPERATING CONDITIONS AT THE TIME CONNECTION(S) ARE SCHEDULED MAY REQUIRE A NIGHT (9:00 P.M. TO 6:00 A.M.) CONNECTION TIME. NO ADDITIONAL PAYMENT WILL BE MADE TO THE CONTRACTOR FOR WORK WHICH MUST BE PERFORMED AT NIGHT. APPROVAL OF THE CONTRACTOR'S CONNECTION(S) SCHEDULE AND CONSTRUCTION PROCEDURES BY FAIRFAX WATER DOES NOT RELIEVE THE CONTRACTOR OF HIS TOTAL RESPONSIBILITY TO SEE THAT THE CONNECTION IS SUCCESSFULLY COMPLETED WITHIN THE DESIGNATED TIME FRAME.
- BASED ON THE APPROVED CONSTRUCTION SCHEDULE, FAIRFAX WATER WILL GIVE AT LEAST 48 HOURS WRITTEN NOTICE TO AFFECTED CUSTOMERS FOR WATER MAIN CONSTRUCTION THAT WILL REQUIRE THE INTERRUPTION OF WATER SERVICE TO THESE CUSTOMERS.
- PRIOR TO THE COMMENCEMENT OF ANY CONNECTION WORK, THE FAIRFAX WATER INSPECTOR WILL CONFIRM THAT THE CONTRACTOR HAS ALL NECESSARY MATERIALS, TOOLS AND EQUIPMENT AT THE WORK SITE. PIPE, FITTINGS AND VALVES SHALL BE PREASSEMBLED AS MUCH AS POSSIBLE TO REDUCE THE TIME OF WATER SERVICE INTERRUPTION. WORK WILL NOT COMMENCE UNTIL THIS IS CONFIRMED. ALSO, THE GEOMETRY OF THE CONNECTION SHALL BE VERIFIED BY THE CONTRACTOR PRIOR TO STARTING THE CONNECTION.
- THE CONTRACTOR SHALL WORK CONTINUOUSLY AND EXPEDITIOUSLY AROUND THE CLOCK USING MULTIPLE CREWS UNTIL THE CONNECTIONS ARE SUCCESSFULLY INSTALLED AND WATER SERVICE IS RESUMED. WHERE THE NEW WATER MAIN IS TO BE CONNECTED AT MORE THAN ONE POINT TO THE EXISTING WATER SYSTEM, CONNECTIONS SHALL PROCEED SIMULTANEOUSLY. ALL CONNECTION WORK MUST BE SUCCESSFULLY COMPLETED WITHIN TEN HOURS UNLESS NOTED DIFFERENTLY IN WRITING BY THE ENGINEER OR FAIRFAX WATER. THE CONTRACTOR SHALL COMMIT THE NECESSARY PERSONNEL AND EQUIPMENT REQUIRED TO PERFORM THE SIMULTANEOUS CONNECTIONS WITHIN THE ABOVE TIME CONSTRAINTS.
- ONLY NON-TOXIC LUBRICANTS RECOMMENDED BY THE PIPE MANUFACTURER AND APPROVED BY THE VIRGINIA DEPARTMENT OF HEALTH SHALL BE USED ON GASKETS. A SOAP SOLUTION WILL NOT BE ALLOWED.
- ANY WATER MAIN TO BE INSTALLED IN A FILL AREA SHALL HAVE THE FILL PLACED AND COMPACTED TO A MINIMUM OF 2 FEET ABOVE THE TOP OF THE PROPOSED PIPE PRIOR TO EXCAVATION FOR AND INSTALLATION OF THE PIPE.
- FIELD APPLIED PETROLATUM TAPE TO BE APPLIED TO:
  - BURIED MECHANICAL JOINTS, BOLTS, NUTS, COUPLINGS, HARNESS TIE RODS, SADDLES, IRON AND STEEL ANCHORS, AND OTHER BURIED CONNECTING HARDWARE.
  - PIPE EMBEDDED IN CONCRETE ANCHOR BLOCKS OR OTHERWISE IN CONTACT WITH CONCRETE, EXTENDING THROUGH CONCRETE AND ADJACENT 6 INCHES IN BOTH DIRECTIONS.
  - SERVICE CLAMPS, NON-MOVING PARTS OF CORPORATION STOPS, AND OTHER TRANSITION FITTINGS BETWEEN COPPER SERVICES AND DUCTILE IRON PIPE.
- NO BLASTING SHALL OCCUR WITHIN 25 FEET OF EXISTING WATER MAINS. A MAXIMUM PARTICLE VELOCITY OF 1 1/2 INCHES PER SECOND AT THE CLOSEST POINT TO THE WATER MAIN FOR ANY BLASTING THAT OCCURS BEYOND THE 25 FEET LIMIT SHALL BE ADHERED TO.
- ANY SOUND BARRIER CONSTRUCTION, INCLUDING FOOTINGS, WITHIN 15 FEET OF THE EXISTING OR PROPOSED WATER MAINS SHALL BE REVIEWED FOR APPROVAL BY FAIRFAX WATER.
- INSTALL IDENTIFICATION TAPE DURING BACKFILL OPERATIONS ONE FOOT ABOVE WATER MAIN PIPING FOR ALL RESTRAINED PIPE JOINTS.
- WATER METERS WITHIN PROJECT LIMITS SHALL BE RELOCATED BY THE CONTRACTOR TO A LOCATION BEHIND THE PROPOSED CURB AND GUTTER. ALL WATER SERVICE RELOCATIONS AND RETAPS SHALL BE INSTALLED BY THE CONTRACTOR. ALL EXISTING SERVICES SHALL BE RECONNECTED BY THE CONTRACTOR AFTER ALL APPROVALS HAVE BEEN OBTAINED. WATER METER ASSEMBLIES SHALL INCLUDE ALL MATERIALS AS SHOWN IN FAIRFAX WATER'S STANDARD DETAILS.
- PROPOSED WATER MAINS AND SERVICES MUST BE IN SERVICE BEFORE EXISTING WATER MAINS AND SERVICES ARE ABANDONED.
- UPON COMPLETION OF PROJECT, INSPECTOR WILL CHECK THAT ALL METER BOXES ARE SET TO GRADE AND IN CORRECT LOCATIONS BEFORE THE CONTRACTOR MOVES OFF JOBSITE.
- IN INSTANCES WHERE FAIRFAX COUNTY AND FAIRFAX WATER SPECIFICATIONS OVERLAP OR ADDRESS THE SAME ISSUES, THE MORE STRINGENT SPECIFICATIONS SHALL BE ADHERED TO.
- ALL ABANDONED VALVES AND APPURTENANCES SHALL BECOME THE PROPERTY OF THE CONTRACTOR AND DISPOSAL/REMOVAL OF SUCH SHALL BE THE RESPONSIBILITY OF THE CONTRACTOR.
- IF THE PROJECT REQUIRES CUTTING OF ASBESTOS CEMENT PIPE (ACP) WATER MAINS, THE CONTRACTOR SHALL COMPLY WITH ALL STATE, FEDERAL AND LOCAL REGULATIONS INCLUDING, BUT NOT LIMITED TO, OSHA REQUIREMENTS, AND VIRGINIA DEPARTMENT OF WASTE MANAGEMENT REGULATIONS IN WORKING WITH AND DISPOSAL OF ASBESTOS CEMENT PIPE.


- THE CONTRACTOR SHALL INSTALL 1 LAYER OF 8-MIL V-BIO POLYETHYLENE ENCASEMENT FOR ALL WATER MAINS, AS SHOWN ON THE DRAWINGS AND STANDARD DETAILS.
- ALL EXISTING AND NEW VALVE BOXES MUST BE FULLY ADJUSTED TO CONFORM TO FINAL ASPHALT GRADE. NO PAVING ADJUSTERS WILL BE PERMITTED.
- IN AREAS WHERE PETROLEUM-CONTAMINATED SOILS ARE ENCOUNTERED ALONG THE PROPOSED WATER MAIN ALIGNMENT, THE CONTRACTOR, AS DIRECTED BY FAIRFAX WATER, SHALL REMOVE AND DISPOSE OF ALL CONTAMINATED SOILS WITHIN THE PIPELINE TRENCH WHERE THE TOTAL PETROLEUM HYDROCARBON (TPH) CONCENTRATION EXCEEDS 50 MG/KG. THE CONTRACTOR SHALL REMOVE THE SUBJECT SOILS AS DIRECTED BY FAIRFAX WATER IN ACCORDANCE WITH APPLICABLE REGULATIONS OF THE VIRGINIA DEPARTMENT OF ENVIRONMENTAL QUALITY (VDEQ), THE U.S. ENVIRONMENTAL PROTECTION AGENCY (EPA), OCCUPATIONAL SAFETY AND HEALTH ADMINISTRATION (OSHA), AND INDUSTRY-RECOGNIZED REMOVAL PROCEDURES. THE CONTAMINATED SOILS SHALL BE DISPOSED OF AT A CERTIFIED LANDFILL SITE FOR THE CONCENTRATION LEVELS ENCOUNTERED. THE CONTRACTOR SHALL INSTALL FKM (VITON) GASKETS IN ACCORDANCE WITH THE PIPELINE MANUFACTURER'S INSTALLATION REQUIREMENTS IN ALL AREAS WHERE EXCAVATED SOILS EXCEED 10 MG/KG TPH OR TO THE EXTENT DIRECTED BY FAIRFAX WATER. SUITABLE CLEAN FILL MATERIAL WILL BE PUT IN PLACE ABOVE THE NEWLY INSTALLED WATER MAIN, IF NON-PAVED AREA, IN ACCORDANCE WITH FAIRFAX WATER'S STANDARD TRENCH DETAILS.
- THE CONTRACTOR SHALL NOT INSTALL ANY EARTHWORK OVER EXISTING OR PROPOSED FAIRFAX WATER UTILITIES BEYOND THAT WHICH IS SHOWN IN THE APPROVED FAIRFAX COUNTY DRAWINGS WITHOUT THE APPROVAL OF FAIRFAX WATER.

LEGEND

	EXISTING	PROPOSED
WATER MAIN		
2" AIR RELEASE VALVE & BOX		
2" BLOW OFF VALVE & BOX		
WATER VALVE & BOX		
REDUCER		
WATER METER & BOX		
FIRE HYDRANT		
C.I.P.	CAST IRON PIPE	
D.I.P.	DUCTILE IRON PIPE	
P.C.C.P.	PRESTRESSED CONCRETE CYLINDER PIPE	
EXISTING WATER MAIN TO BE ABANDONED OR REMOVED		
CAP/PLUG EXISTING WATER MAIN		
FAIRFAX WATER EASEMENT		

INDEX OF SHEETS

FAIRFAX WATER SHEET NO.	FAIRFAX COUNTY SHEET NO.	GENERAL DESCRIPTION
100	-	WATER MAIN CONSTRUCTION NOTES, LEGEND, VICINITY MAP & INDEX OF SHEETS
101	-	SUMMARY OF QUANTITIES, MEASUREMENT AND PAYMENT
102	3	WATER MAIN RELOCATION PLAN
103	4	WATER MAIN RELOCATION PLAN
104	5	WATER MAIN RELOCATION PLAN
105	-	WATER MAIN RELOCATION PROFILES
106	-	WATER MAIN RELOCATION PROFILES
107	-	MISCELLANEOUS DETAILS

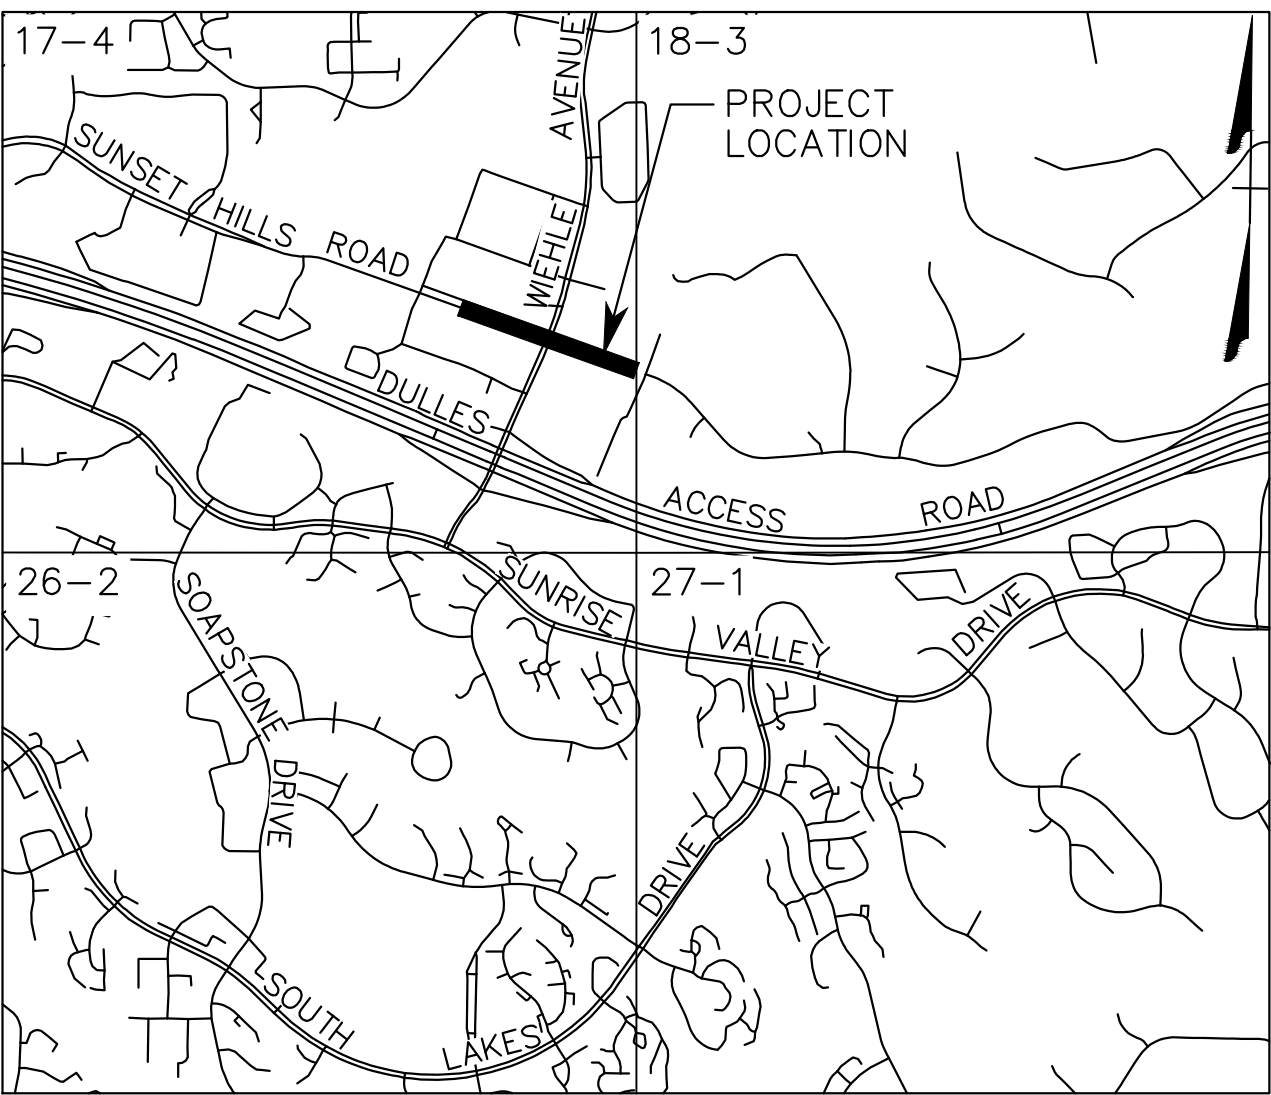

VICINITY MAP

SCALE: 1"=2000'

FAIRFAX WATER ADJUSTMENTS

WIEHLE AVENUE (RTE. 828) AT W&OD TRAIL

WATER SYSTEM ADJUSTMENTS

FAIRFAX WATER PROJECT 2592, DIVISION 1

FAIRFAX COUNTY PROJECT NO. 1400102-2013

TAX MAP 17-4

FAIRFAX COUNTY, VIRGINIA

PREPARED BY

FAIRFAX WATER

8560 ARLINGTON BOULEVARD

FAIRFAX, VIRGINIA 22031

OFFICE (703) 289-6300 FAX (703) 289-6398

DATE: MARCH 2018

50% PLANS



FOR FAIRFAX WATER ADJUSTMENTS ONLY

FAIRFAX WATER  
WATER SYSTEM ADJUSTMENTS  
FAIRFAX WATER PROJECT 2592 DIVISION 1

SUMMARY OF QUANTITIES														
SHEET NUMBER	DUCTILE IRON WATER MAIN			P.C.C.P. TIE-IN	LONG SOLID SLEEVE	BUTTERFLY VALVE & BOX	GATE VALVE & BOX		BRANCH		BEND	AIR RELEASE ASSEMBLY	FIRE HYDRANT	SHEET NUMBER
SIZE	6"	12"	24"	24"	24"	24"	6"	12"	24"x6"	24"x12"	24"	2"	N/A	SIZE
UNIT	L.F.	L.F.	L.F.	EA.	EA.	EA.	EA.	EA.	EA.	EA.	EA.	EA.	EA.	UNIT
102	–	–	197	1	–	–	–	–	–	–	2	–	–	102
103	–	15	465	–	2	2	–	1	–	1	1	–	–	103
104	10	–	749	1	–	–	1	–	1	–	10	–	1	104
TOTAL	10	15	1411	2	2	2	1	1	1	1	13	–	1	TOTAL

MEASUREMENT AND PAYMENT

1. MEASUREMENT AND PAYMENT FOR ITEMS LISTED IN THE WATER MAIN SUMMARY SHALL BE AS DEFINED IN THE LATEST EDITION OF THE VIRGINIA DEPARTMENT OF TRANSPORTATION ROAD AND BRIDGE SPECIFICATIONS OR AS OTHERWISE DENOTED HEREON. PAYMENT SHALL INCLUDE FULL COMPENSATION FOR ALL MATERIALS, LABOR, EQUIPMENT AND INCIDENTALS NECESSARY TO COMPLETE THE INSTALLATION IN ACCORDANCE WITH THE APPLICABLE FAIRFAX WATER STANDARD DETAILS AND THOSE IN THE PLANS.
2. DUCTILE IRON WATER MAIN: FAIRFAX WATER’S WATER MAINS, APPURTENANCES, AND OTHER ASSOCIATED WORK WILL BE MEASURED IN UNITS OF LINEAR FEET, COMPLETE, AND PAID FOR AT THE CONTRACT UNIT PRICE PER LINEAR FOOT FOR THE RESPECTIVE SIZE OF THE WATER MAIN. THIS PRICE SHALL INCLUDE EXCAVATION, SHEETING AND SHORING, BEDDING, BACKFILL, COMPACTION, CONNECTIONS TO THE EXISTING WATER MAINS, TESTING, DEWATERING, AND THE FOLLOWING, BASED ON THE RESPECTIVE SIZE OF THE WATER MAIN:

– BRANCHES, BENDS, REDUCERS, CAPS, AND PLUGS (12" AND LESS), INCLUDING CONCRETE THRUST RESTRAINTS, AND ASSOCIATED FITTINGS

– LONG SOLID SLEEVES

– RESTRAINED JOINT PIPE, PIPE RESTRAINT, AND IDENTIFICATION TAPE

– POLYETHYLENE ENCASEMENT

EXCAVATION SUPPORT SYSTEMS AND PIPE SUPPORT SYSTEMS WILL NOT BE MEASURED FOR SEPARATE PAYMENT, BUT SHALL BE INCLUDED IN THE COST OF THE WATER MAIN.

ABANDONMENT OR REMOVAL OF EXISTING WATER MAINS WILL INCLUDE, BUT WILL NOT BE LIMITED TO, CLOSING ALL VALVES; REMOVING VALVE BOXES, WATERLINE MARKERS, FIRE HYDRANTS, BOLLARDS, AND TEST STATIONS; CUTTING AND PLUGGING EXISTING WATER MAINS; REMOVING EXISTING WATER MAINS (AS REQUIRED); CRIMPING COPPER SERVICE LINES; COMPACTING; BACKFILLING WITH SUITABLE MATERIAL; DELIVERY OF SALVAGE MATERIALS TO FAIRFAX WATER’S STORAGE YARDS; AND OTHER ASSOCIATED WORK, WHERE INDICATED ON THE PLANS AND WHERE DIRECTED BY FAIRFAX WATER AND WILL NOT BE MEASURED FOR SEPARATE PAYMENT, BUT SHALL BE INCLUDED IN THE COST OF THE WATER MAIN.

IF THE CONTRACTOR IS REQUIRED TO INSTALL VITON GASKETS AS A RESULT OF ENCOUNTERING PETROLEUM CONTAMINATED SOILS (REFER TO WATER MAIN CONSTRUCTION NOTE 39, SHEET 100), THE CONTRACTOR WILL BE COMPENSATED FOR THE VITON GASKETS BASED ON ACTUAL INVOICED PRICE MINUS THE COST FOR THE STANDARD GASKET, PLUS APPROVED MARK-UP PER THE CONTRACT REQUIREMENTS. NO ADDITIONAL COMPENSATION WILL BE PROVIDED FOR THE INSTALLATION OF THE VITON GASKETS.
3. PRESTRESSED CONCRETE CYLINDER PIPE TIE-IN WILL BE MEASURED IN UNITS OF EACH, COMPLETE IN PLACE, AND PAID FOR AT THE CONTRACT UNIT PRICE PER EACH, WHICH PRICE SHALL INCLUDE CONNECTION TO THE WATER MAIN; AND ALL MATERIALS, LABOR, EQUIPMENT, AND INCIDENTALS NECESSARY TO COMPLETE THE WORK, AS INDICATED ON THE P.C.C.P. TIE-IN DETAIL ON SHEET 107.
4. VALVES AND BOXES WILL BE MEASURED IN UNITS OF EACH, COMPLETE IN PLACE, AND PAID FOR AT THE CONTRACT UNIT PRICE PER EACH BASED ON ITS RESPECTIVE SIZE AND TYPE. THIS PRICE SHALL INCLUDE FULL COMPENSATION FOR FURNISHING AND INSTALLING THE GATE VALVE, FOR MAINS UP TO 14-INCHES, OR THE BUTTERFLY VALVE, FOR MAINS 16-INCHES AND LARGER; VALVE BOXES; CONNECTION TO THE WATER MAIN; AND ALL MATERIALS, LABOR, EQUIPMENT, AND INCIDENTALS NECESSARY TO COMPLETE THE WORK, INCLUDING EXCAVATION, BEDDING, BACKFILL, AND COMPACTION.
5. AIR RELEASE ASSEMBLY WILL BE MEASURED IN UNITS OF EACH, COMPLETE IN PLACE, AND PAID FOR AT THE CONTRACT UNIT PRICE PER EACH, WHICH PRICE SHALL BE FULL FURNISHING AND INSTALLING THE GATE VALVE; PIPE AND FITTINGS; VALVE BOXES; CONNECTION TO THE WATER MAIN; AND ALL MATERIALS, LABOR, EQUIPMENT AND INCIDENTALS NECESSARY TO COMPLETE THE WORK, AS INDICATED ON THE TWO-INCH AIR RELEASE ASSEMBLY DETAIL ON SHEET 107.
6. FIRE HYDRANT WILL BE MEASURED IN UNITS OF EACH, COMPLETE IN PLACE, AND PAID FOR AT THE CONTRACT UNIT PRICE FOR EACH, WHICH PRICE SHALL INCLUDE FULL COMPENSATION FOR THE HYDRANT; CONNECTION TO HYDRANT LEG PIPING; FITTINGS; CONCRETE THRUST RESTRAINT; AND ALL OTHER MATERIALS, LABOR, EQUIPMENT AND INCIDENTALS NECESSARY TO COMPLETE THE WORK, AS INDICATED IN THE HYDRANT DETAIL ON SHEET 107.


50% PLANS

THESE PLANS ARE UNFINISHED AND UNAPPROVED  
AND ARE NOT TO BE USED FOR CONSTRUCTION.

EMERGENCY POLICE – FIRE – RESCUE 911										
FAIRFAX COUNTY, VIRGINIA										
DEPARTMENT OF PUBLIC WORKS AND ENVIRONMENTAL SERVICES										
UTILITY DESIGN & CONSTRUCTION DIVISION										
12000 GOVERNMENT CENTER PARKWAY, SUITE 449, FAIRFAX, VA 22035-0052										
R E V I S I O N S						OFFICE OF CAPITAL FACILITIES 703-324-5800				
						WIEHLE AVENUE (RTE 828) AT W&OD TRAIL				
						PAY ITEM NOTES & SUMMARY OF QUANTITIES				
						PROJECT NO. 1400102-2013				
						SCALE		DESIGNED BY:	RCP	SHEET
						HORIZ: N/A		DRAFTED BY:	ARS	101
						VERT:		CHECKED BY:	RCC	
	△#	DESCRIPTION	BY	APPROVED	DATE					



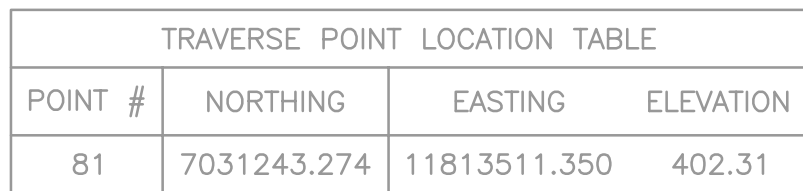FAIRFAX WATER  
WATER SYSTEM ADJUSTMENTS  
FAIRFAX WATER PROJECT 2592 DIVISION 1



(C1) Curve WO&D-1	(C2) Curve WO&D-2
PI = 108+50.75	PI = 109+48.44
DELTA = 12° 06' 08.46" (LT)	DELTA = 8° 50' 03.43" (RT)
D = 32' 44" 26"	D = 32' 44" 26"
T = 18.55'	T = 13.52'
L = 36.96'	L = 26.98'
R = 175.00'	R = 175.00'
PC = 108+32.20	PC = 109+34.92
PT = 108+69.16	PT = 109+61.90

A horizontal scale bar labeled "SCALE" is shown. It has a white section from 0 to 25' and a black section from 25' to 50'.

<p align="center"> <b>EMERGENCY POLICE – FIRE – RESCUE 911</b>  <b>FAIRFAX COUNTY, VIRGINIA</b>  <b>DEPARTMENT OF PUBLIC WORKS AND ENVIRONMENTAL SERVICES</b>  <b>UTILITY DESIGN &amp; CONSTRUCTION DIVISION</b>  <b>12000 GOVERNMENT CENTER PARKWAY, SUITE 449, FAIRFAX, VA 22035-0052</b> </p>									
R E V I S I O N S						<b>OFFICE OF CAPITAL FACILITIES</b> <b>703-324-5800</b>			
						<b>WIEHLE AVENUE (RTE 828)</b> <b>AT W&amp;OD TRAIL</b> <b>PLAN</b>			
						<b>PROJECT NO. 1400102-2013</b>			
						<b>SCALE</b> HORIZ: 1"=25' VERT: N/A	DESIGNED BY: RCP DRAFTED BY: ARS CHECKED BY: RCC	<b>SHEET</b>  102	
	<b>△#</b>	<b>DESCRIPTION</b>	<b>BY</b>	<b>APPROVED</b>	<b>DATE</b>				

FUND NO. 500-C5000



## FOR FAIRFAX WATER ADJUSTMENTS ONLY

FAIRFAX WATER  
WATER SYSTEM ADJUSTMENTS  
FAIRFAX WATER PROJECT 2592 DIVISION 1

## LEGEND


- Proposed Pavement Overlay
- Proposed Full Depth Pavement
- Proposed Demolition of Pavement
- Denotes Construction Limits in Cuts
- Denotes Construction Limits in Fills
- Denotes Proposed Graded "V" Ditch

Sta. 115+57.68 W&OD TRAIL  
Sta. 403+84.62 WIEHLE AVE.  
= 89° 40' 36"

NOTE 1: CONTRACTOR SHALL INSTALL AND PLACE INTO SERVICE PROPOSED 24" WATER MAIN PRIOR TO ABANDONMENT. CONTRACTOR SHALL ABANDON SEGMENTS OF EXISTING 24" P.C.C.P. WATER MAIN WITHIN LOADING PLANE OF PROPOSED MSE WALL BY FILLING WITH FLOWABLE FILL. CONTRACTOR MAY REMOVE COMPLETELY THOSE SEGMENTS IN LIEU OF FLOWABLE FILL PLACEMENT. CONTRACTOR SHALL INSTALL BRICK AND MORTAR END SEALS (CUT AND CAP) AT EACH END OF SEGMENTS THAT ARE TO BE ABANDONED-IN-PLACE.

NOTE 2: CONTRACTOR SHALL INSTALL AND PLACE INTO SERVICE PROPOSED 24" WATER MAIN PRIOR TO REMOVAL OF EXISTING 24" GATE VALVE VAULT. CONTRACTOR SHALL REMOVE EXISTING 24" GATE VALVE VAULT PRIOR TO INSTALLATION OF PROPOSED MSE WALL AT THIS LOCATION. CONTRACTOR SHALL CONTACT DAVE LAMBERT, FAIRFAX WATER SUPERVISOR, ENGINEERING INSPECTION, AT 703-289-6399 AT LEAST ONE WEEK IN ADVANCE OF EXCAVATION FOR VAULT REMOVAL.

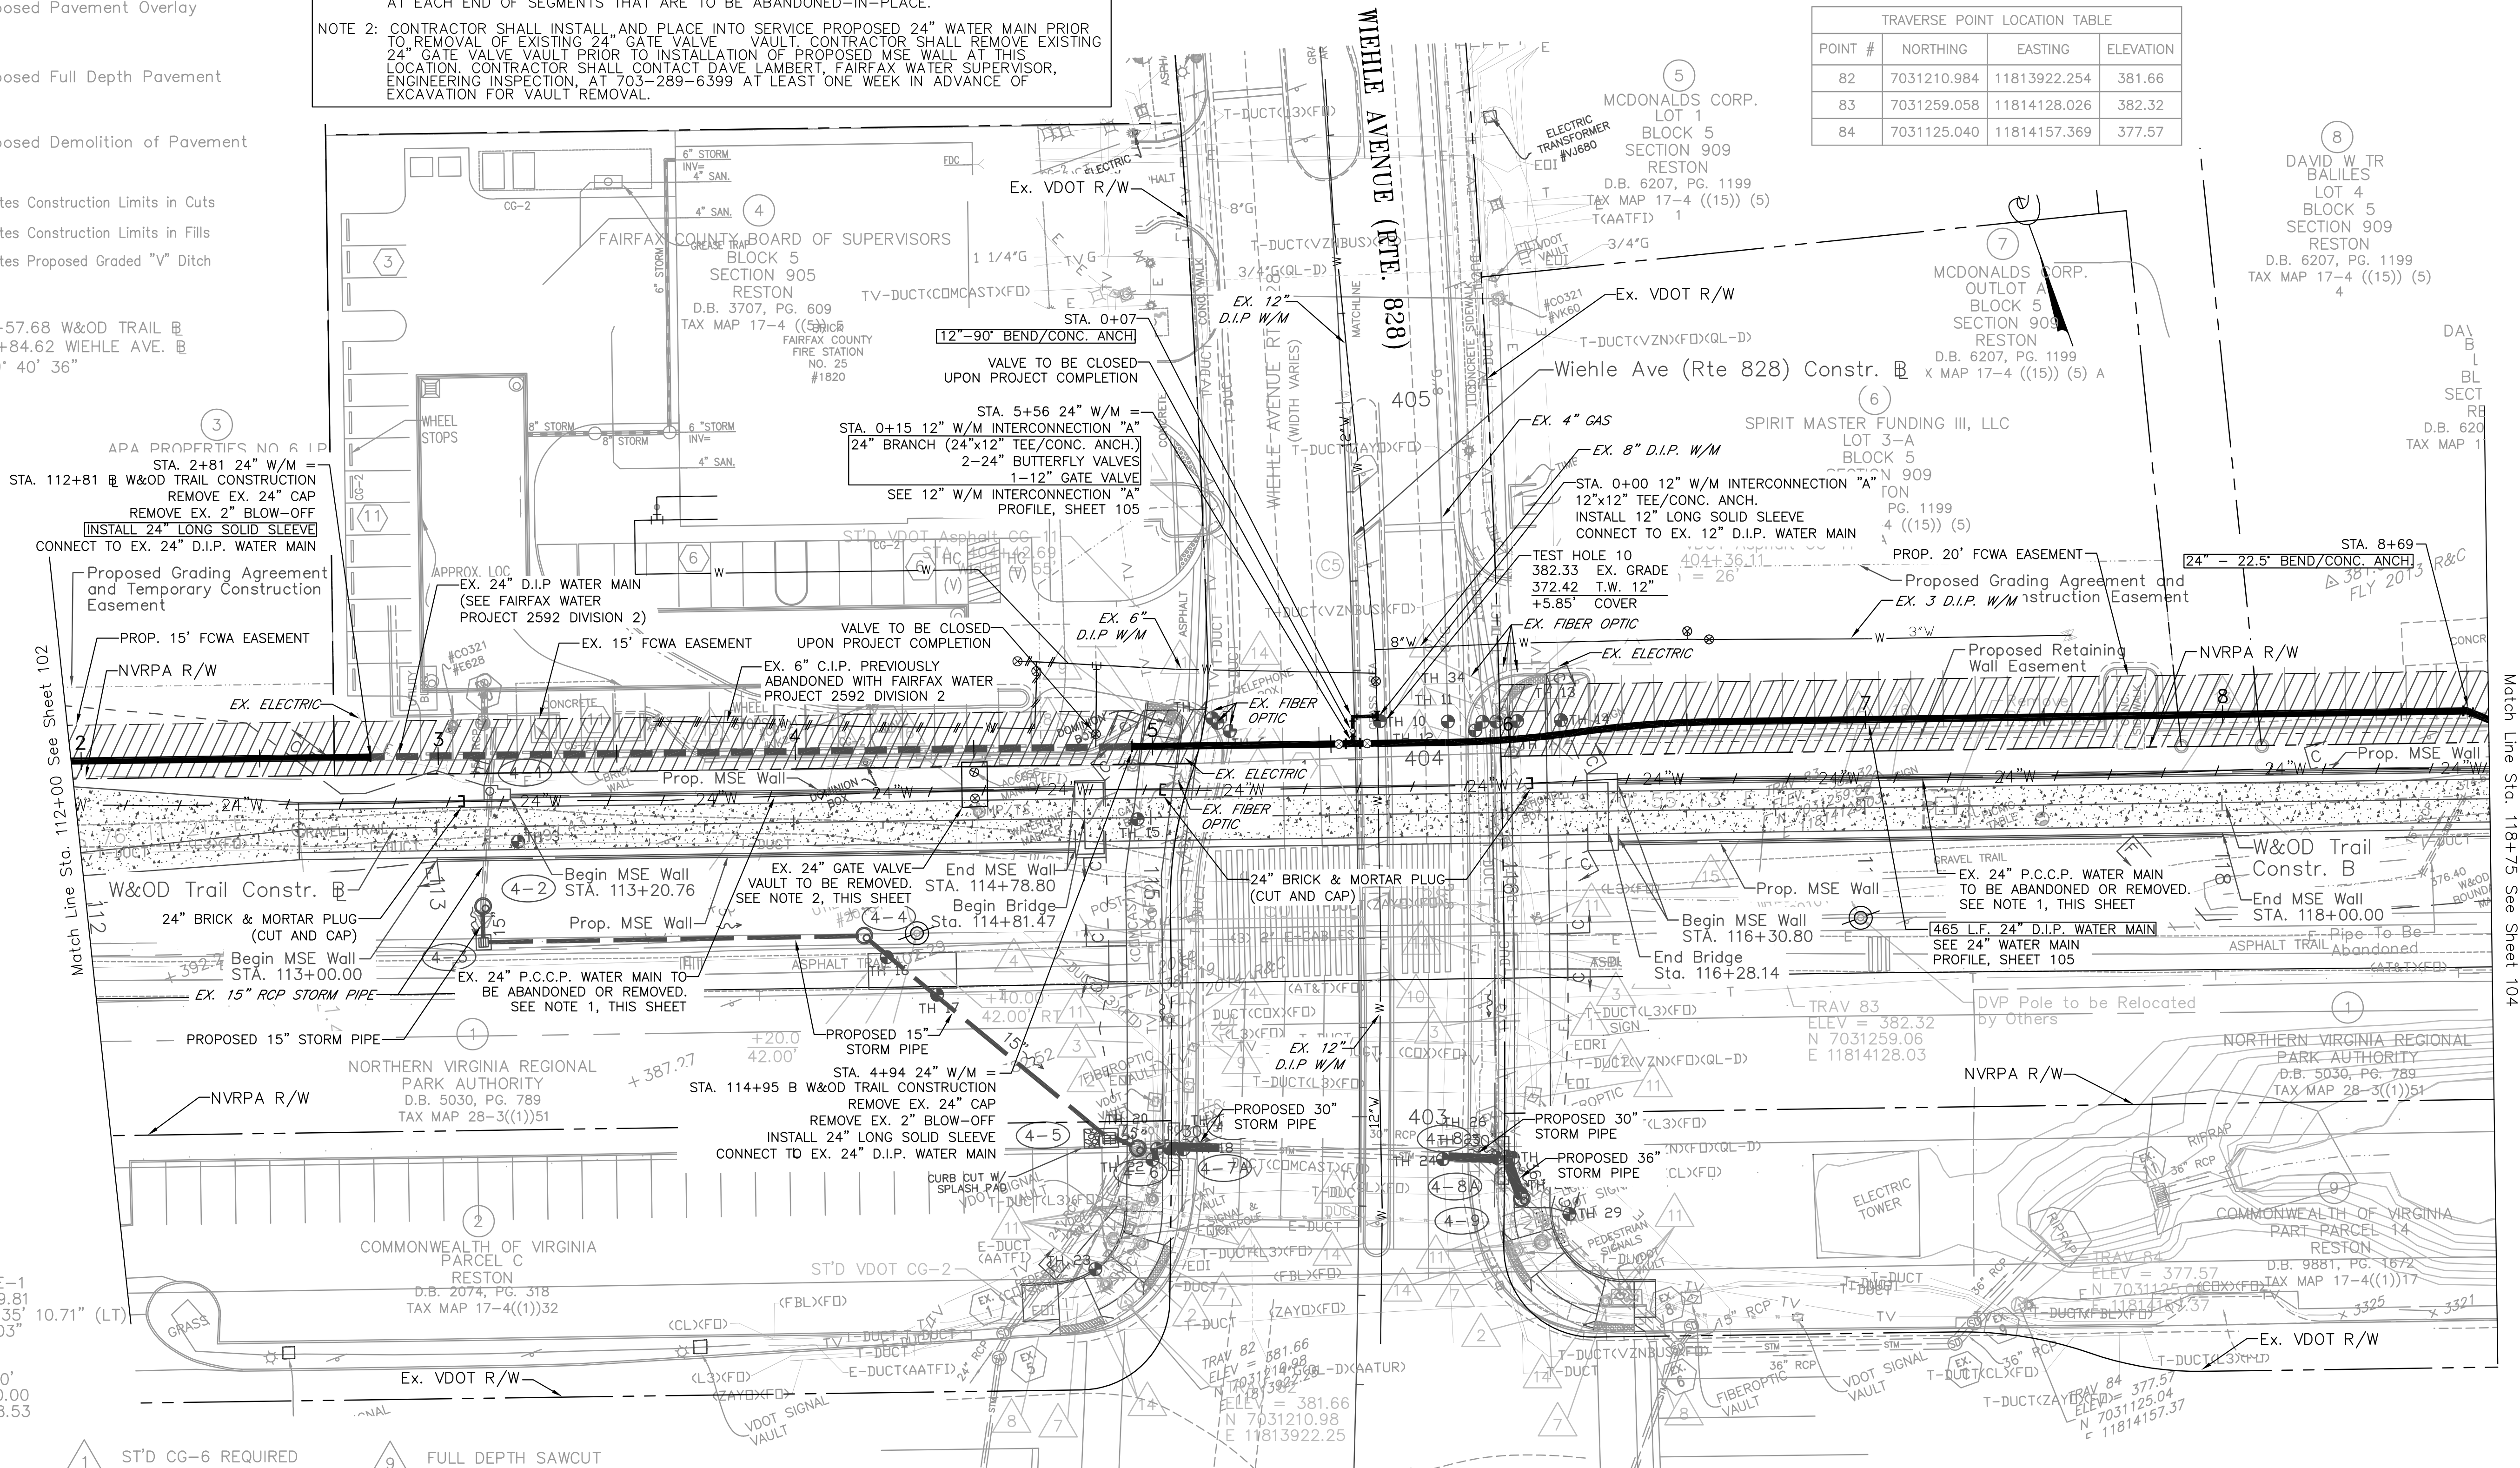TRAVERSE POINT LOCATION TABLE			
POINT #	NORTHING	EASTING	ELEVATION
82	7031210.984	11813922.254	381.66
83	7031259.058	11814128.026	382.32
84	7031125.040	11814157.369	377.57



- |                                       |  |
|---------------------------------------|--|
| 1 ST'D CG-6 REQUIRED                  | 9 FULL DEPTH SAWCUT                            |
| 2 ST'D RADIAL CG-6 REQUIRED           | 10 ST'D MS-2 REQUIRED                          |
| 3 10' WIDE CONCRETE SIDEWALK          | 11 RELOCATE EXISTING UTILITY BY OTHERS         |
| 4 10' WIDE ASPHALT TRAIL              | 12 ST'D VDOT UD-4                              |
| 5 12' WIDE ASPHALT TRAIL              | 13 ST'D VDOT MC-3                              |
| 6 ST'D CG-12 TYPE B MODIFIED REQUIRED | 14 REMOVE EXISTING CURB, CURB RAMP OR SIDEWALK |
| 7 ST'D CG-12 TYPE C REQUIRED          | 15 ST'D VDOT FE-CL                             |
| 8 TIE INTO EXISTING CURB & GUTTER     | 16 RELOCATE EXISTING UTILITY                   |

## NOTES:

- GRADE AROUND TRAIL TO ENSURE POSITIVE DRAINAGE (2:1 MAX, 3:1 PREFERRED).
- IT IS THE CONTRACTOR'S RESPONSIBILITY TO PROTECT FROM HARM OR REPLACE UNDER LICENSED LAND SURVEYOR ALL PROPERTY MONUMENTATION DISTURBED BY CONSTRUCTION.

50% PLANS

THESE PLANS ARE UNFINISHED AND UNAPPROVED  
AND ARE NOT TO BE USED FOR CONSTRUCTION.SCALE  
0 25' 50'

EMERGENCY POLICE - FIRE - RESCUE 911  
FAIRFAX COUNTY, VIRGINIA  
DEPARTMENT OF PUBLIC WORKS AND ENVIRONMENTAL SERVICES  
UTILITY DESIGN & CONSTRUCTION DIVISION  
12000 GOVERNMENT CENTER PARKWAY, SUITE 449, FAIRFAX, VA 22035-0052

OFFICE OF CAPITAL FACILITIES  
703-324-5800WIEHLE AVENUE (RTE 828)  
AT W&OD TRAIL  
PLAN

PROJECT NO. 1400102-2013

SCALE	DESIGNED BY:	RCP	SHEET
HORIZ: 1"=25'	DRAFTED BY:	ARS	103
VERT: N/A	CHECKED BY:	RCC	

FUND NO. 500-C5000



FAIRFAX WATER  
WATER SYSTEM ADJUSTMENTS  
FAIRFAX WATER PROJECT 2592 DIVISION 1

NOTES:

1. GRADE AROUND TRAIL TO ENSURE POSITIVE DRAINAGE (2:1 MAX, 3:1 PREFERRED).

2. IT IS THE CONTRACTOR'S RESPONSIBILITY TO PROTECT FROM HARM OR REPLACE UNDER LICENSED LAND SURVEYOR ALL PROPERTY MONUMENTATION DISTURBED BY CONSTRUCTION.

MICHAEL FARADAY COURT (RTE. 6331)



NOTE 1:	CONTRACTOR IS RESPONSIBLE FOR LOCATING P.C.C.P. PIPE JOINTS PRIOR TO CONSTRUCTING 24" TIE-IN.
NOTE 2:	INTERCONNECTION TO FAIRFAX WATER'S EXISTING TRANSMISSION MAINS WILL ONLY BE BETWEEN OCTOBER 15 AND APRIL 15, UNLESS OTHERWISE APPROVED.
NOTE 3:	CONTRACTOR SHALL INSTALL AND PLACE INTO SERVICE PROPOSED 24" WATER MAIN PRIOR TO ABANDONMENT. CONTRACTOR SHALL ABANDON SEGMENTS OF EXISTING 4" P.C.C.P. WATER MAIN WITHIN LOADING PLANE OF PROPOSED MSE WALL BY FILLING WITH FLOWABLE FILL. CONTRACTOR MAY REMOVE COMPLETELY THOSE SEGMENTS IN LIEU OF FLOWABLE FILL PLACEMENT. CONTRACTOR SHALL INSTALL BRICK AND MORTAR END SEALS (CUT AND CAP) AT EACH END OF SEGMENTS THAT ARE TO BE ABANDONED-IN-PLACE.

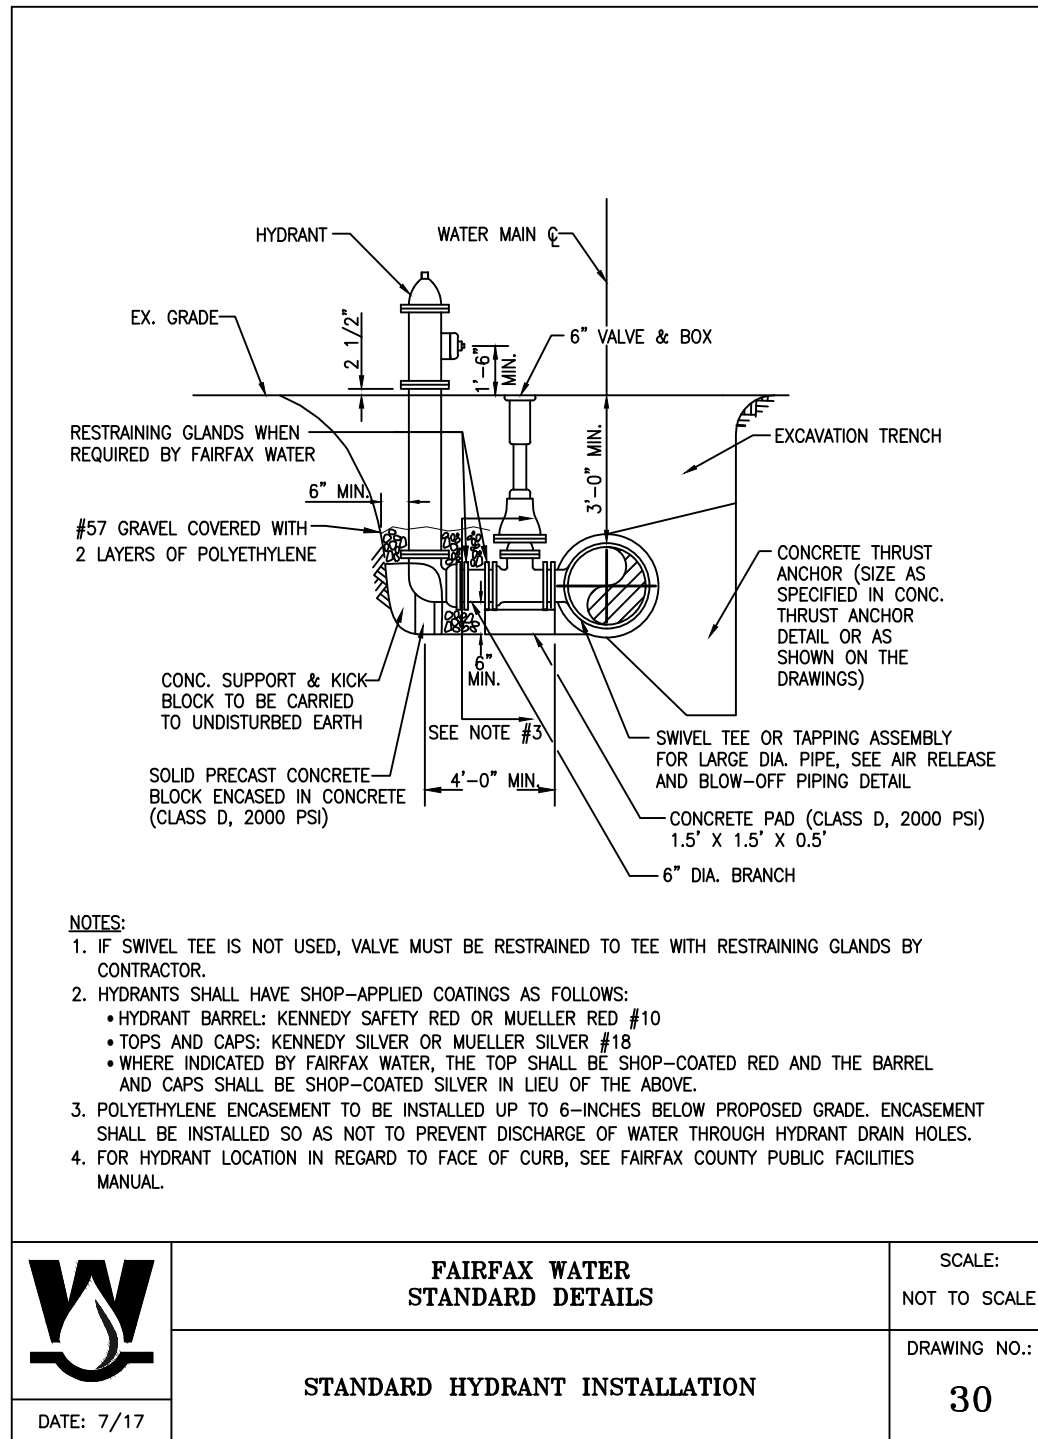
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
<p align="center"> <b>EMERGENCY POLICE – FIRE – RESCUE 911</b>  <b>FAIRFAX COUNTY, VIRGINIA</b>  <b>DEPARTMENT OF PUBLIC WORKS AND ENVIRONMENTAL SERVICES</b>  <b>UTILITY DESIGN &amp; CONSTRUCTION DIVISION</b>  <b>12000 GOVERNMENT CENTER PARKWAY, SUITE 449, FAIRFAX, VA 22035-0052</b> </p>									
R E V I S I O N S						OFFICE OF CAPITAL FACILITIES 703-324-5800			
						WIEHLE AVENUE (RTE 828) AT W&OD TRAIL PLAN			
						PROJECT NO. 1400102-2013			
						<div> <div>SCALE</div> <div>HORIZ: 1"=25'</div> <div>VERT: N/A</div> </div> <div> <div>DESIGNED BY: RCP</div> <div>DRAFTED BY: ARS</div> <div>CHECKED BY: RCC</div> </div> <div>SHEET</div> <div>104</div>			
	△#	DESCRIPTION	BY	APPROVED	DATE				
FUND NO. 500-C50000									







FUND NO. 500-C5000



FAIRFAX WATER  
WATER SYSTEM ADJUSTMENTS  
FAIRFAX WATER PROJECT 2592 DIVISION 1



	<p align="center"><b>FAIRFAX WATER STANDARD DETAILS</b></p>	<p>SCALE: NOT TO SCALE</p>
	<p align="center"><b>CONCRETE THRUST ANCHORS</b></p>	<p>DRAWING NO.: <b>23</b></p>
<p>DATE: 7/17</p>		

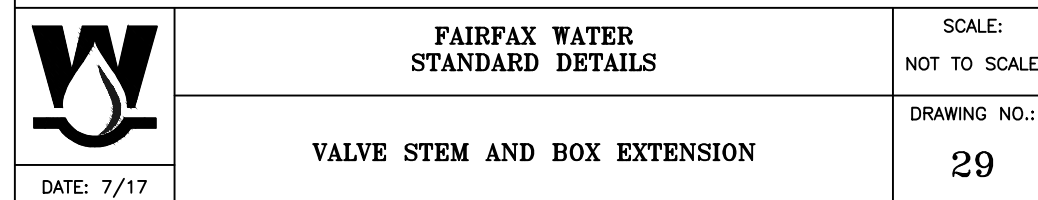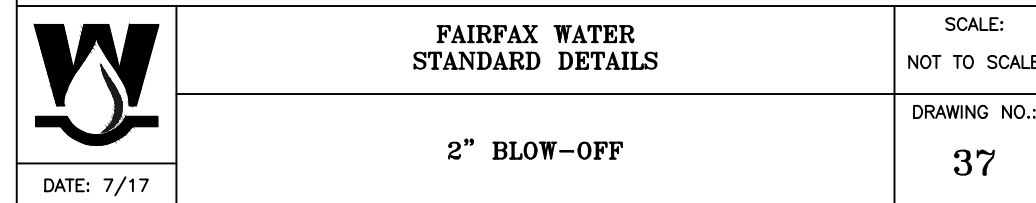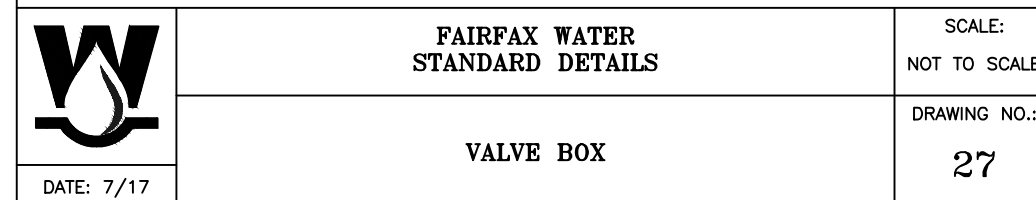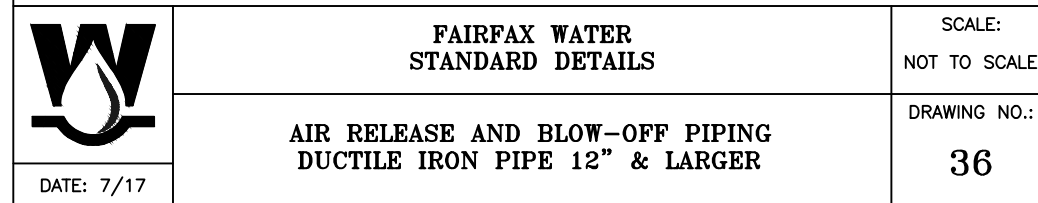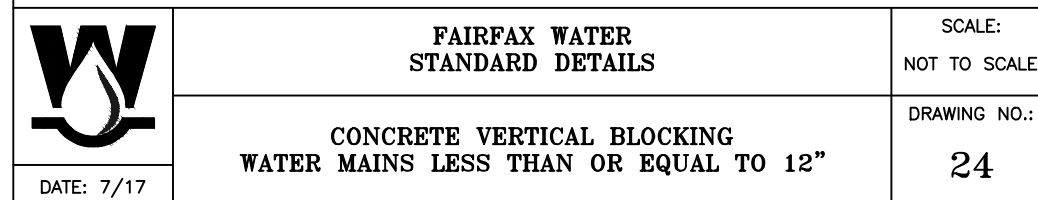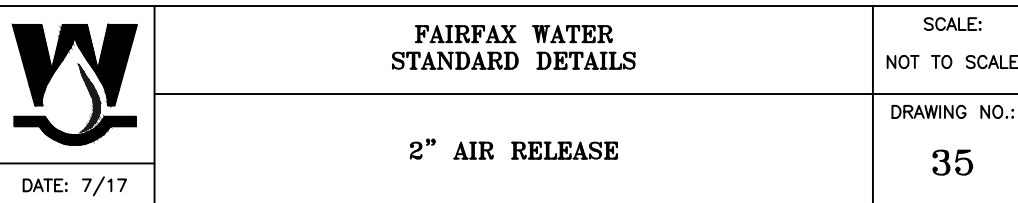

EMERGENCY POLICE – FIRE – RESCUE 911										
FAIRFAX COUNTY, VIRGINIA										
DEPARTMENT OF PUBLIC WORKS AND ENVIRONMENTAL SERVICES										
UTILITY DESIGN & CONSTRUCTION DIVISION										
12000 GOVERNMENT CENTER PARKWAY, SUITE 449, FAIRFAX, VA 22035-0052										
R E V I S I O N						OFFICE OF CAPITAL FACILITIES 703-324-5800				
						WIEHLE AVENUE (RTE 828) AT W&OD TRAIL				
						MISCELLANEOUS DETAILS				
						PROJECT NO. 1400102-2013				
						SCALE		SHEET		
						HORIZ: N/A		DESIGNED BY: RCP	107	
						VERT:		DRAFTED BY: ARS		
								CHECKED BY: RCC		
		△#	DESCRIPTION	BY	APPROVED	DATE				

FUND NO. 500-C5000

THESE PLANS ARE UNFINISHED AND UNAPPROVED  
AND ARE NOT TO BE USED FOR CONSTRUCTION.

FUND NO. 500-C5000



PROJECT MANAGER \_ SCOTT RUFFNER, P.E., (703) 877-5736 \_ \_ \_ \_ \_  
SURVEYED BY, DATE \_ FAIRFAX COUNTY, NOVEMBER 28, 2014 \_ \_ \_ \_ \_  
DESIGN BY \_ WHITMAN, REQUARDT & ASSOCIATES, LLP, (703) 293-9717 \_ \_ \_  
SUBSURFACE UTILITY BY, DATE \_ SO DEEP, INC., (703) 361-6005, DECEMBER 23, 2014

INDEX OF SHEETS - CROSS SECTIONS

SHEET NO.	DESCRIPTION	STATIONS
XS-1	INDEX OF SHEETS - CROSS SECTIONS	
XS-2 THRU XS-20	CROSS SECTIONS W&OD TRAIL	STA.108+25.00 TO STA.123+25.00
XS-21 THRU XS-24	CROSS SECTIONS WIEHLE AVENUE (RTE.828)	STA.402+25.00 TO STA.405+25.00

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EMERGENCY POLICE - FIRE - RESCUE 911				
FAIRFAX COUNTY, VIRGINIA				
DEPARTMENT OF PUBLIC WORKS AND ENVIRONMENTAL SERVICES				
12000 GOVERNMENT CENTER PARKWAY, SUITE 449 FAIRFAX, VA., 22035-0052				
R E V I S I O N S				
OFFICE OF CAPITAL FACILITIES 703-324-5800				
WIEHLE AVENUE (RTE 828) AT W&OD TRAIL INDEX OF SHEETS - CROSS SECTIONS				
PROJECT NO: 1400102-2013				
SCALE NTS		DESIGNED: NDD DRAFTED: WRA CHECKED: RBH		SHEET XS-1
APPROVED BY THE TRANSPORTATION DESIGN DIVISION				

FUND # 500-C5000



PROJECT MANAGER SCOTT RUFFNER, P.E. (703) 187-5736 \_ \_ \_  
SURVEYED BY, DATE FAIRFAX COUNTY, NOVEMBER 28, 2014 \_ \_  
DESIGN BY WHITMAN, REQUABDT & ASSOCIATES, LLP (703) 293-9717  
SUBSURFACE UTILITY BY, DATE SO DEEP, INC. (703) 361-6005 \_


## CROSS SECTIONS

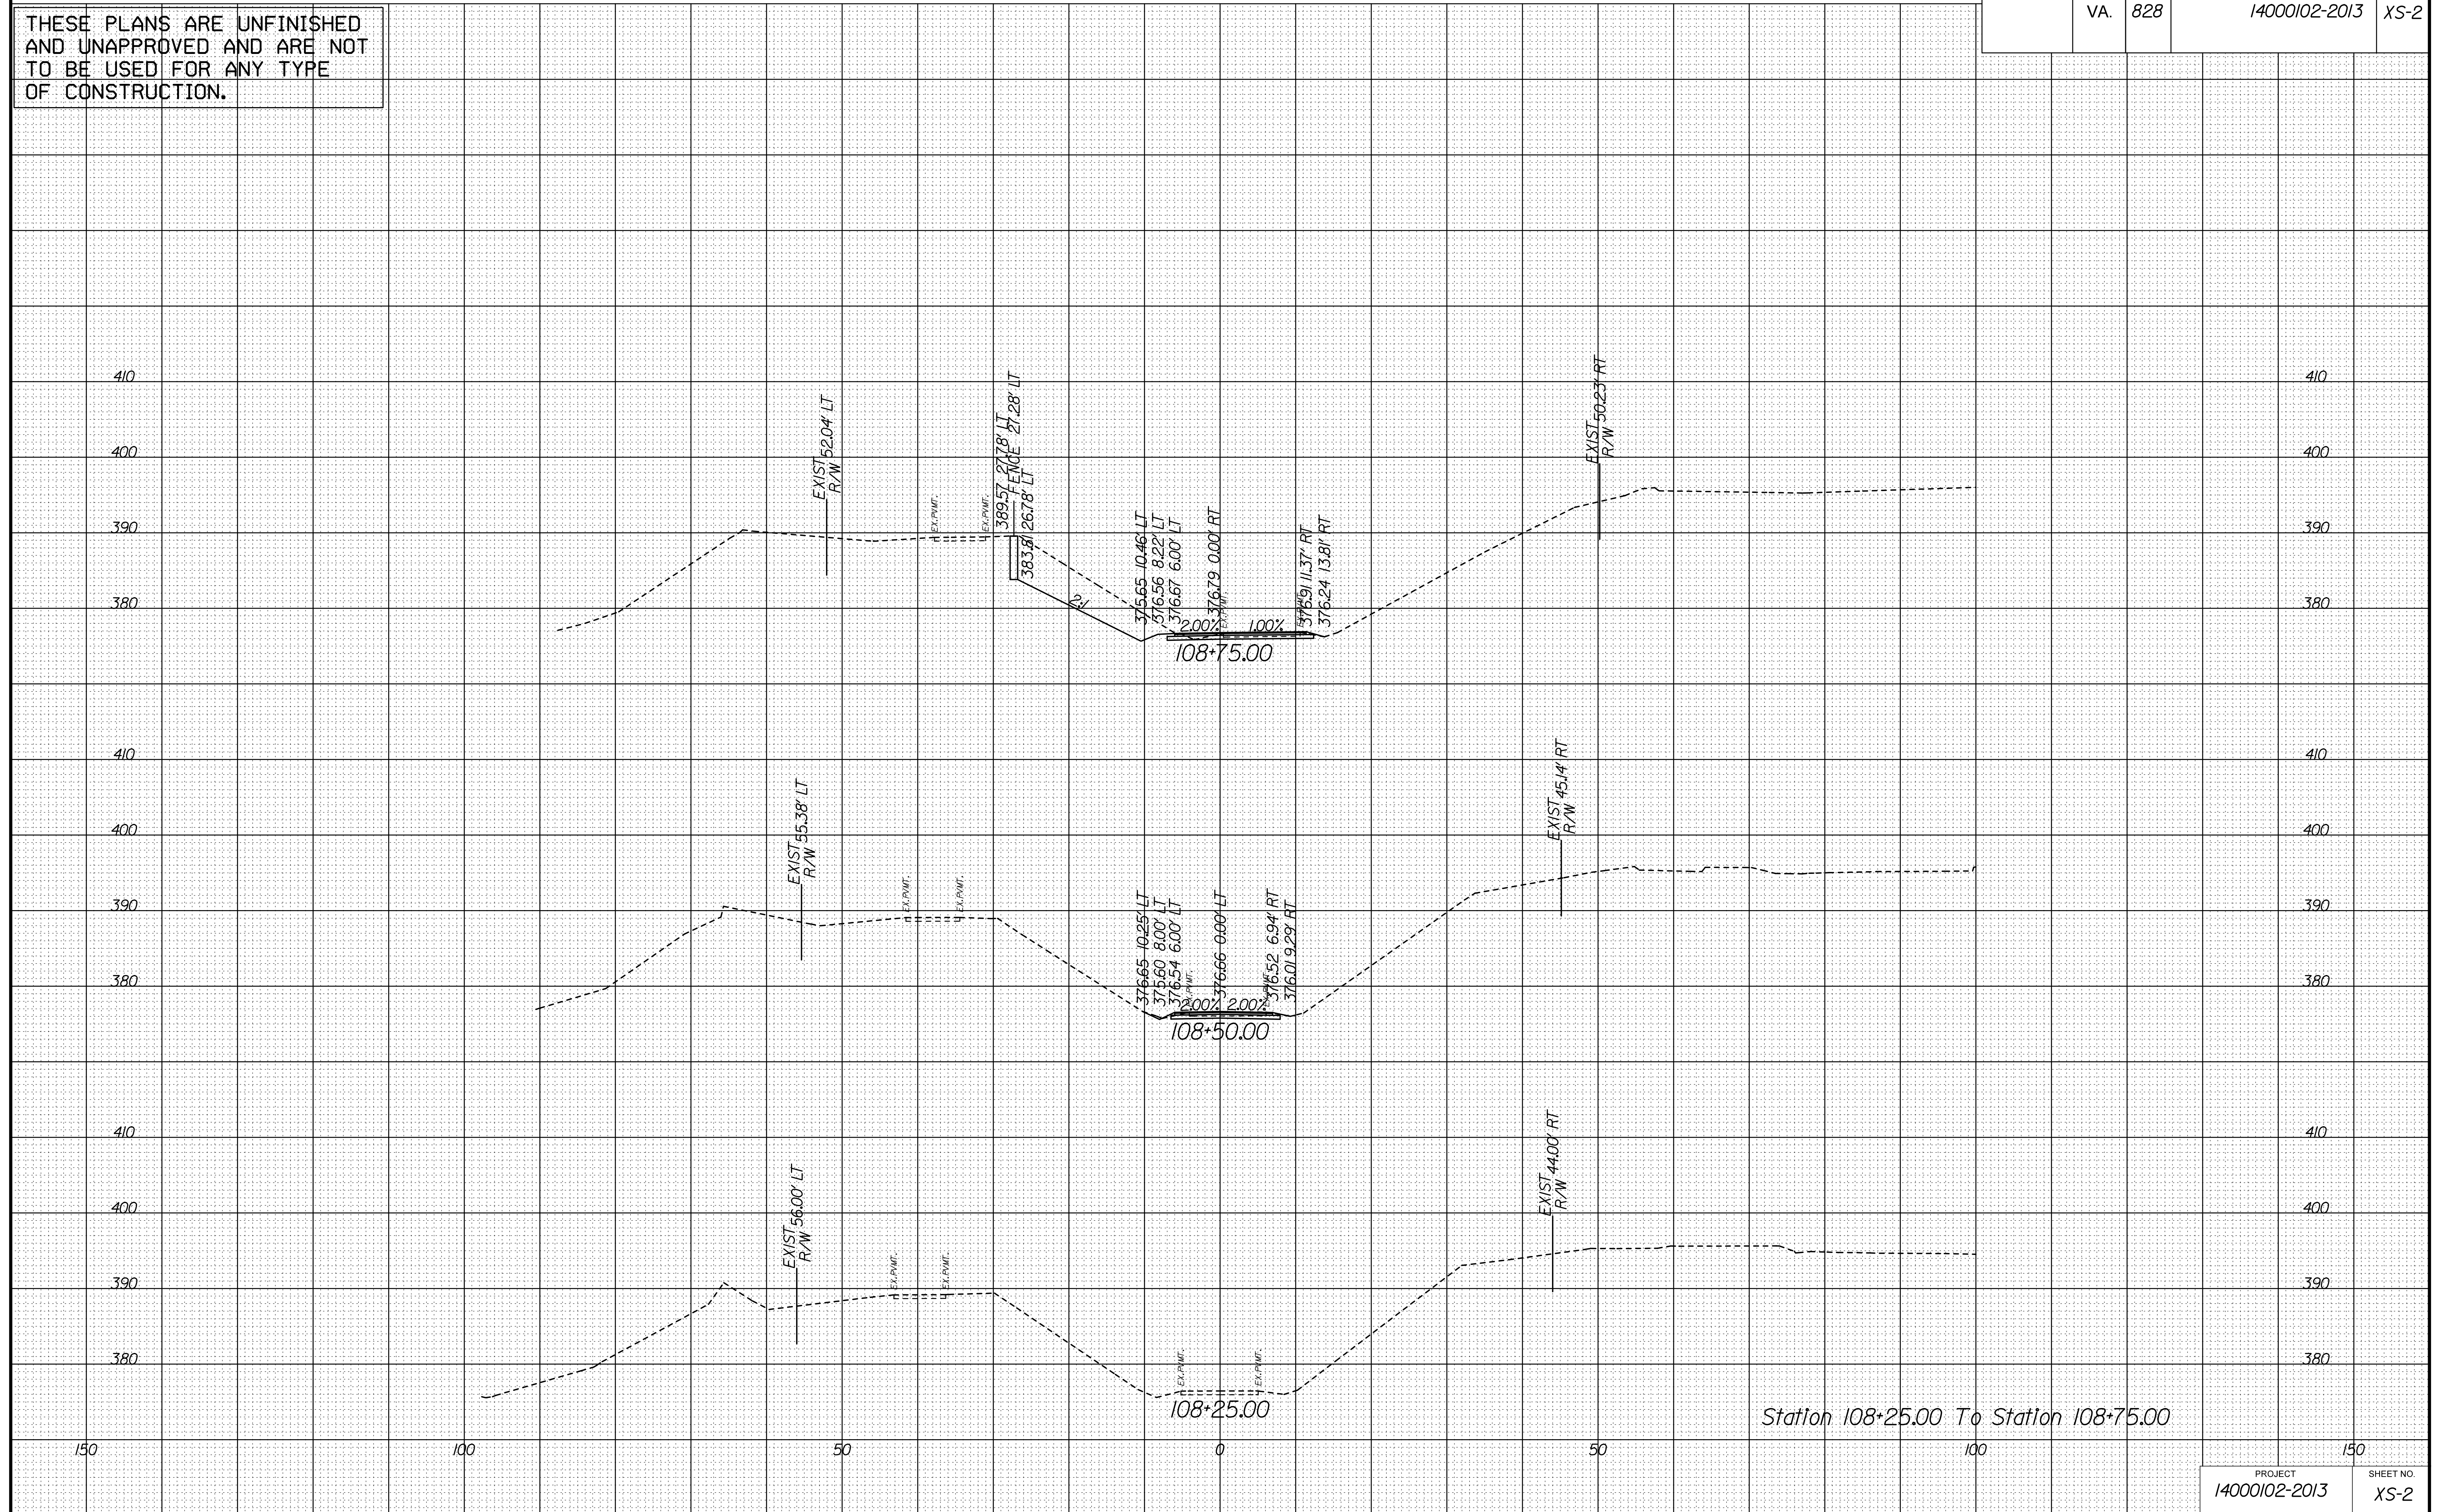SCALE 1 IN. = 10 FT

DESIGN FEATURES RELATING TO CONSTRUCTION  
OR TO REGULATION AND CONTROL OF TRAFFIC  
MAY BE SUBJECT TO CHANGE AS DEEMED  
NECESSARY BY THE DEPARTMENT

IN C	REVISED	STATE			SHEET NO
	STATE	ROUTE	PROJECT		
		VA.	828	14000102-2013	XS-2

THESE PLANS ARE UNFINISHED	
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OF CONSTRUCTION.	



5/29/2018




PROJECT MANAGER SCOTT RUEFNEB, P.E. 17031872-5736 ---  
SURVEYED BY, DATE FAIRFAX COUNTY, NOVEMBER 28, 2014. --  
DESIGN BY WHITMAN, REQUARDT, & ASSOCIATES, LLP 17031293-9717  
SUBSURFACE UTILITY BY, DATE SQ DEEP, INC. 17031361-6005.

CROSS SECTIONS  
SCALE 1 IN. = 10 FT

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REVISED	STATE	STATE		SHEET NO.
		ROUTE	PROJECT	
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OF CONSTRUCTION.



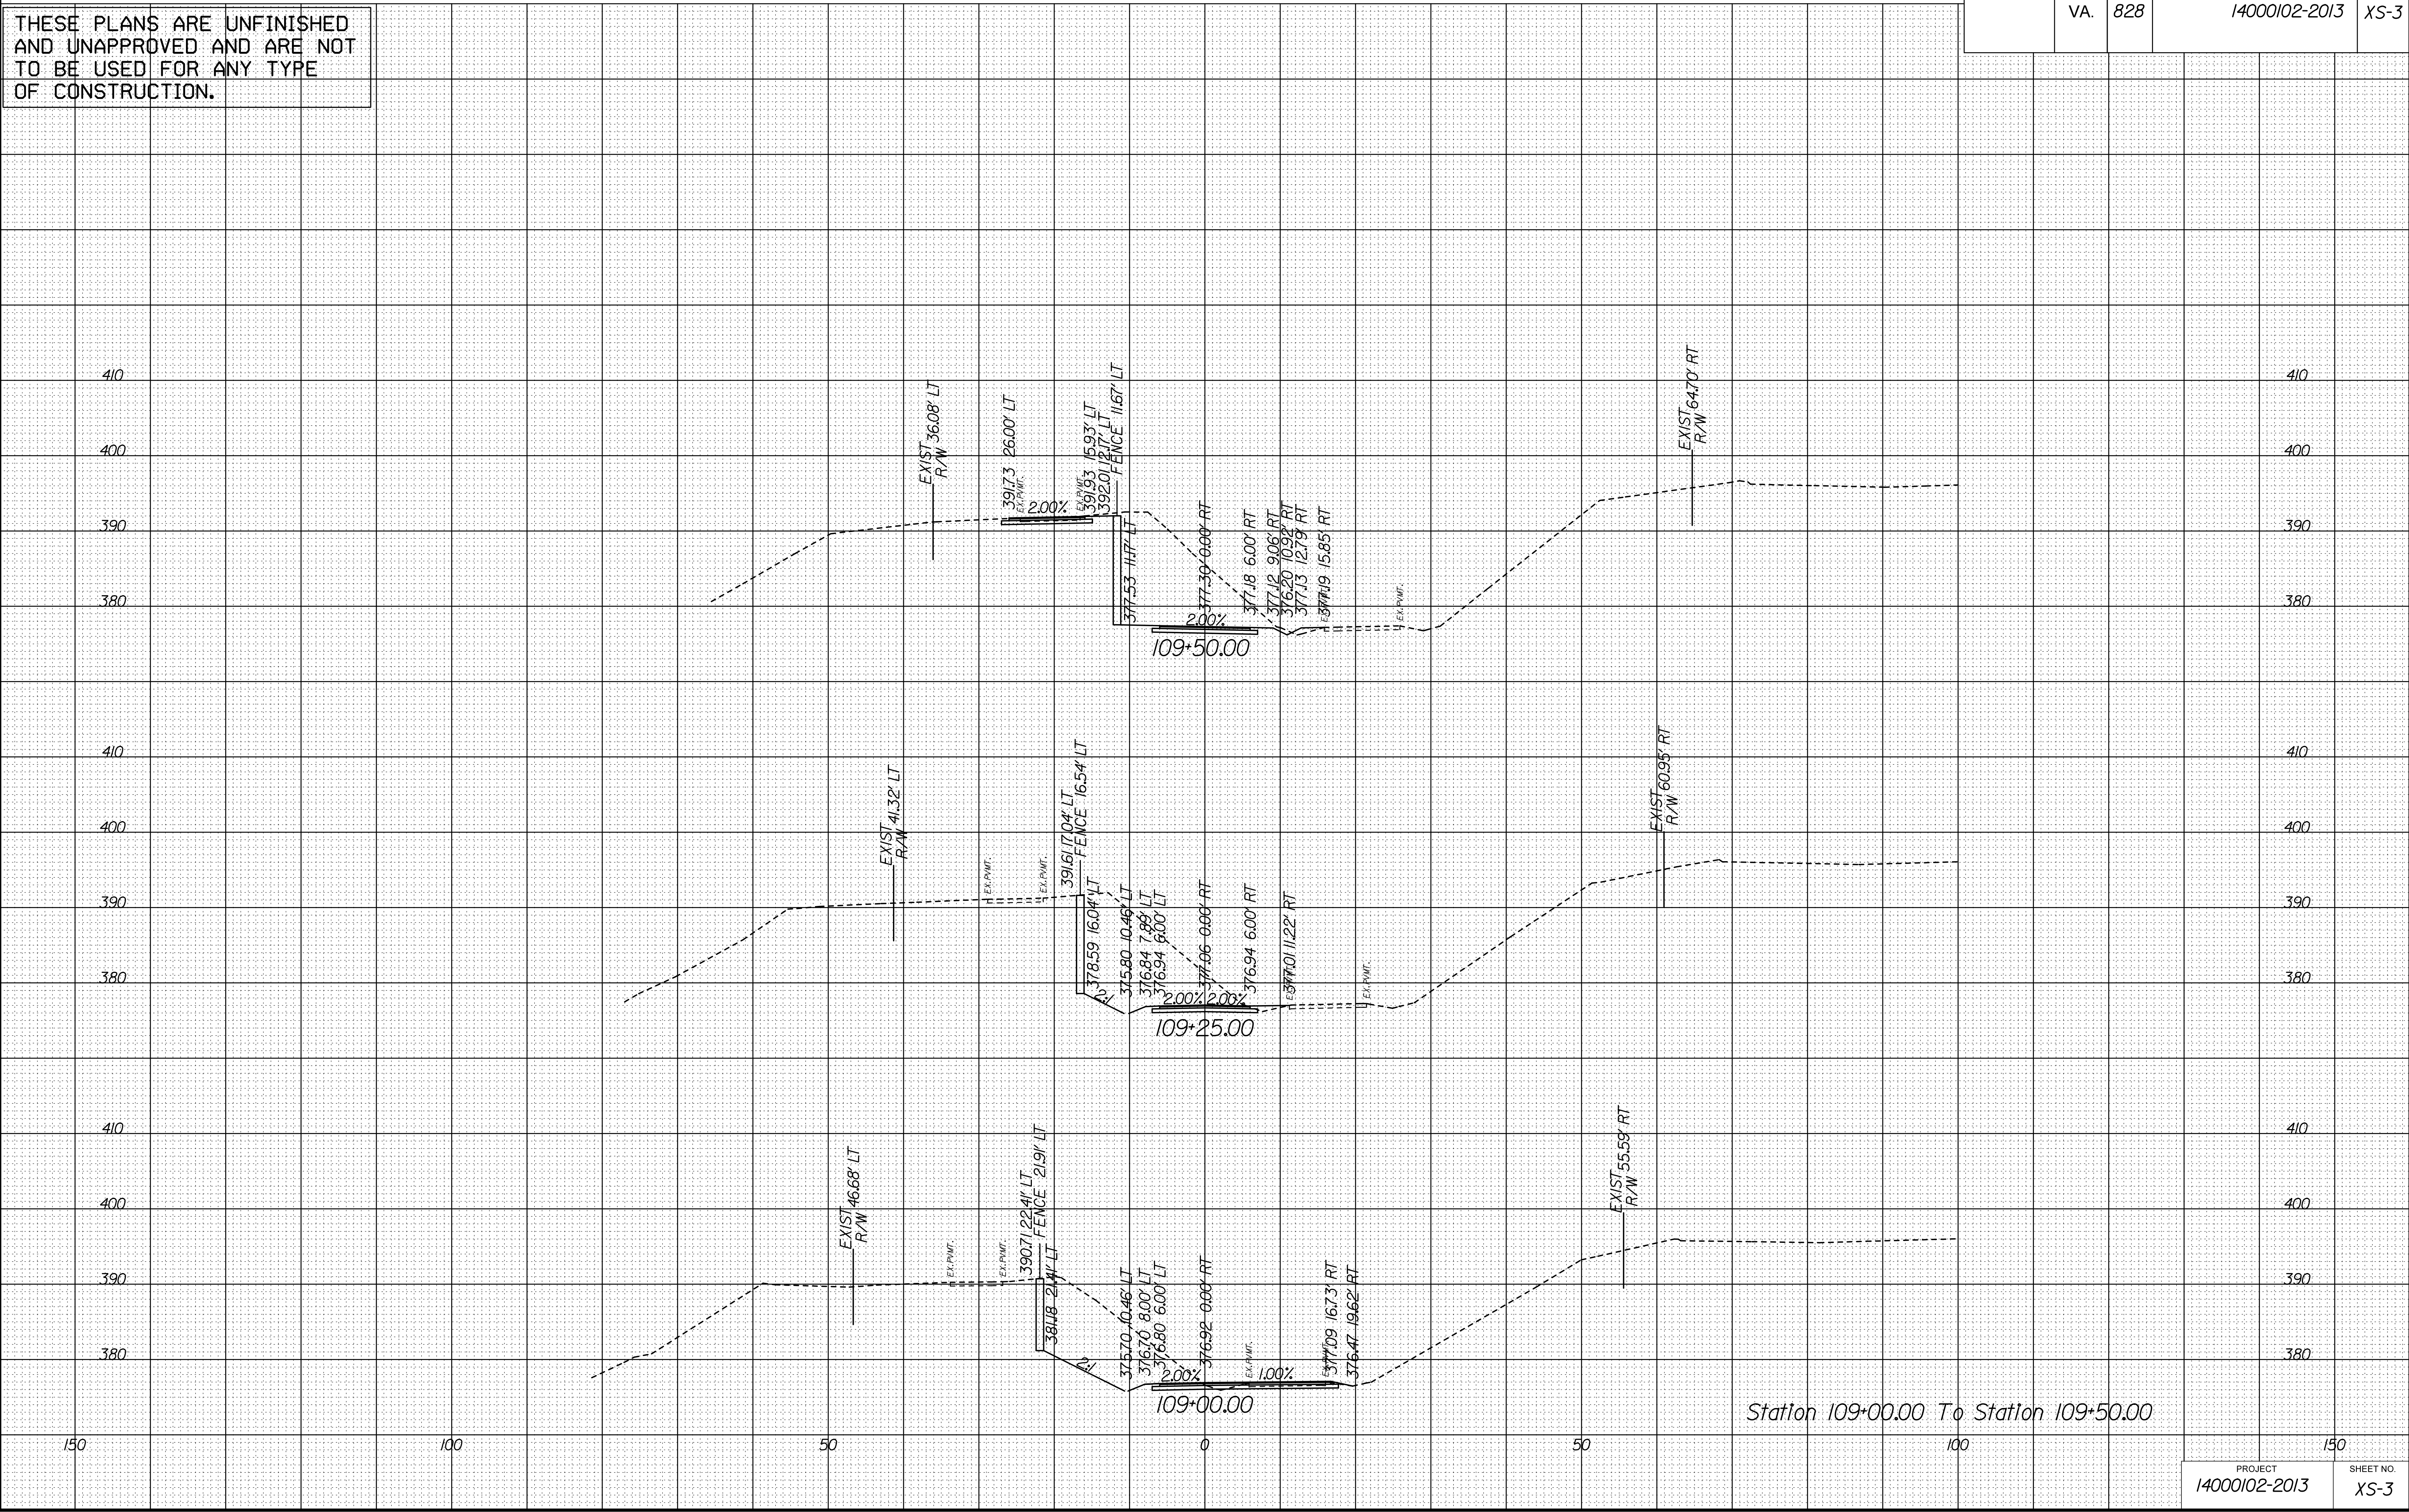


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SURVEYED BY, DATE FAIRFAX COUNTY, NOVEMBER 28, 2014. --  
DESIGN BY WHITMAN, REQUARDT, & ASSOCIATES, LLP 17031293-9717  
SUBSURFACE UTILITY BY, DATE SQ DEEP, INC. 17031361-6005.

CROSS SECTIONS  
SCALE 1 IN. = 10 FT

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REVISED	STATE	STATE		SHEET NO.
		ROUTE	PROJECT	
	VA.	828	14000102-2013	XS-4
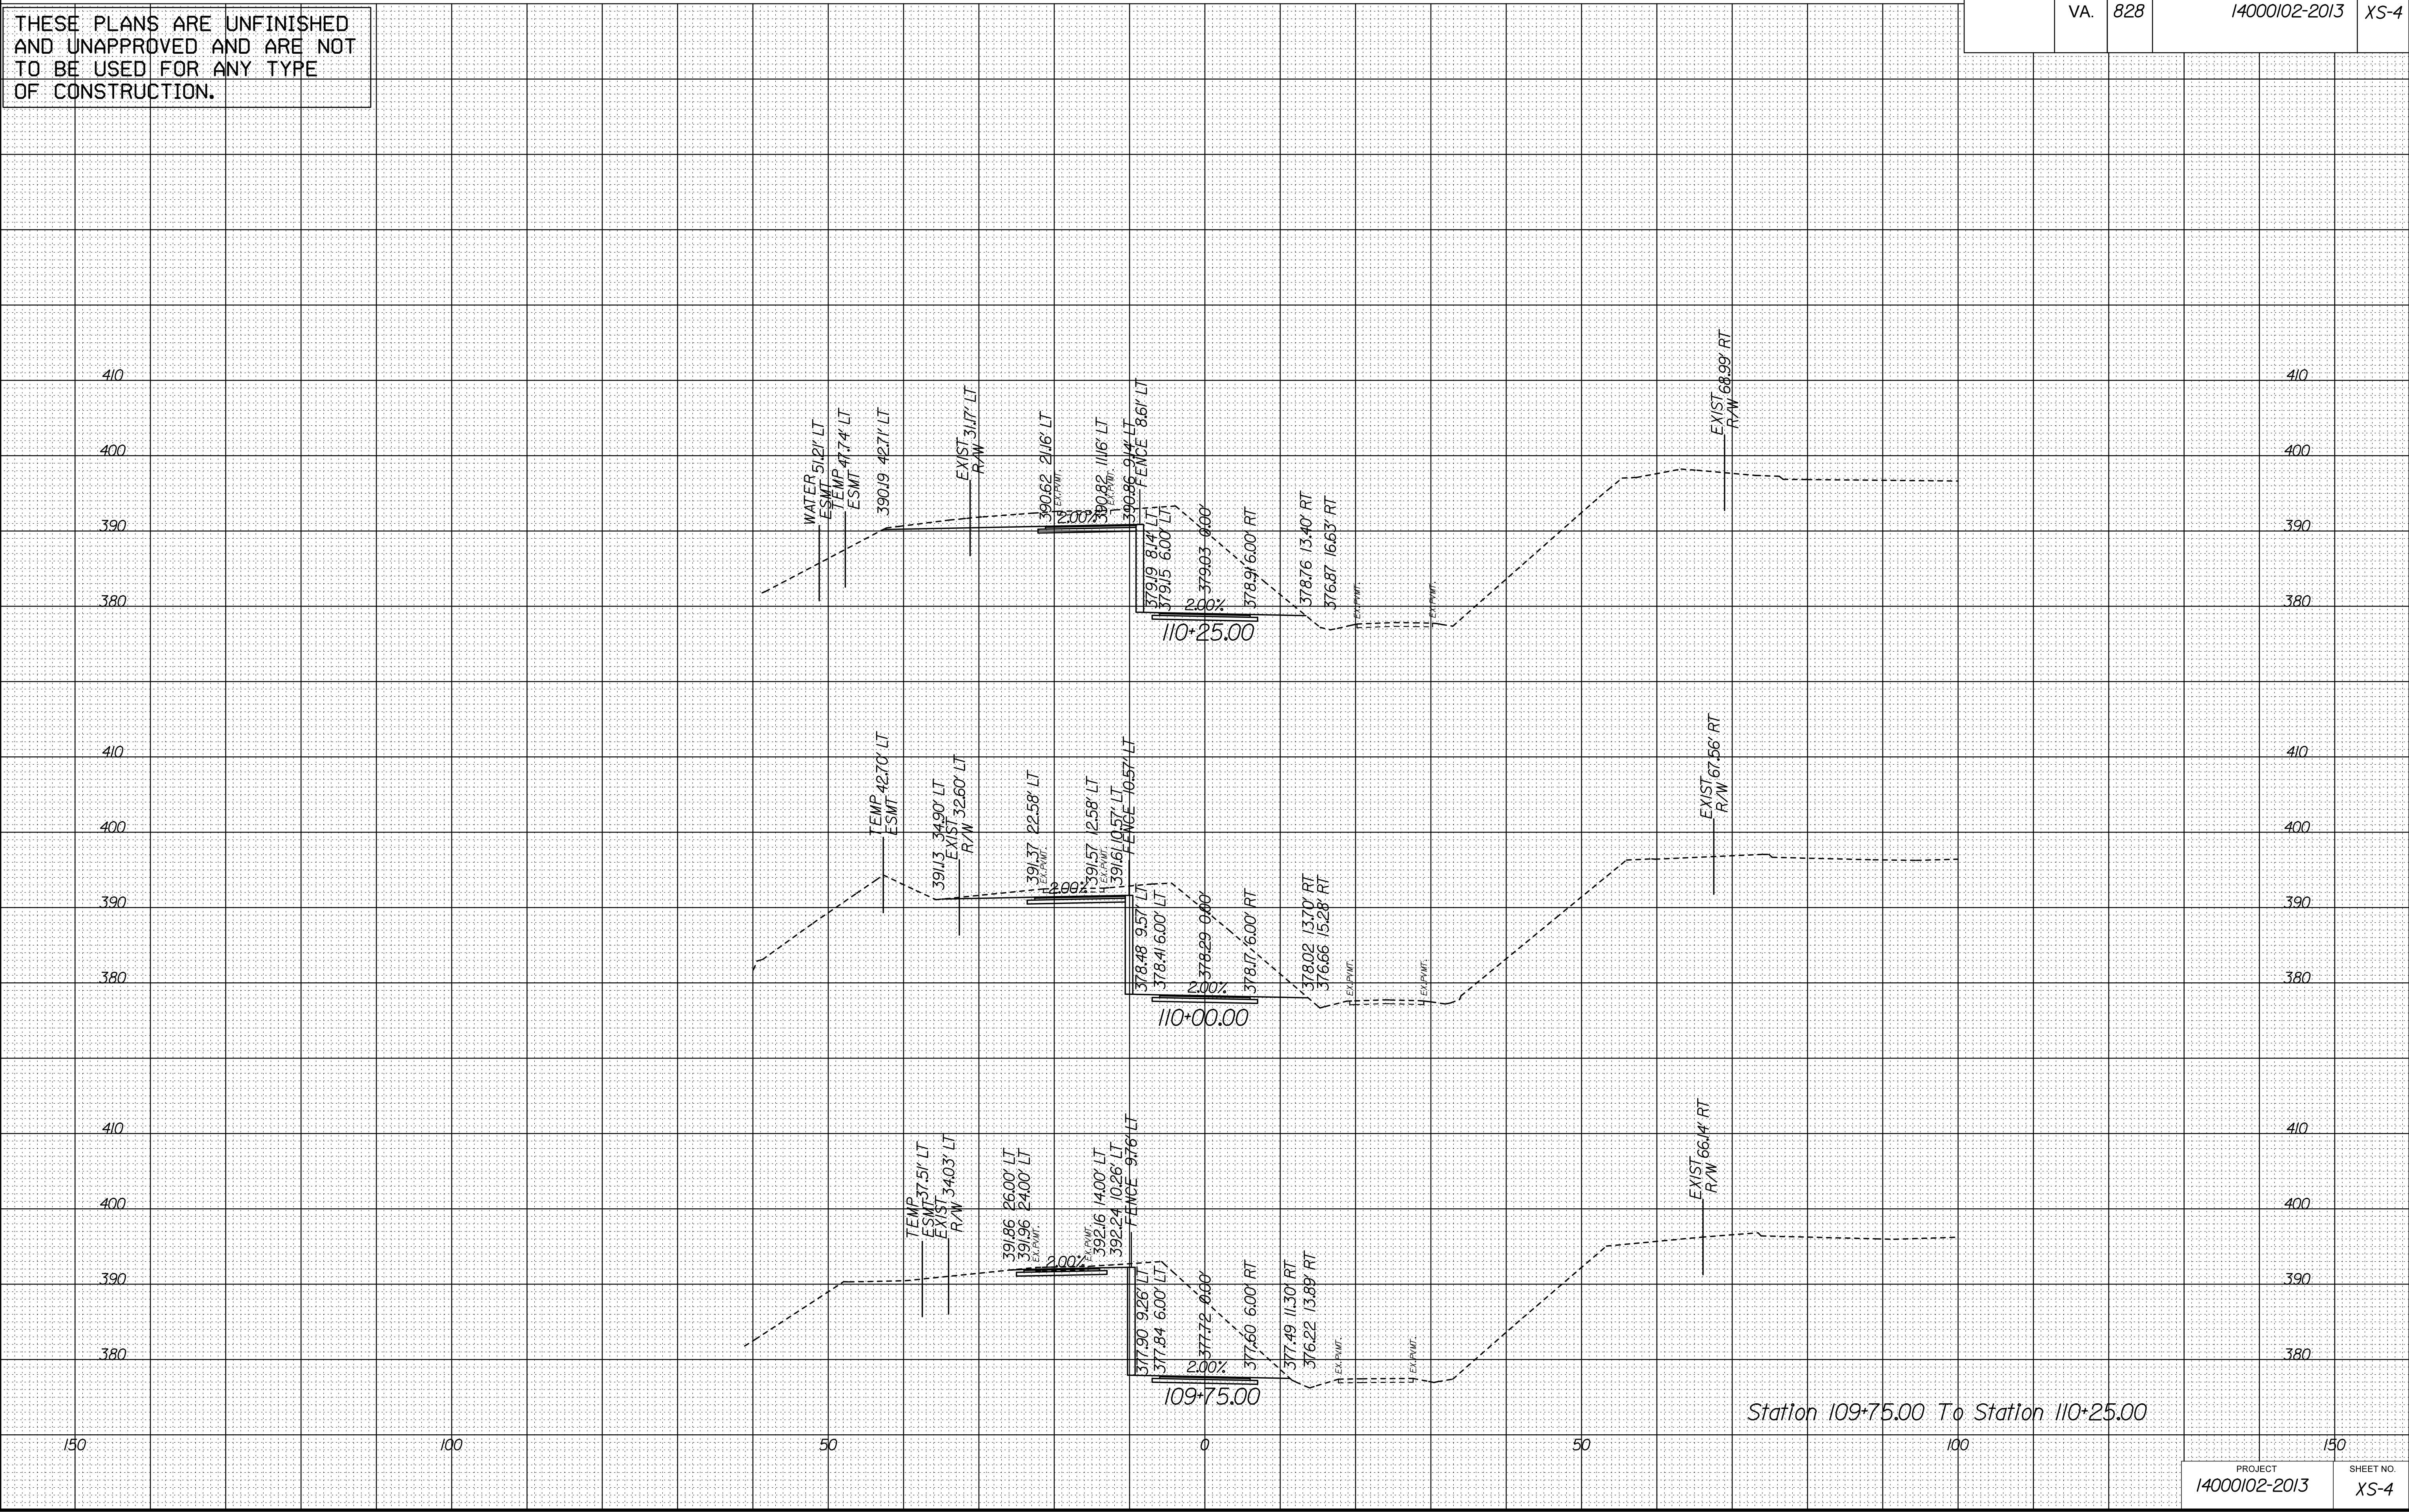
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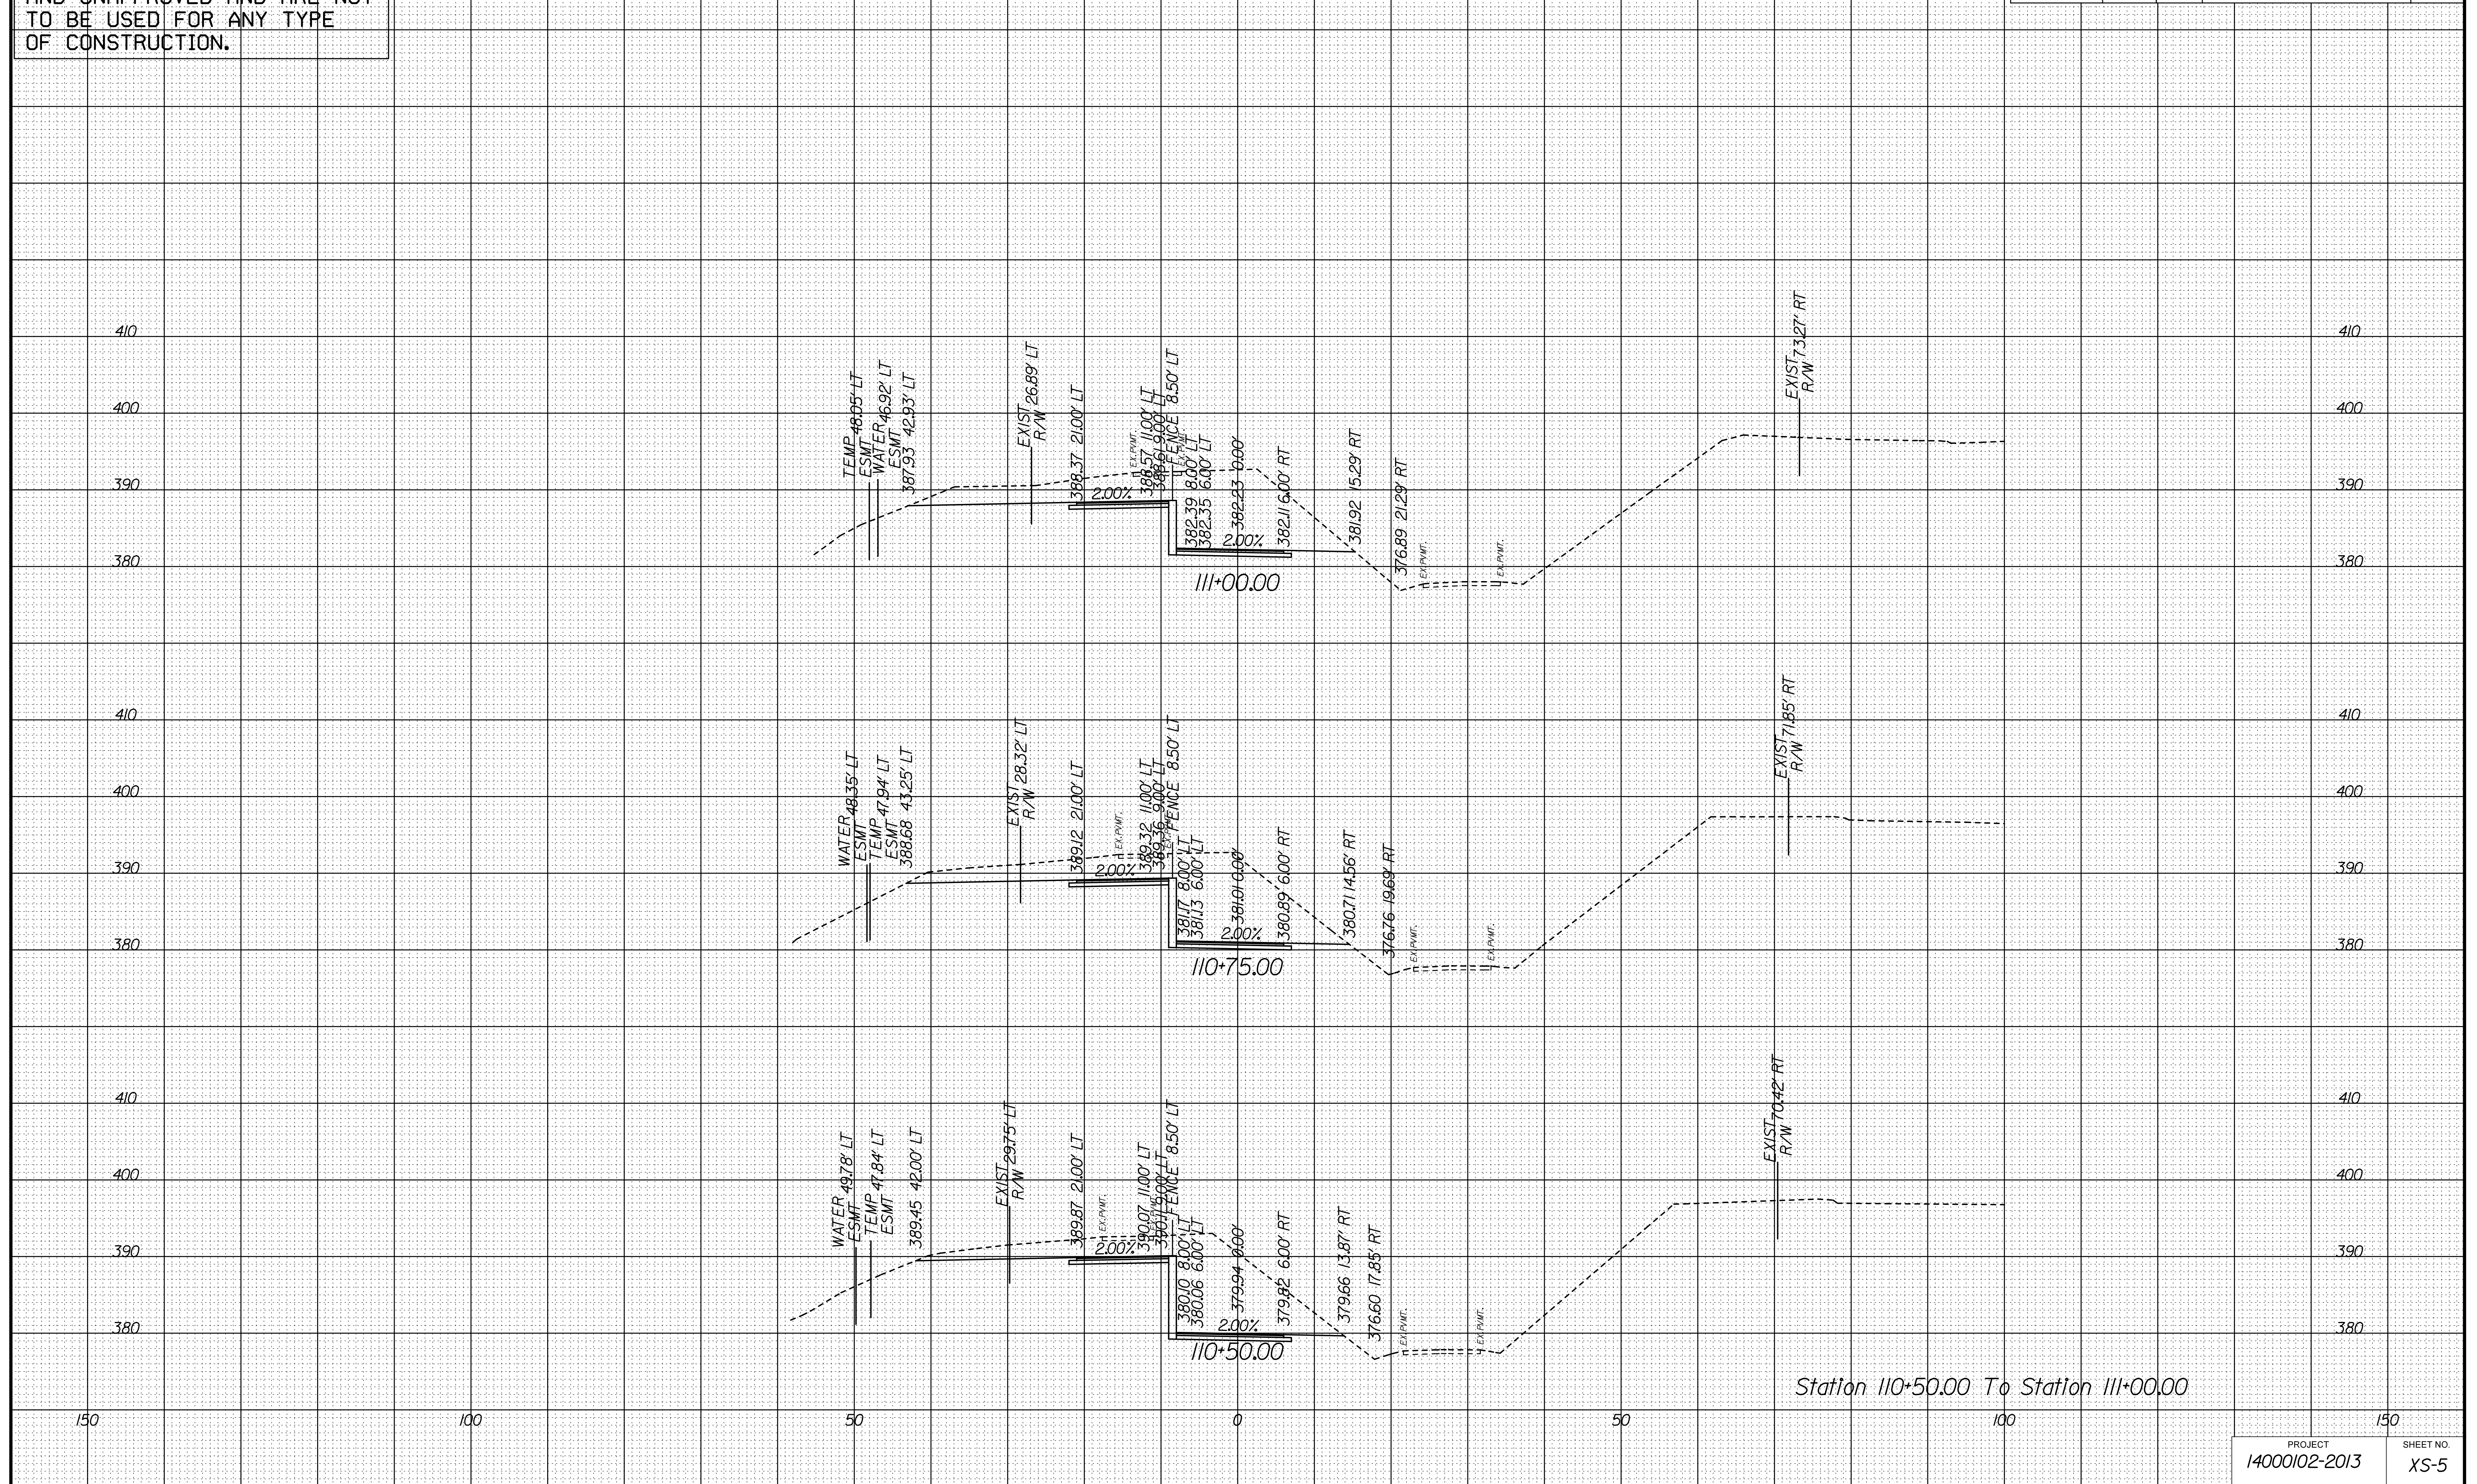
## CROSS SECTIONS

SCALE 1 IN. = 10 FT

DESIGN FEATURES RELATING TO CONSTRUCTION  
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IN	REVISED	STATE	STATE		SHEET NO.
			ROUTE	PROJECT	
		VA.	828	14000102-2013	XS-5

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PROJECT MANAGER SCOTT RUFFNER, P.E. (703) 877-5736 --  
SURVEYED BY, DATE FAIRFAX COUNTY, NOVEMBER 28, 2014 --  
DESIGN BY WHITMAN, REQUARDT & ASSOCIATES, LLP (703) 293-9717  
SUBSURFACE UTILITY BY, DATE SQ DEEP, INC. (703) 361-6005 .


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SCALE 1 IN. = 10 FT

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REVISED	STATE	STATE		SHEET NO.
		ROUTE	PROJECT	
VA.	828	14000102-2013		XS-6

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PROJECT MANAGER SCOTT RUEFNER, P.E. (703) 877-5736 \_ \_ \_  
SURVEYED BY, DATE FAIRFAX COUNTY, NOVEMBER 28, 2014 \_ \_  
DESIGN BY WHITMAN, REQUARDT & ASSOCIATES, LLP (703) 293-9717  
SUBSURFACE UTILITY BY, DATE SQ DEEP, INC. (703) 361-6005 \_


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SCALE 1 IN. = 10 FT

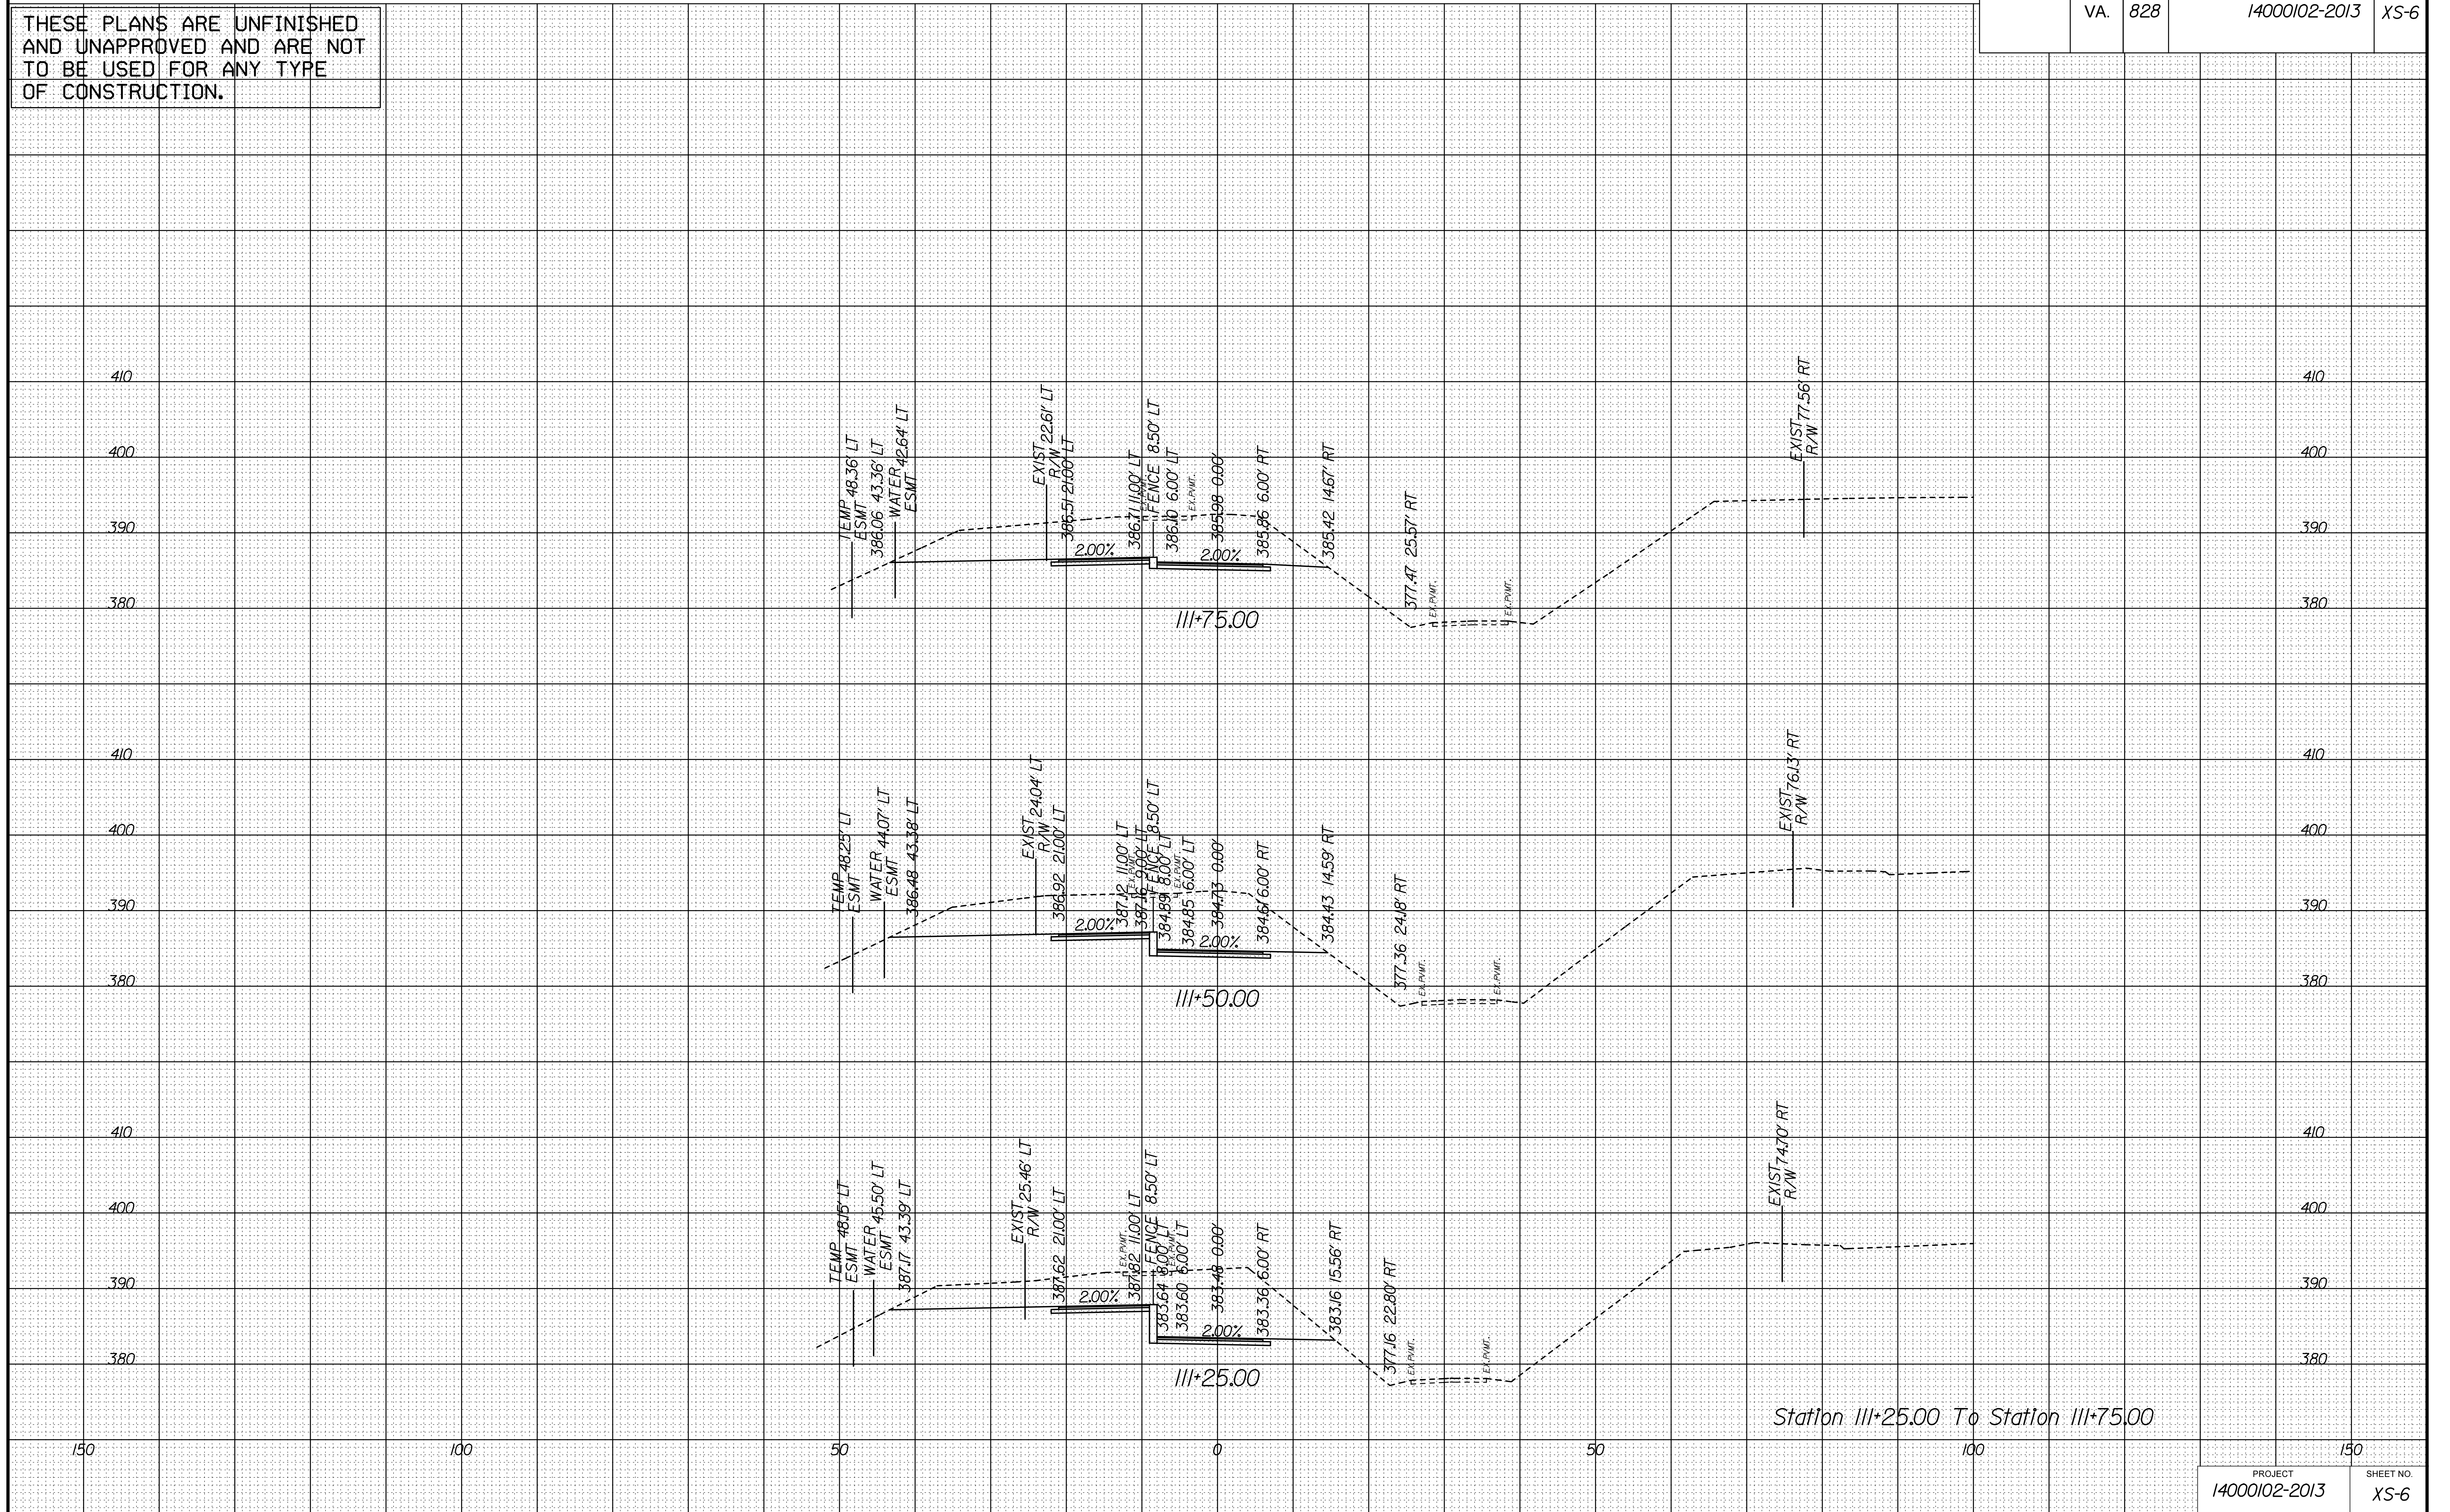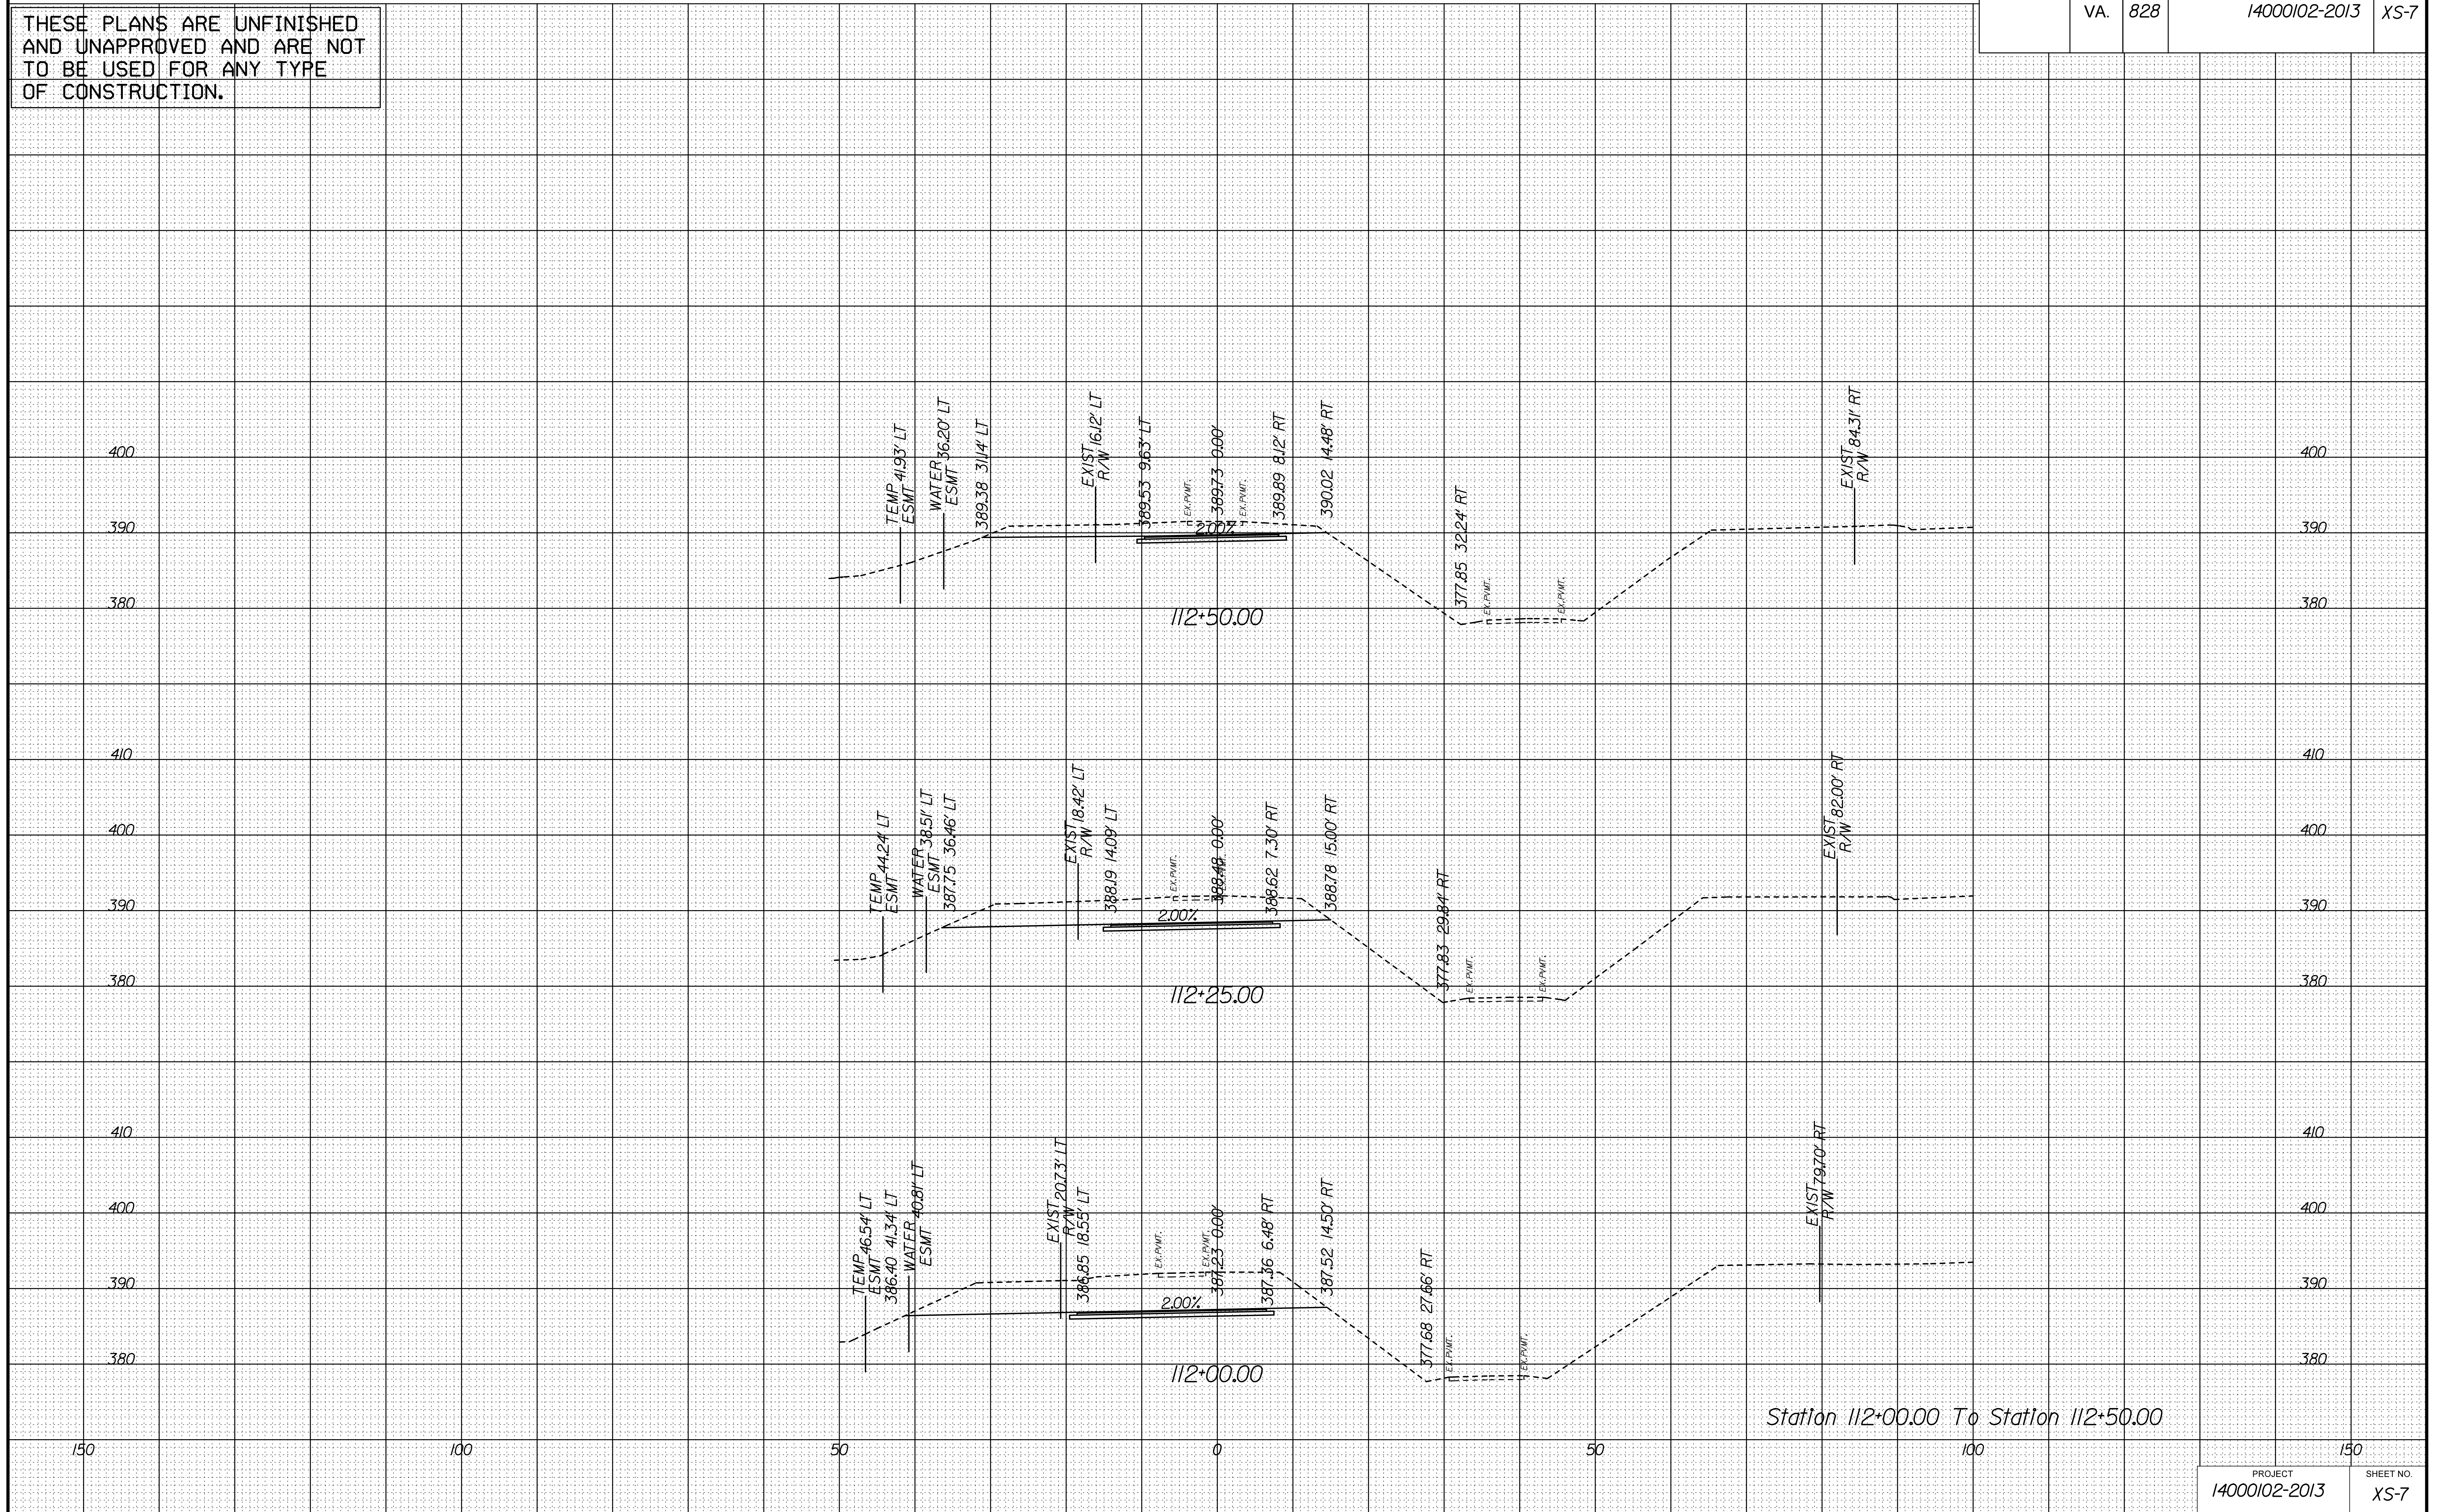DESIGN FEATURES RELATING TO CONSTRUCTION  
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N	REVISED	STATE	STATE		SHEET NO.
			ROUTE	PROJECT	
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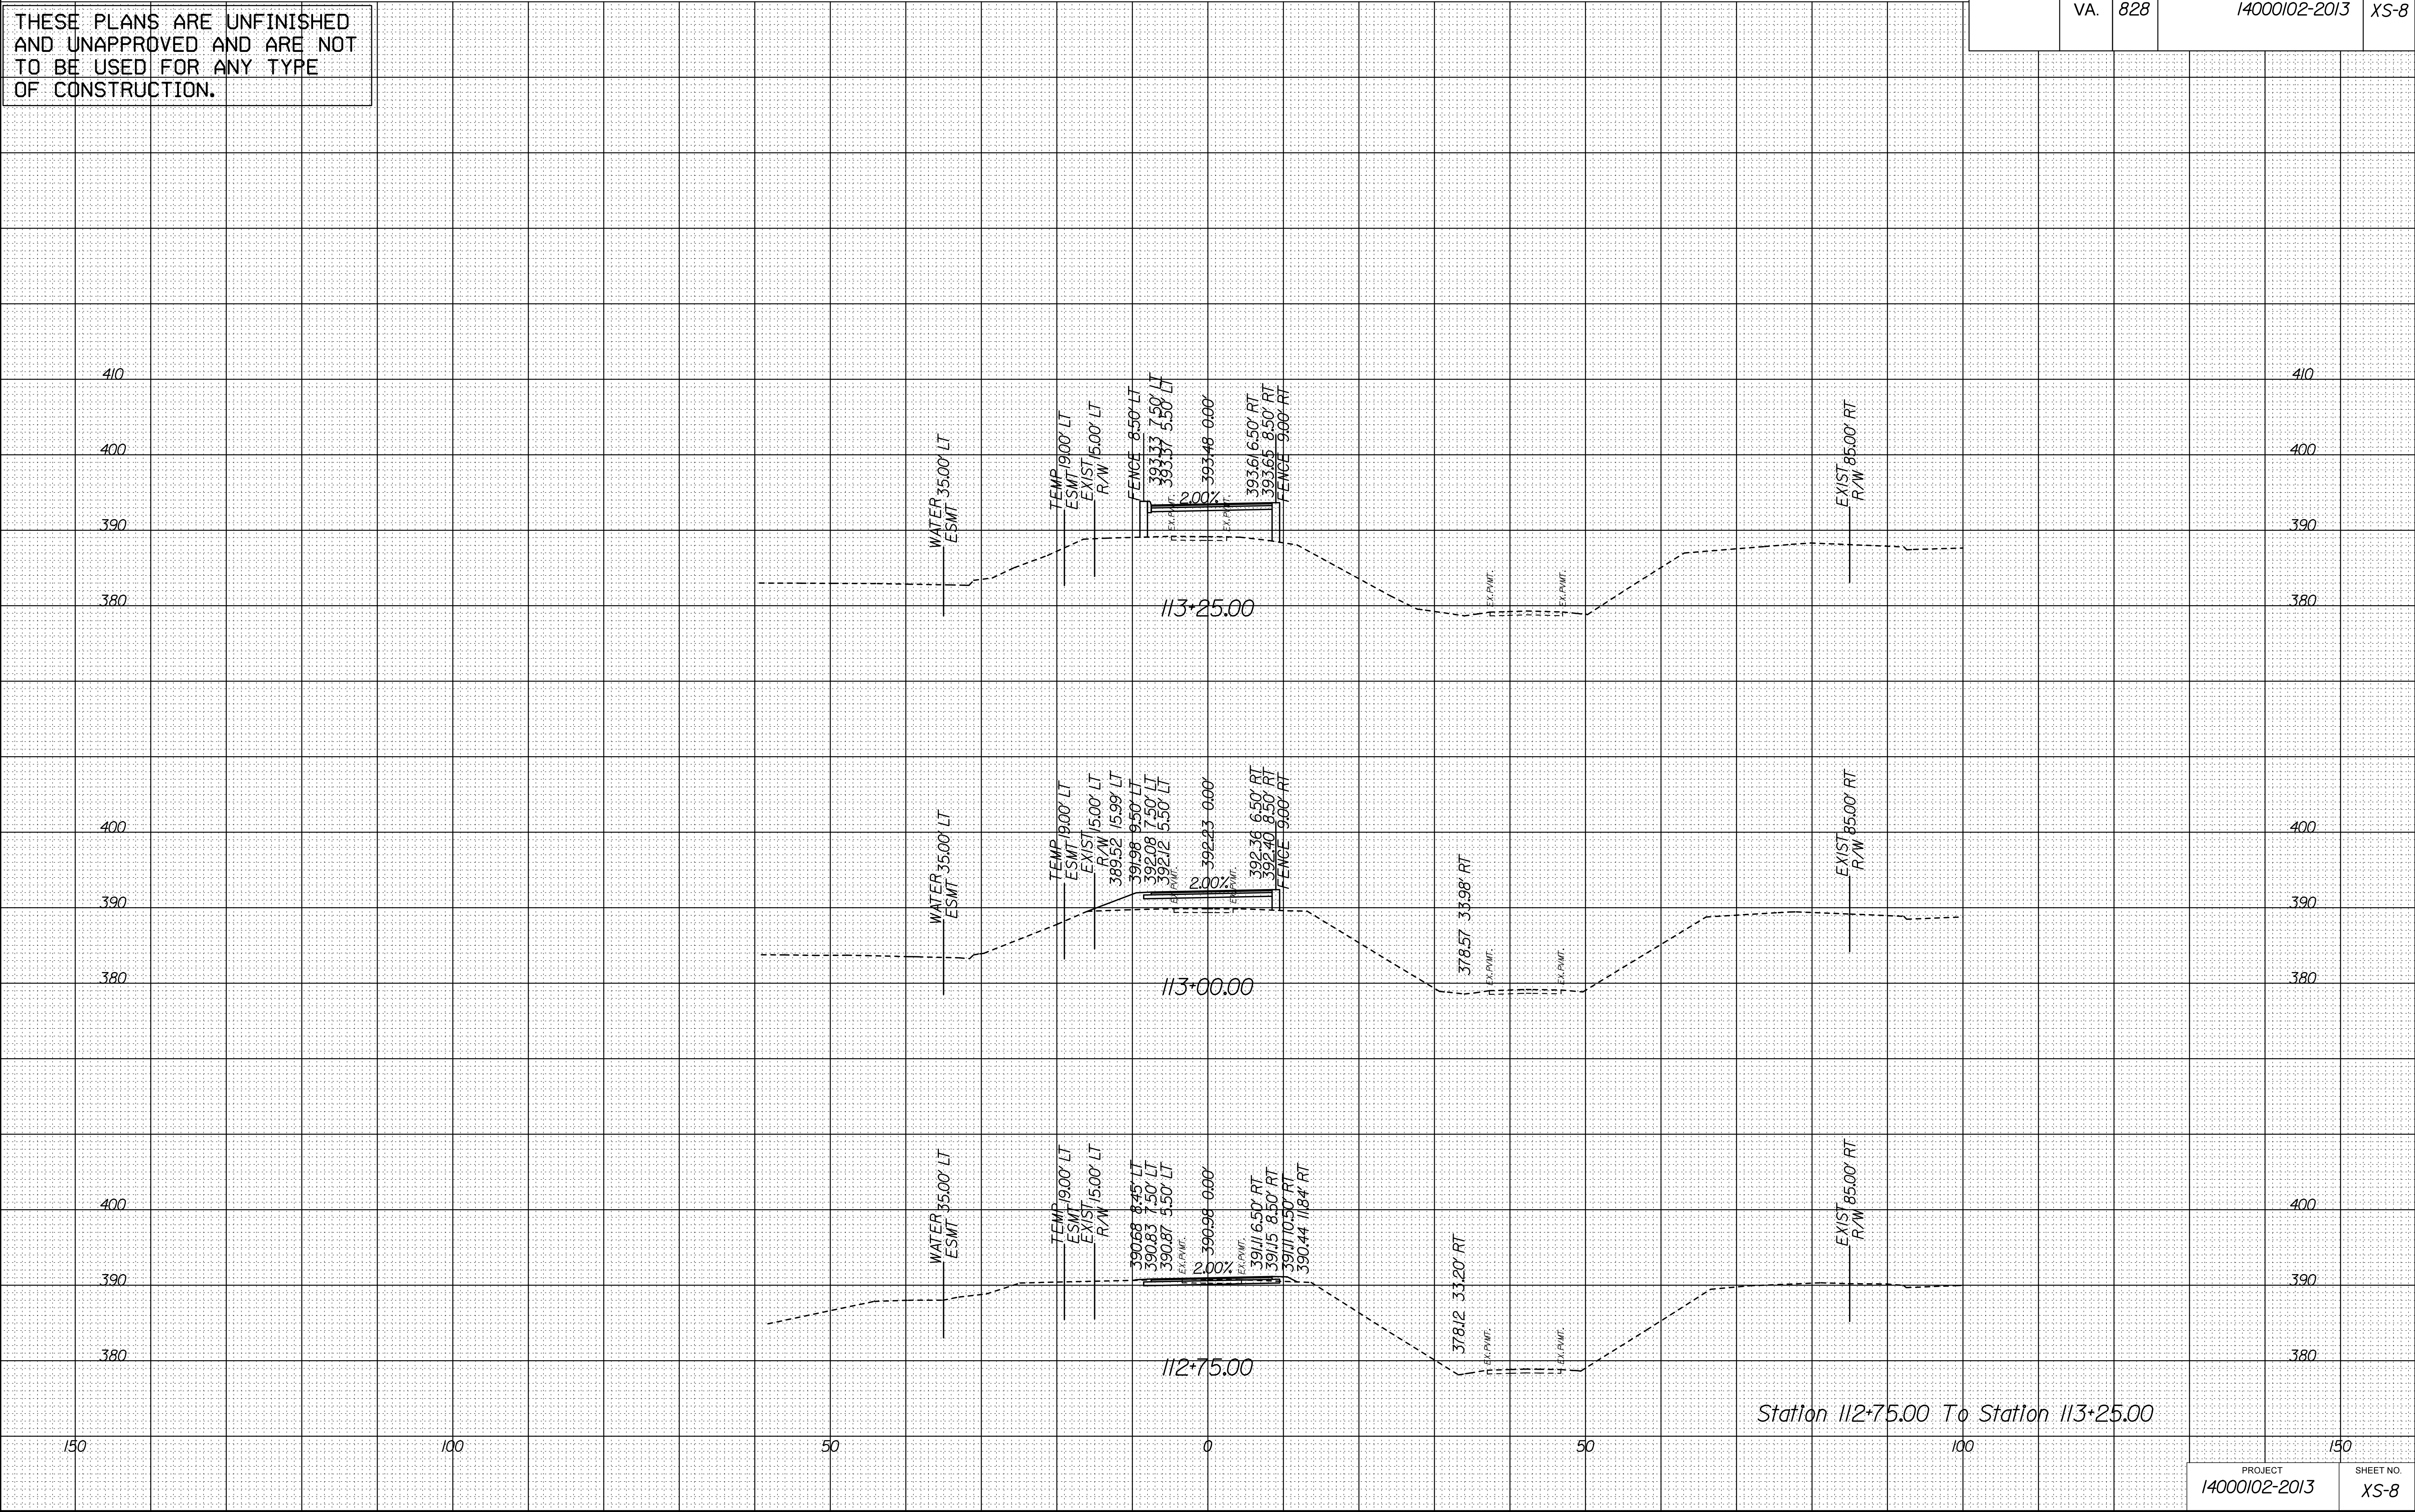
PROJECT MANAGER SCOTT RUEFNEB, P.E. 17031872-5736 ---  
SURVEYED BY, DATE FAIRFAX COUNTY, NOVEMBER 28, 2014. --  
DESIGN BY WHITMAN, REQUARDT & ASSOCIATES, LLP 17031293-9717  
SUBSURFACE UTILITY BY, DATE SQ DEEP, INC. 17031361-6005.

CROSS SECTIONS  
SCALE 1 IN. = 10 FT

DESIGN FEATURES RELATING TO CONSTRUCTION  
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REVISED	STATE	STATE		SHEET NO.
		ROUTE	PROJECT	
	VA.	828	14000102-2013	XS-8

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PROJECT MANAGER SCOTT RUFFNER, P.E. (703) 872-5736 \_ \_ \_  
SURVEYED BY, DATE FAIRFAX COUNTY, NOVEMBER 28, 2014 \_ \_  
DESIGN BY WHITMAN, REQUARDT & ASSOCIATES, LLP (703) 293-9717  
SUBSURFACE UTILITY BY, DATE SQ DEEP, INC. (703) 361-6005 \_ \_


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SCALE 1 IN. = 10 FT

DESIGN FEATURES RELATING TO CONSTRUCTION  
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N C	REVISED	STATE	STATE		SHEET NO.
		ROUTE	PROJECT		
		VA.	14000102-2013		
		828			XS-9
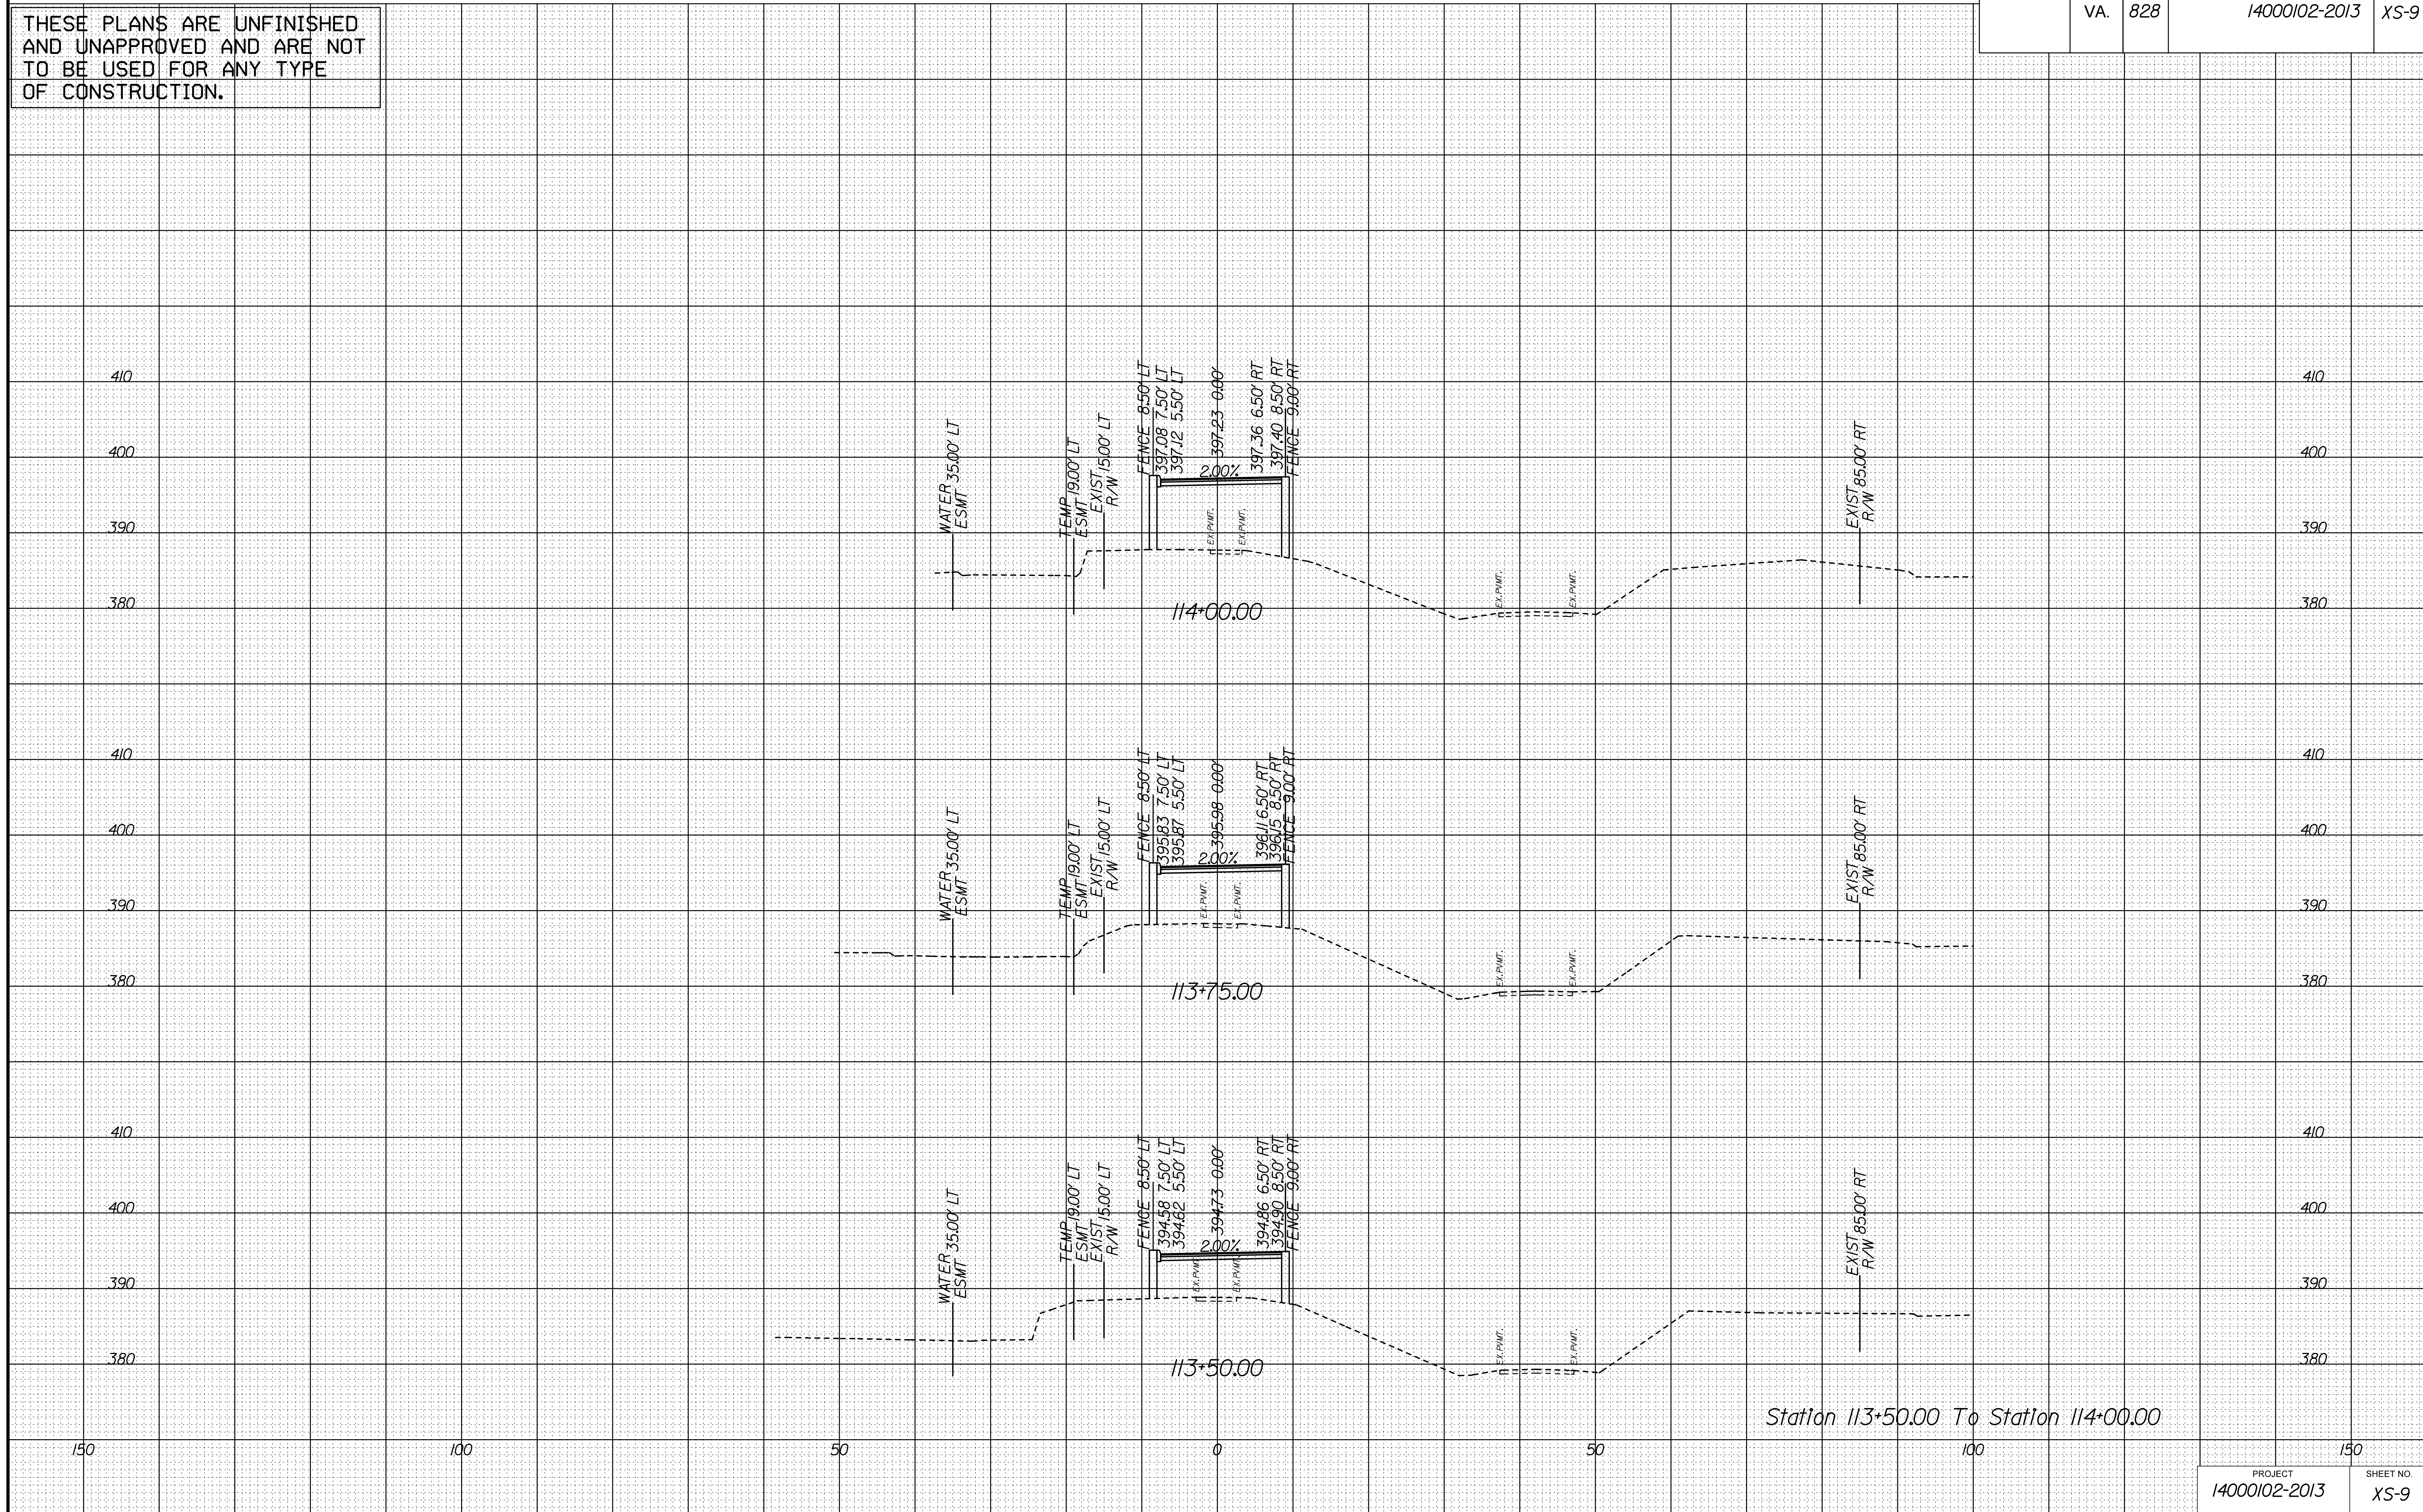
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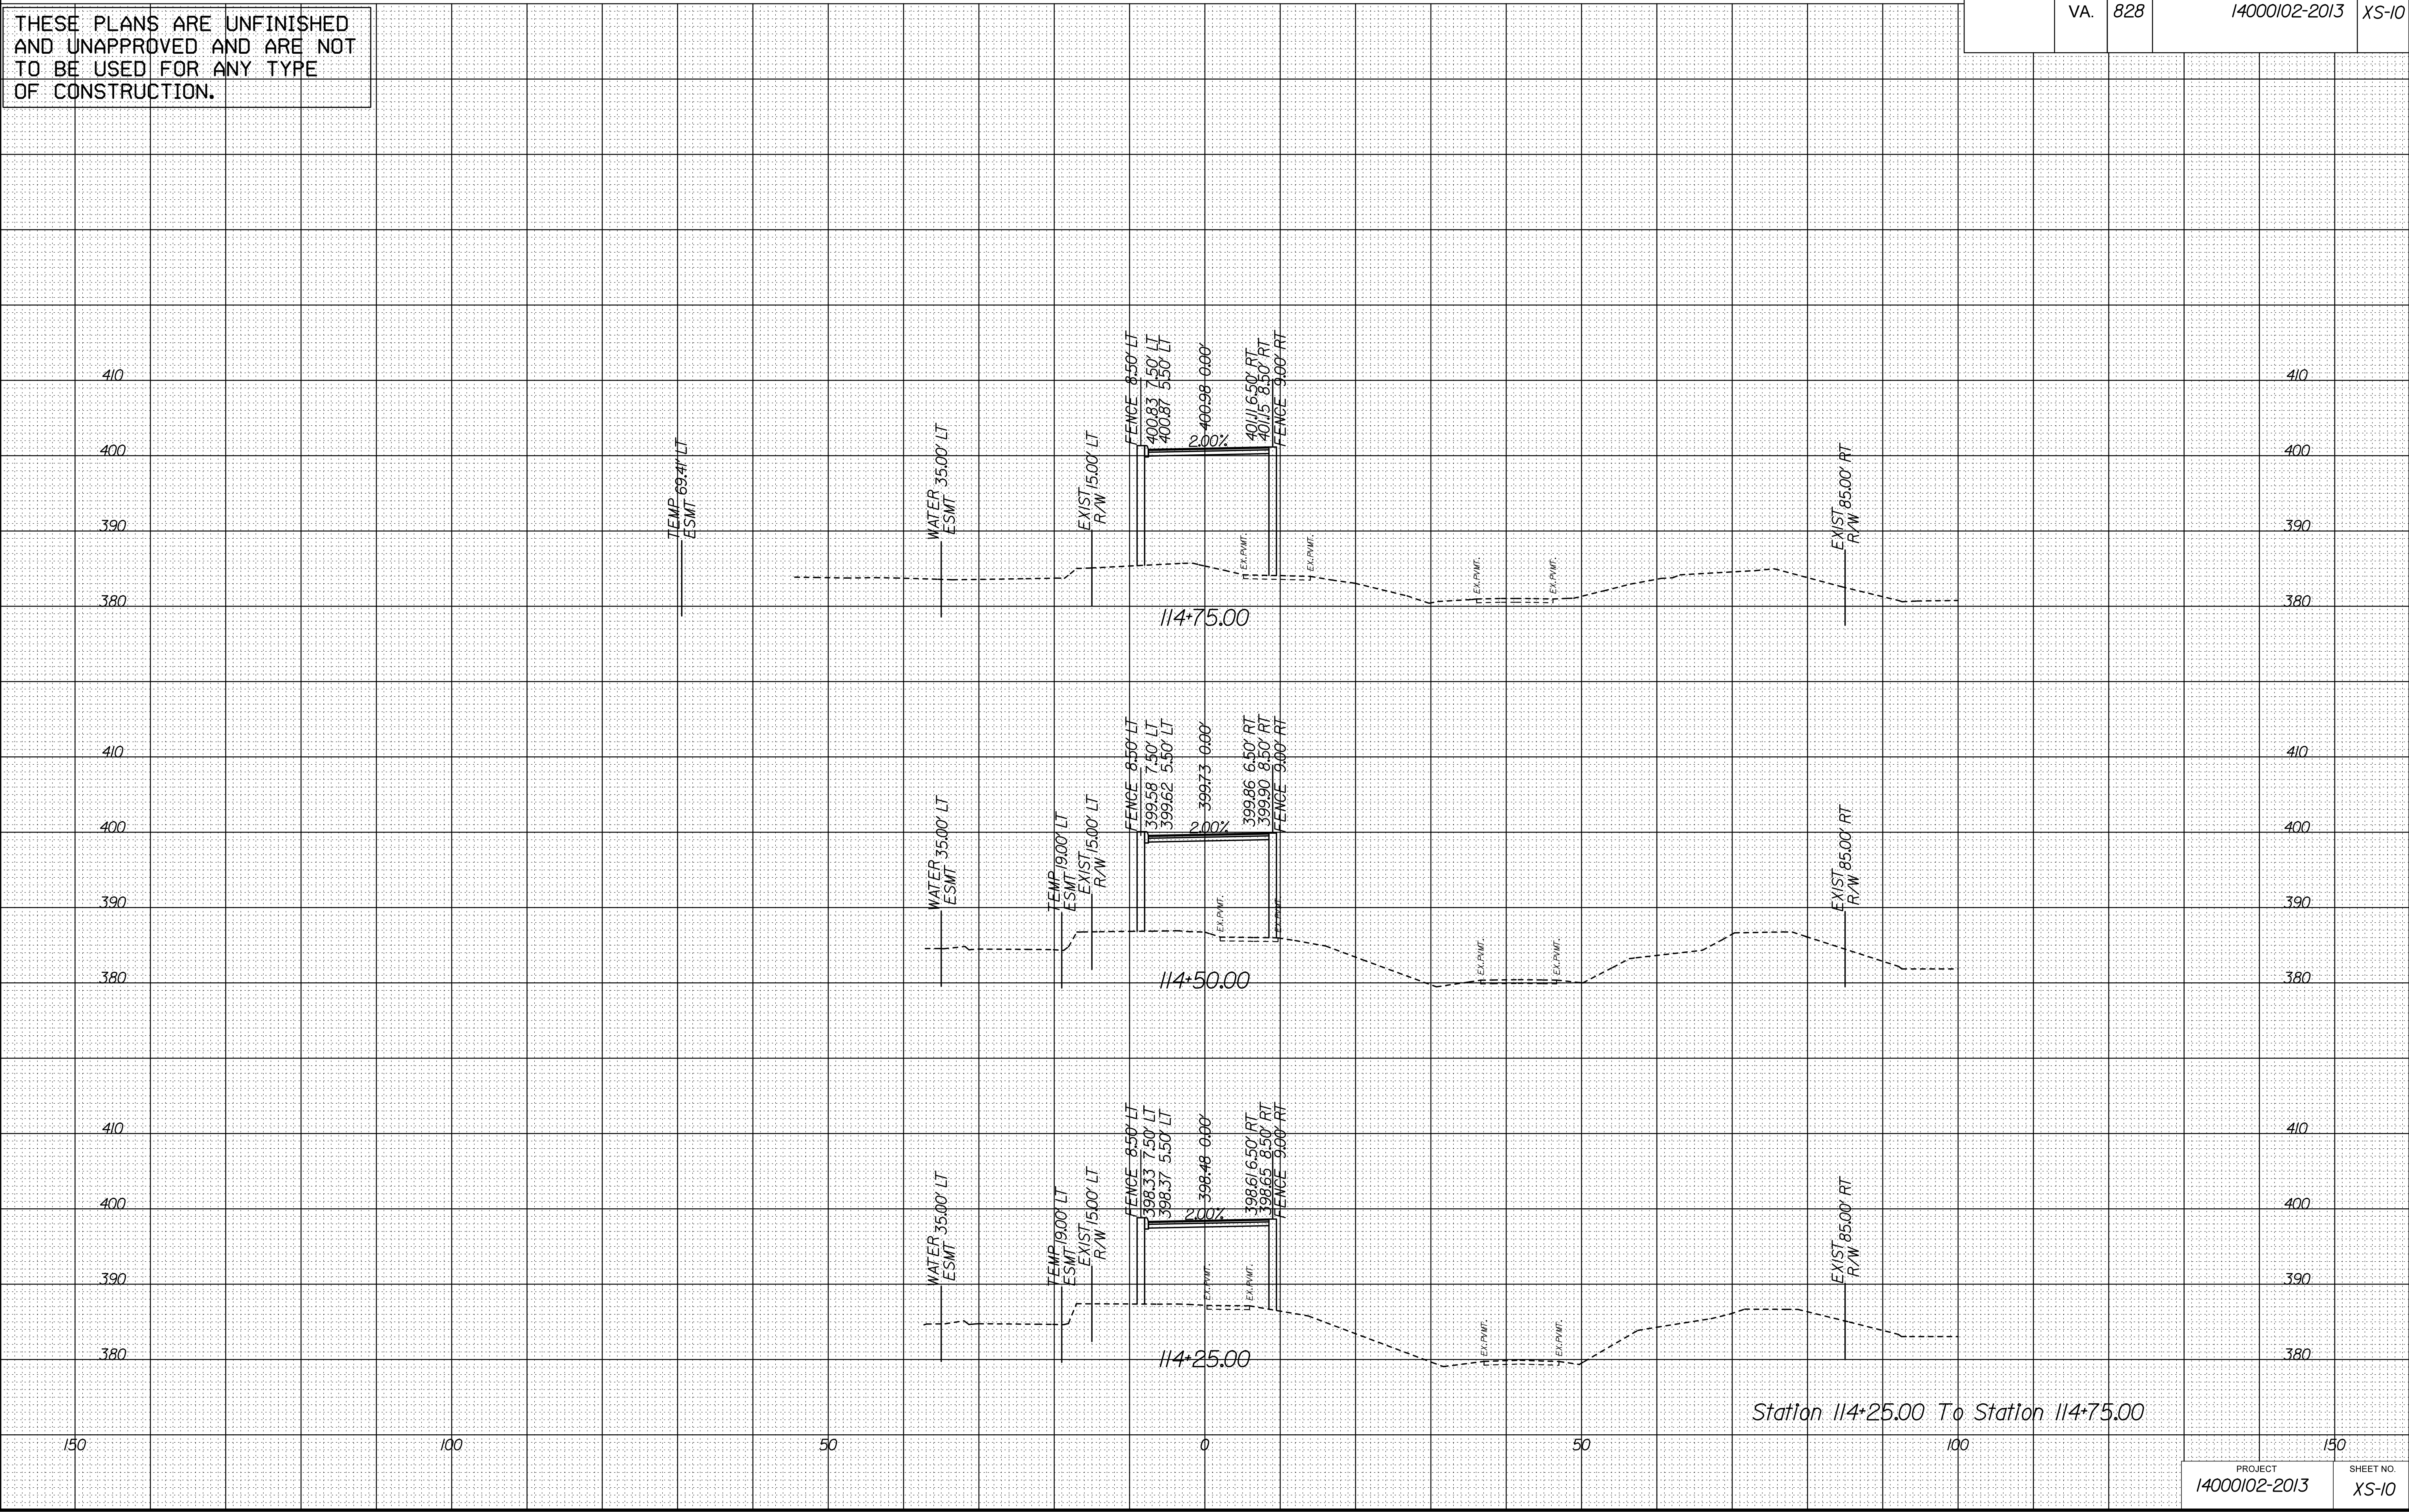
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SURVEYED BY, DATE FAIRFAX COUNTY, NOVEMBER 28, 2014. ---  
DESIGN BY WHITMAN, REQUARDT & ASSOCIATES, LLP 17031293-9717  
SUBSURFACE UTILITY BY, DATE SO DEEP, INC. 17031361-6005.

CROSS SECTIONS  
SCALE 1 IN. = 10 FT

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REVISED	STATE	STATE		SHEET NO.
		ROUTE	PROJECT	
	VA.	828	14000102-2013	XS-10

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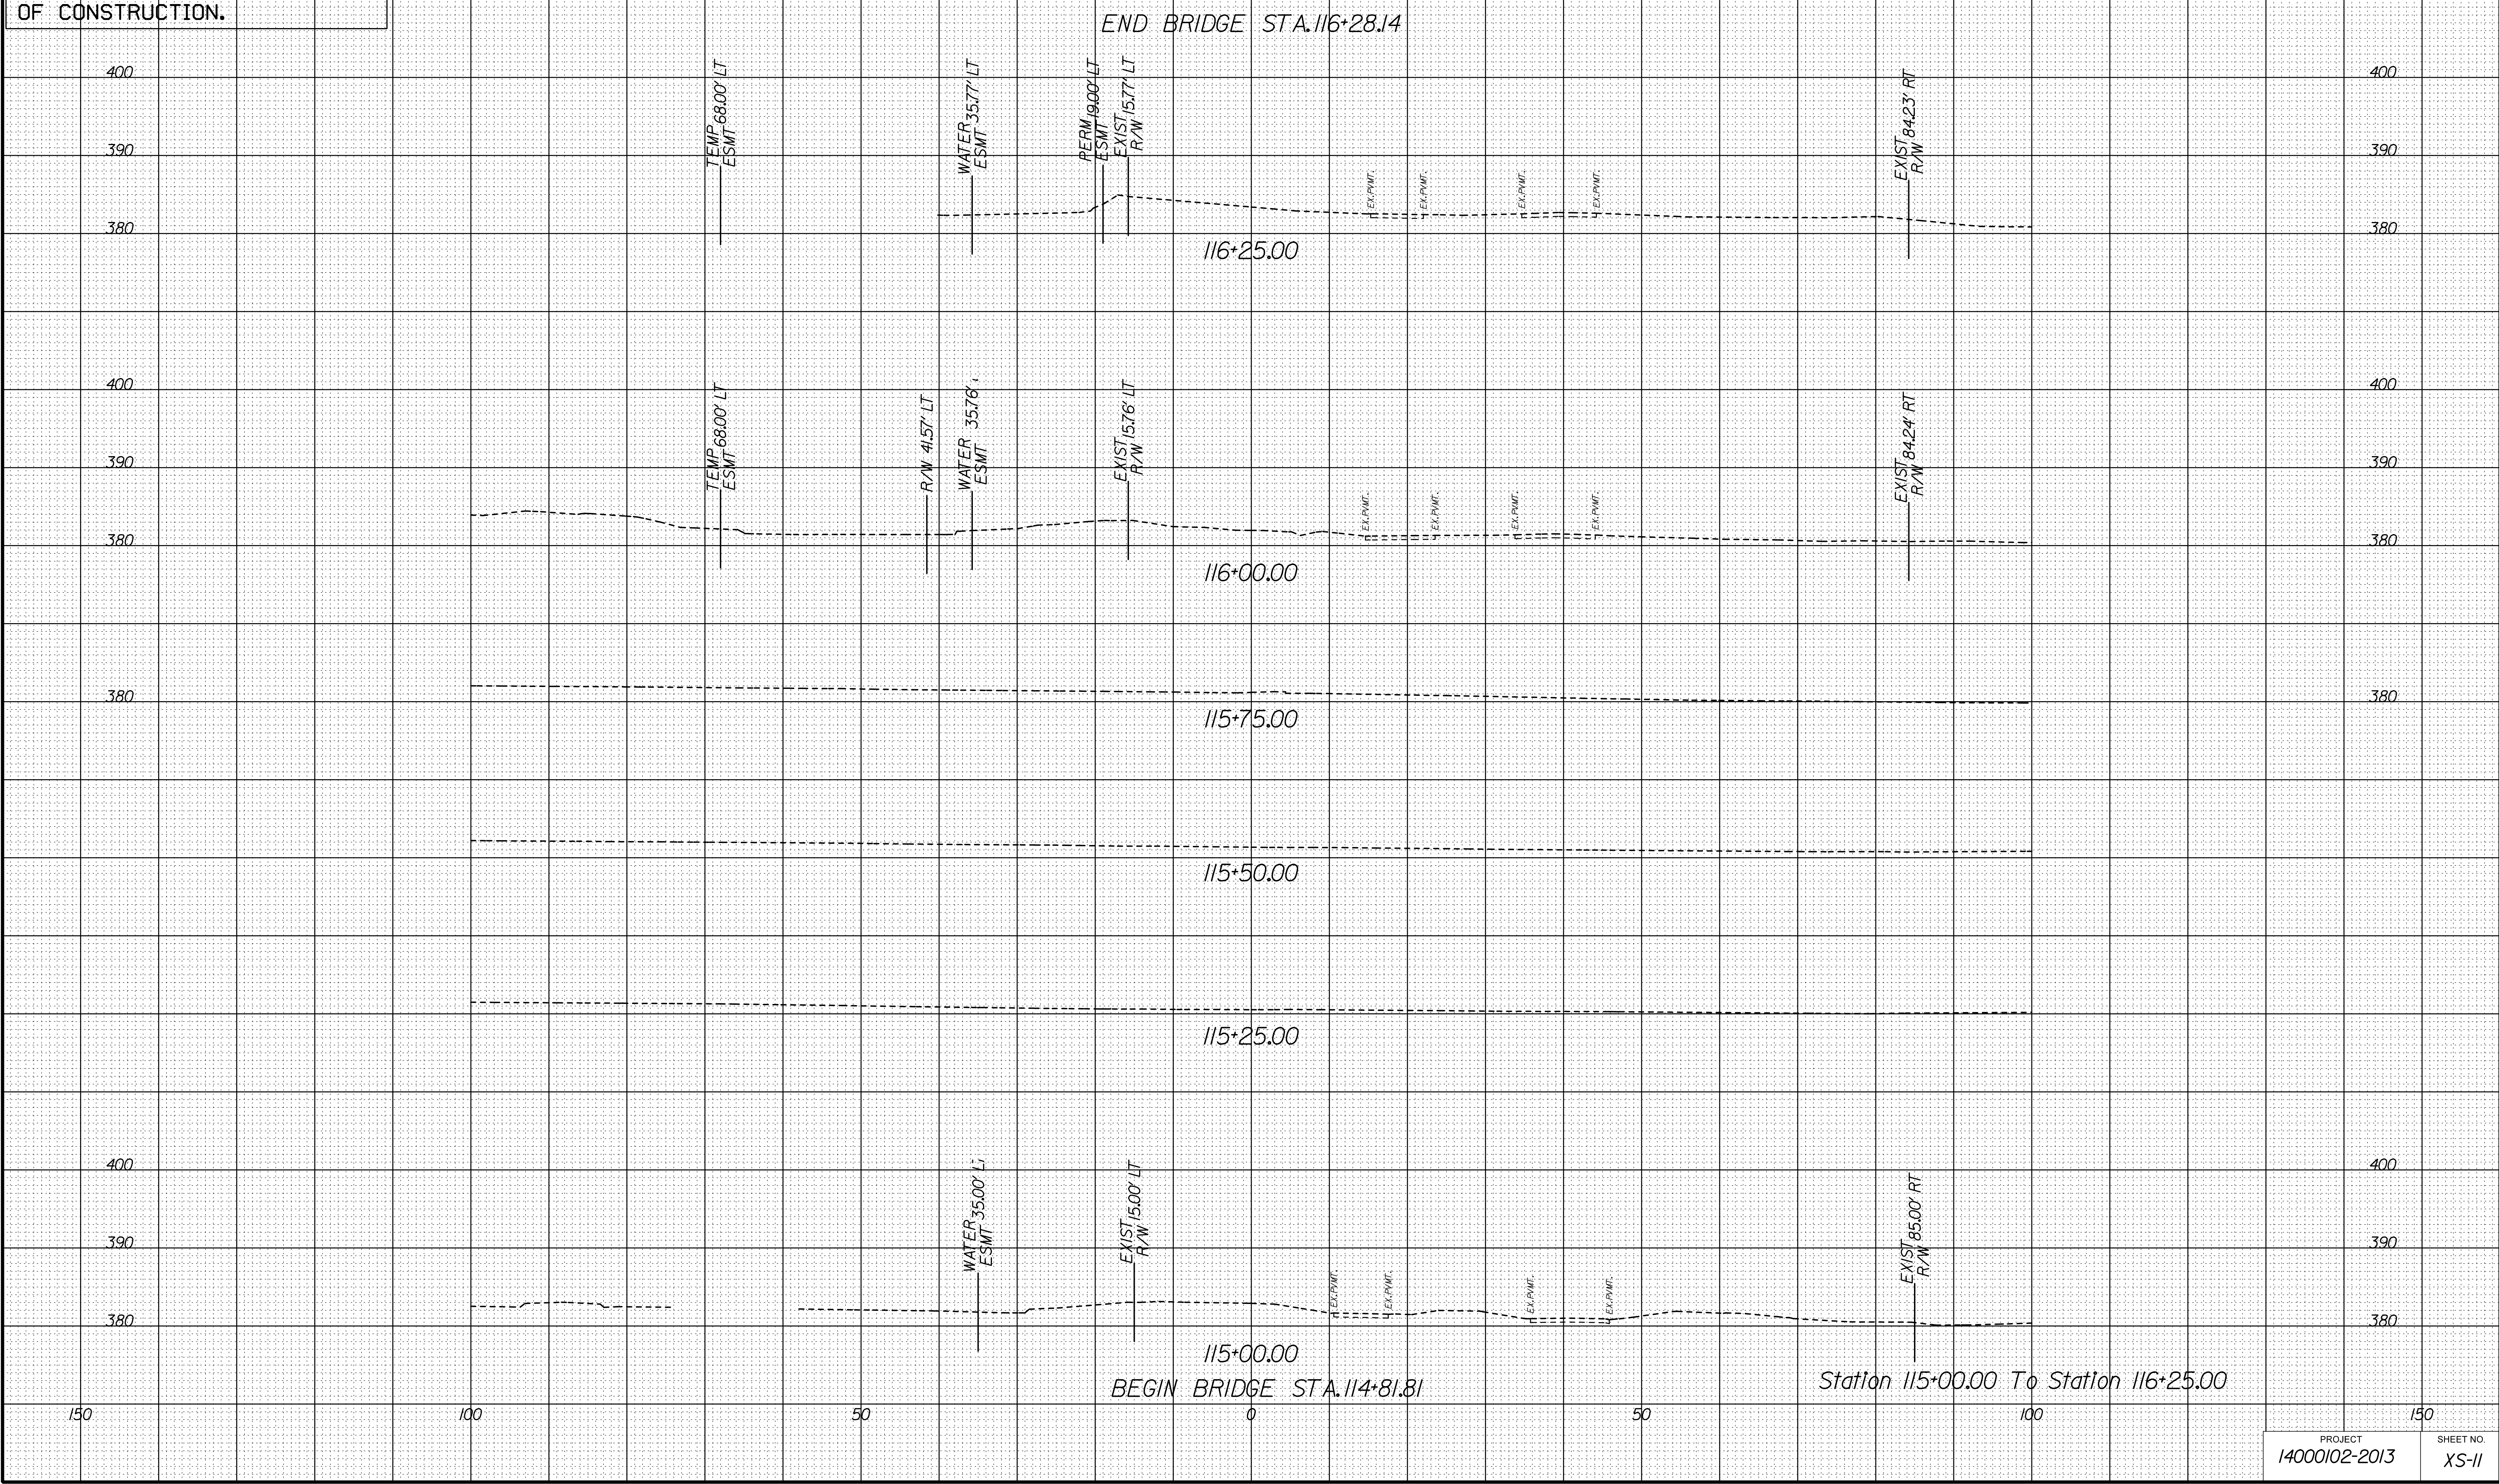
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SURVEYED BY, DATE FAIRFAX COUNTY, NOVEMBER 28, 2014. ---  
DESIGN BY WHITMAN, REQUARDT & ASSOCIATES, LLP 17031293-9717  
SUBSURFACE UTILITY BY, DATE SQ DEEP, INC. 17031361-6005.

CROSS SECTIONS  
SCALE 1 IN. = 10 FT

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REVISED	STATE	STATE		SHEET NO.
		ROUTE	PROJECT	
	VA.	828	14000102-2013	XS-II

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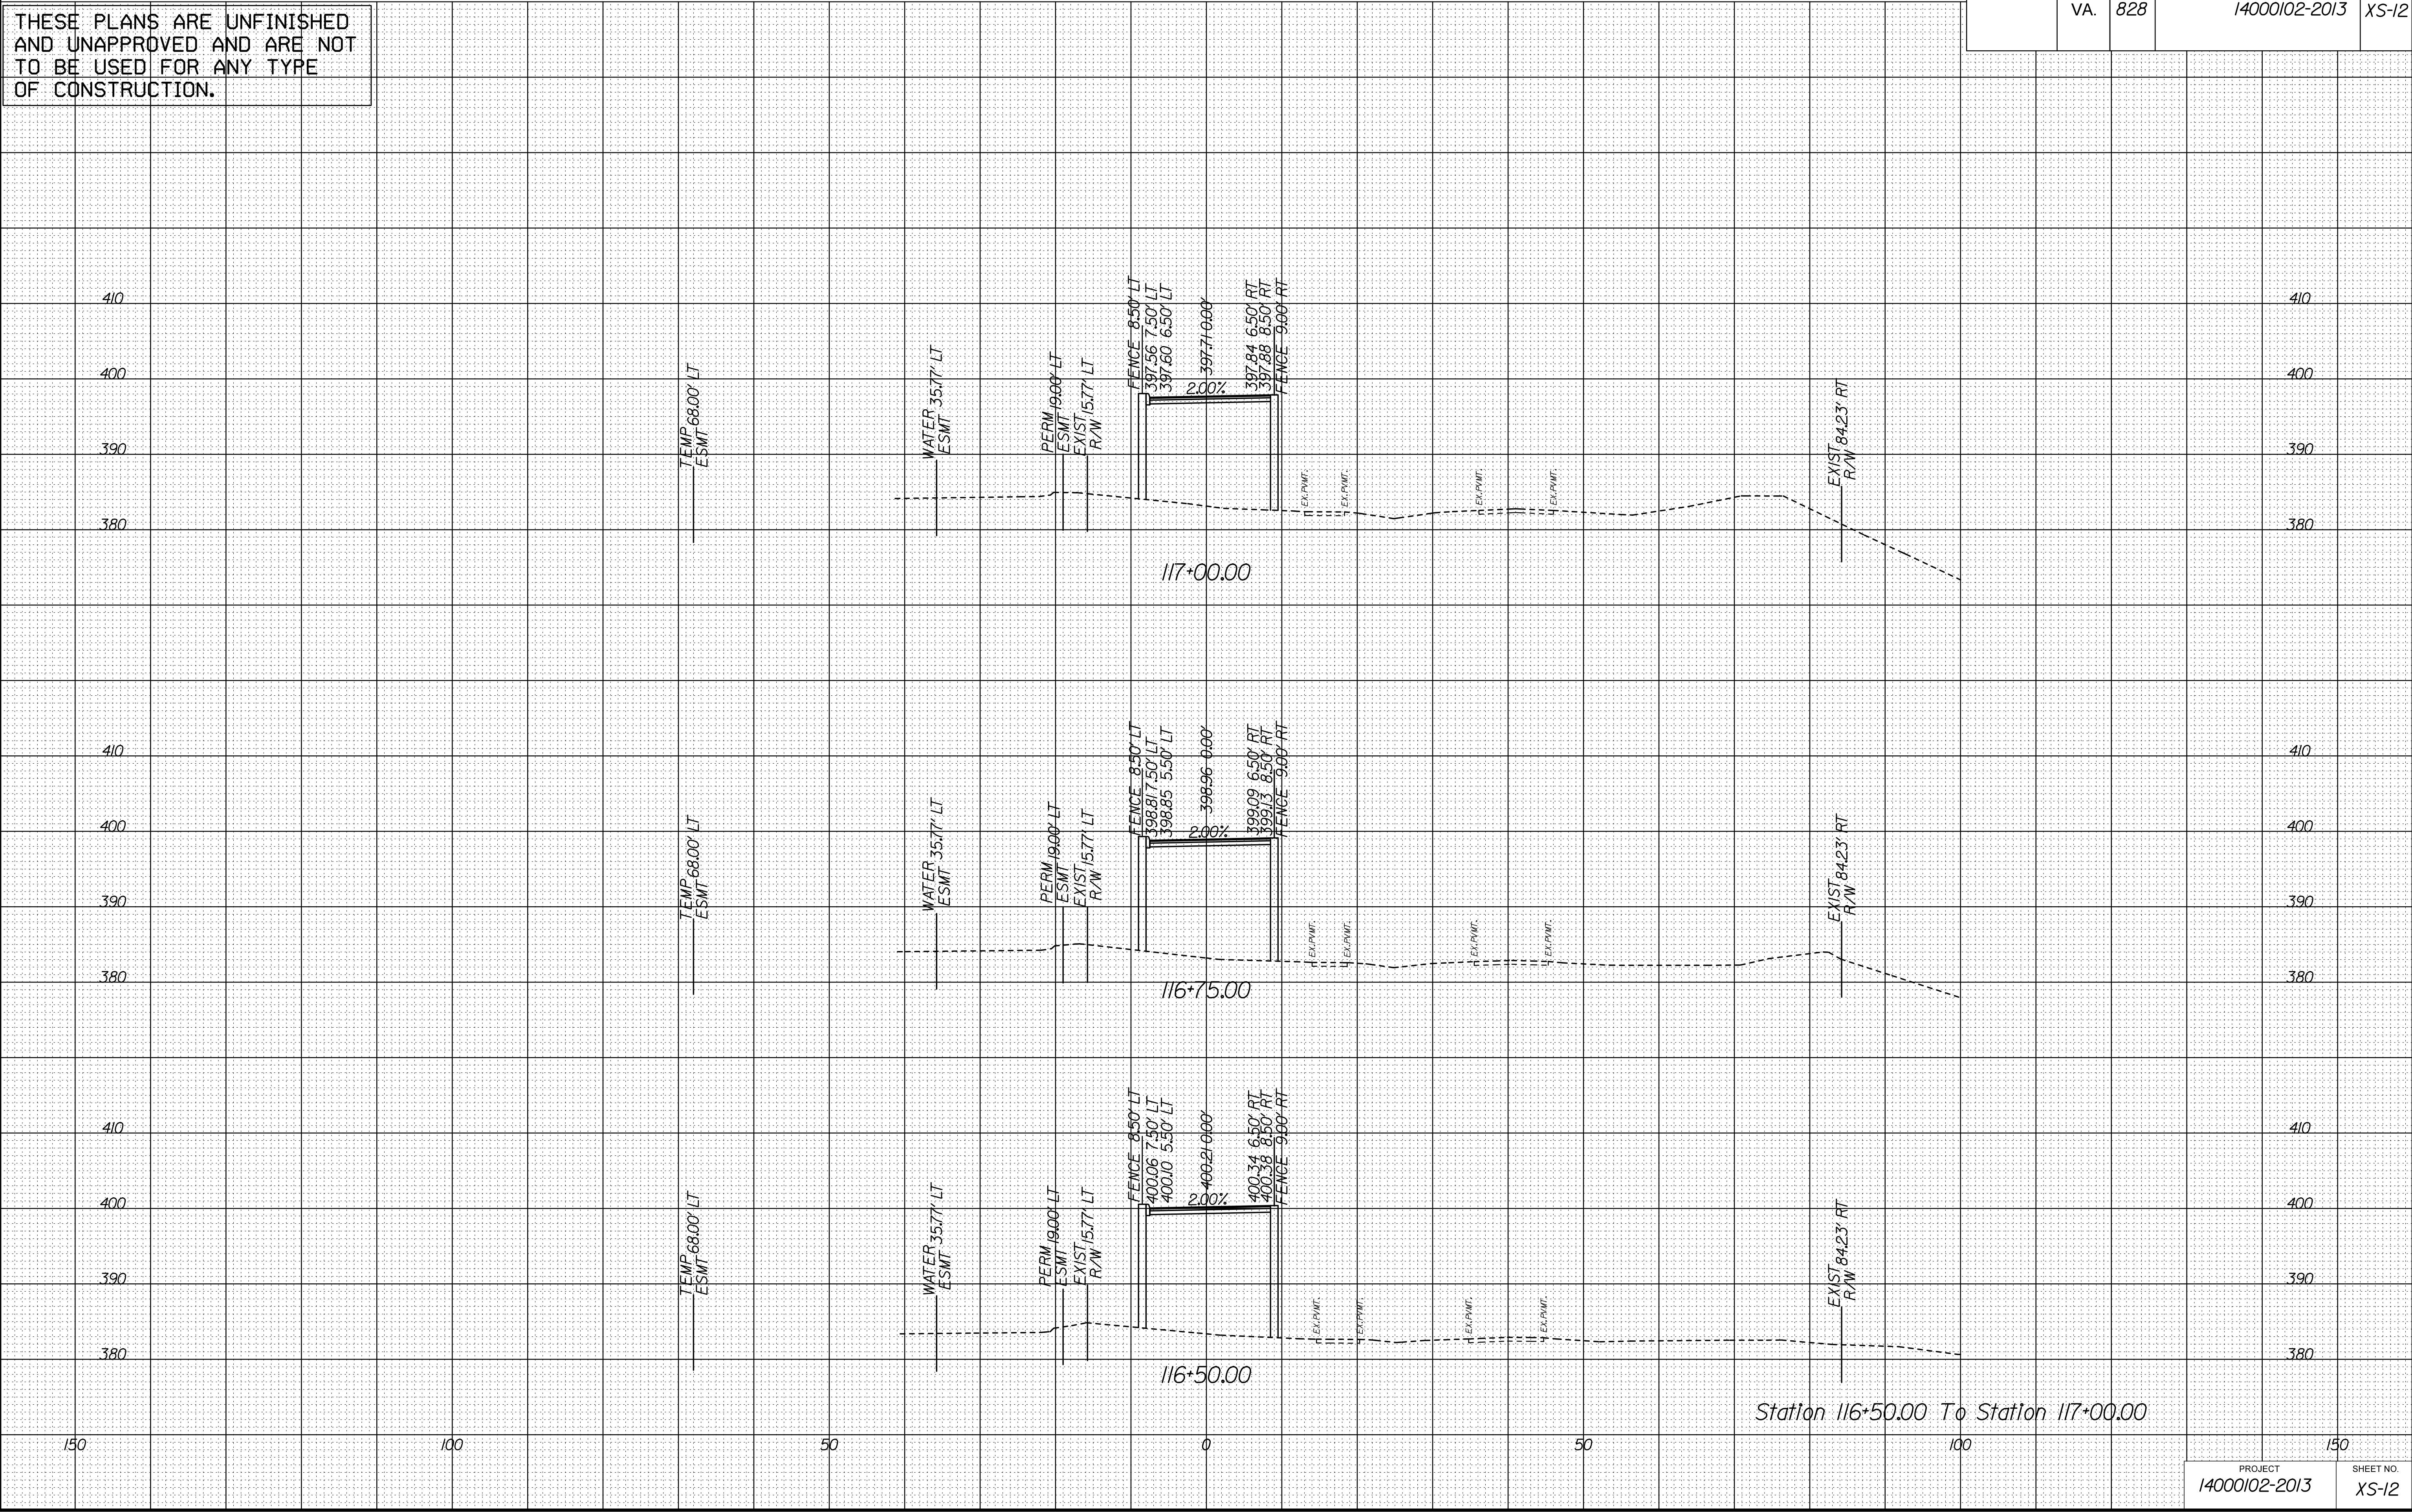
PROJECT MANAGER SCOTT RUEFNEB, P.E. 17031872-5736 ---  
SURVEYED BY, DATE FAIRFAX COUNTY, NOVEMBER 28, 2014. --  
DESIGN BY WHITMAN, REQUARDT & ASSOCIATES, LLP 17031293-9717  
SUBSURFACE UTILITY BY, DATE SQ DEEP, INC. 17031361-6005.

CROSS SECTIONS  
SCALE 1 IN. = 10 FT

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REVISED	STATE	STATE		SHEET NO.
		ROUTE	PROJECT	
	VA.	828	14000102-2013	XS-12

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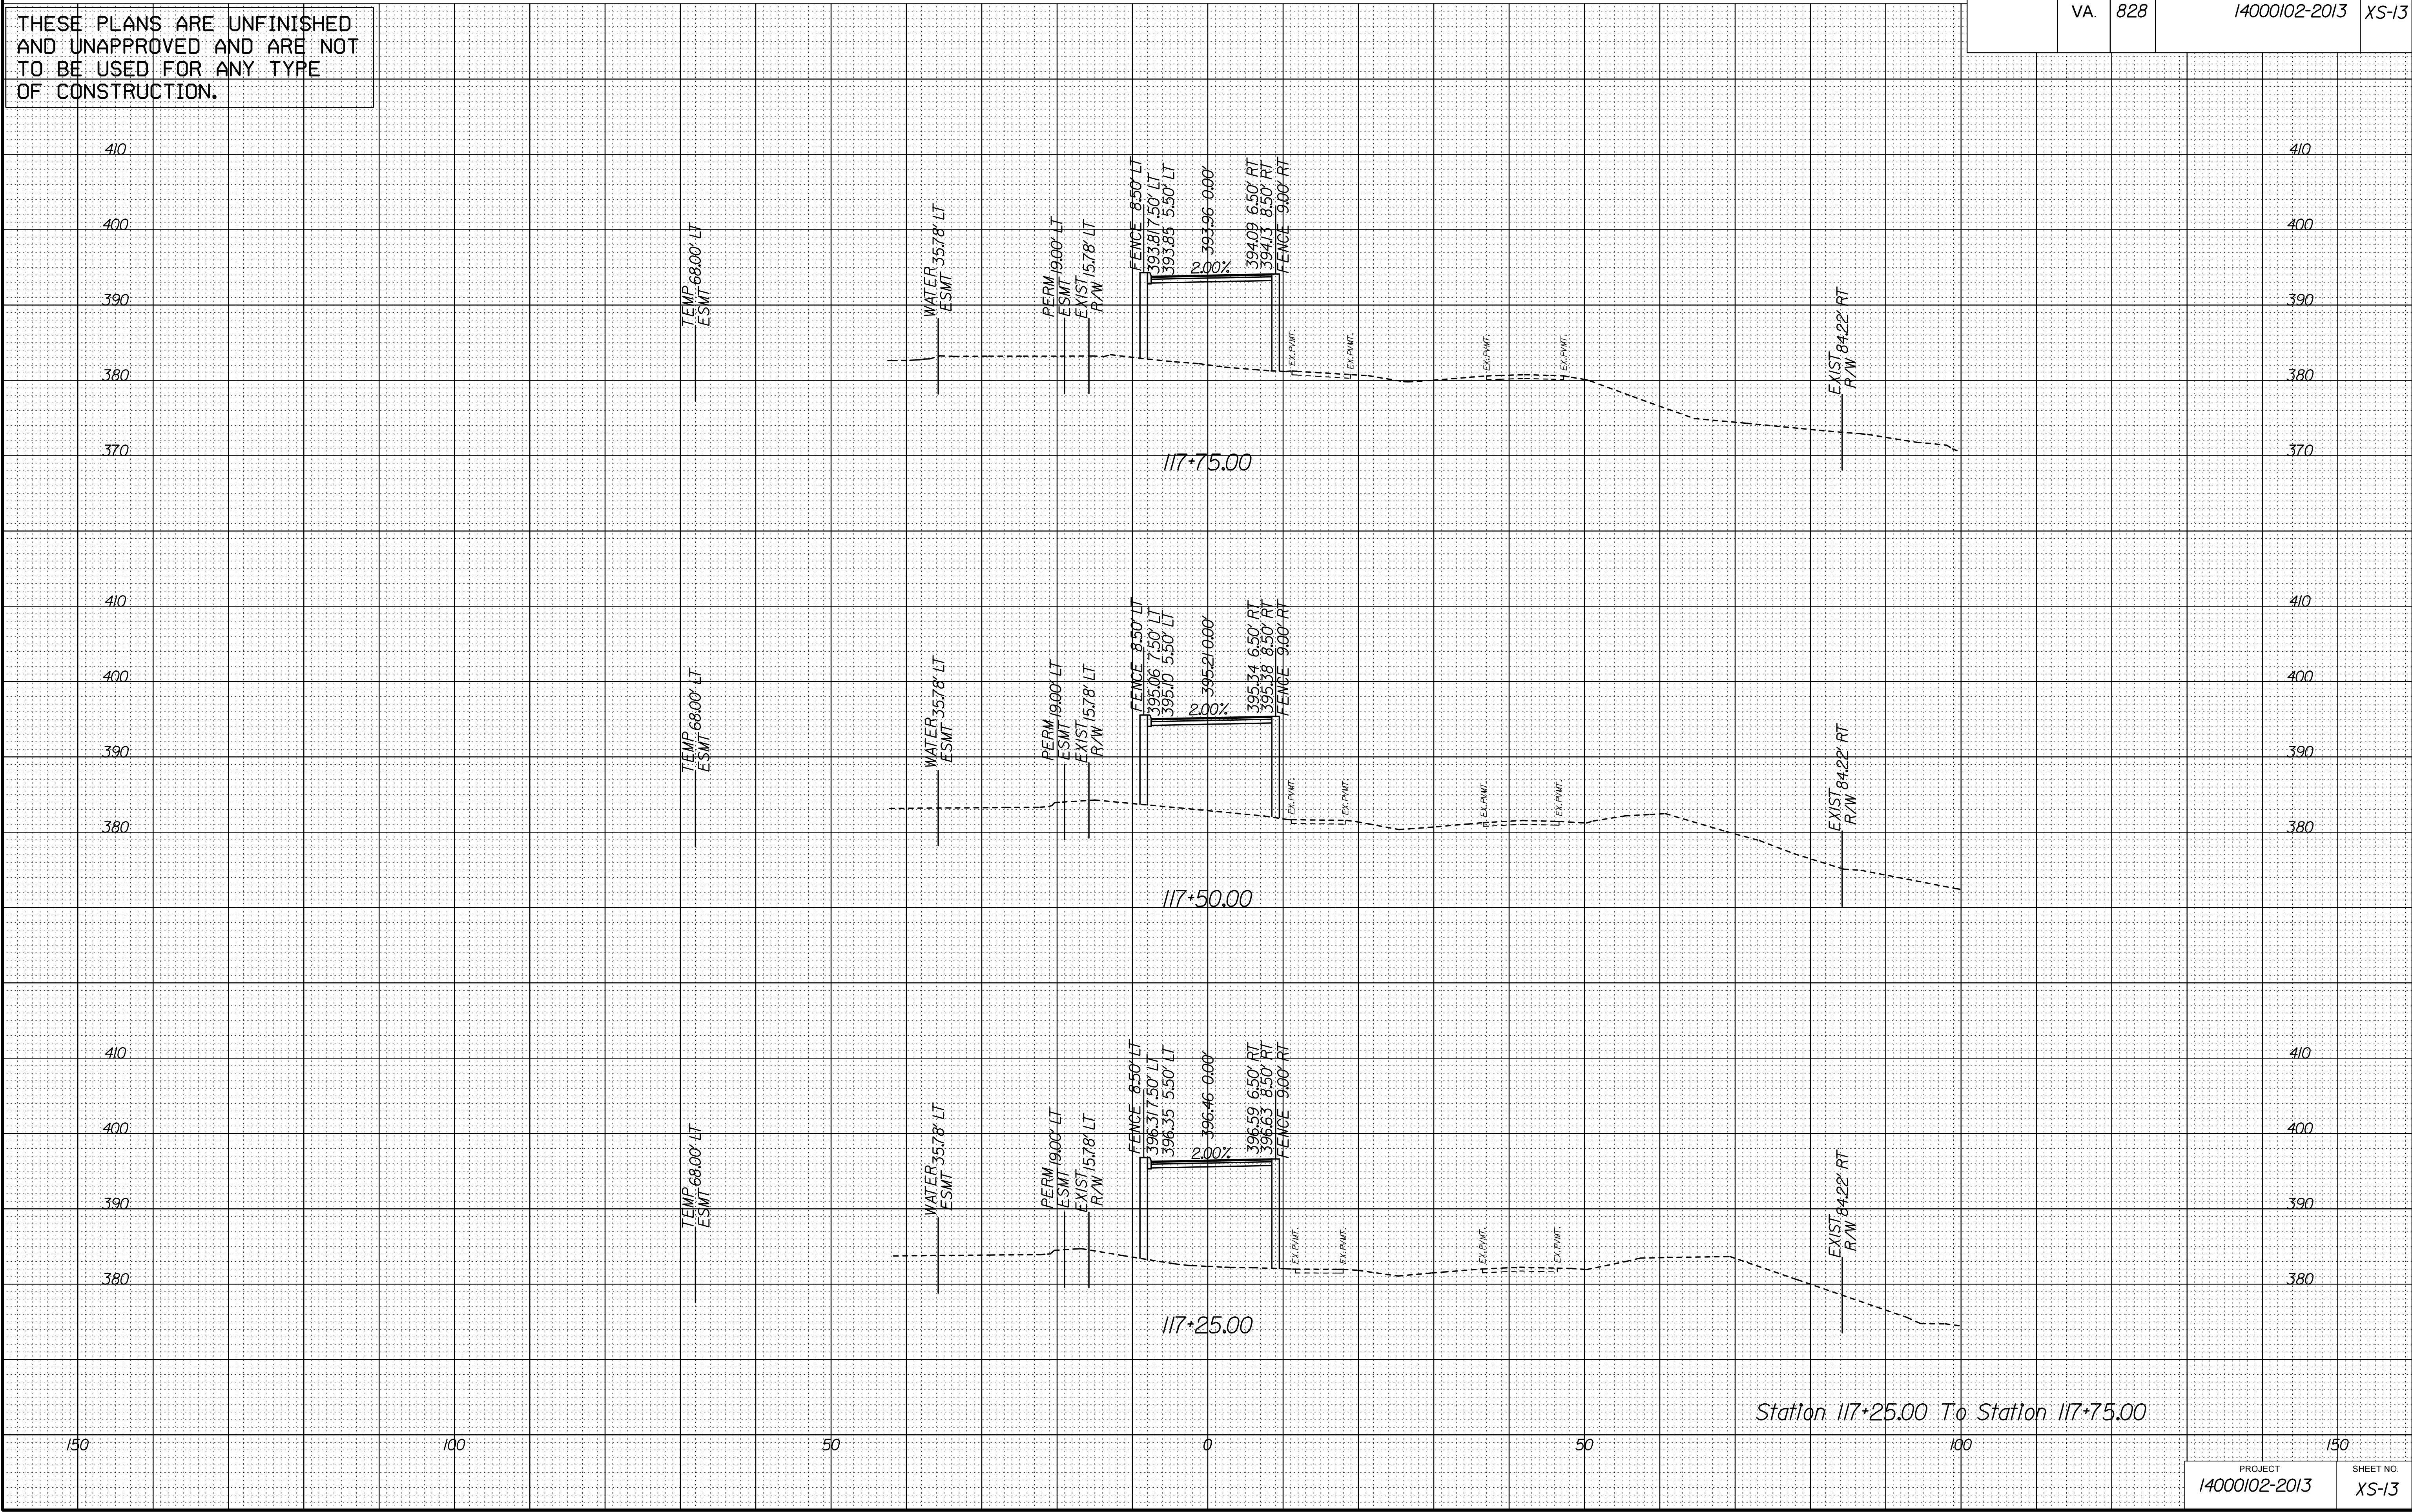
PROJECT MANAGER SCOTT RUEFNEB, P.E. 17031872-5736 ---  
SURVEYED BY, DATE EMB/FAX COUNTY, NOVEMBER 28, 2014. --  
DESIGN BY WHITMAN, REQUARDT, & ASSOCIATES, LLP 17031293-9717  
SUBSURFACE UTILITY BY, DATE SQ DEEP, INC. 17031361-6005.

CROSS SECTIONS  
SCALE 1 IN. = 10 FT

DESIGN FEATURES RELATING TO CONSTRUCTION  
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REVISED	STATE	STATE		SHEET NO.
		ROUTE	PROJECT	
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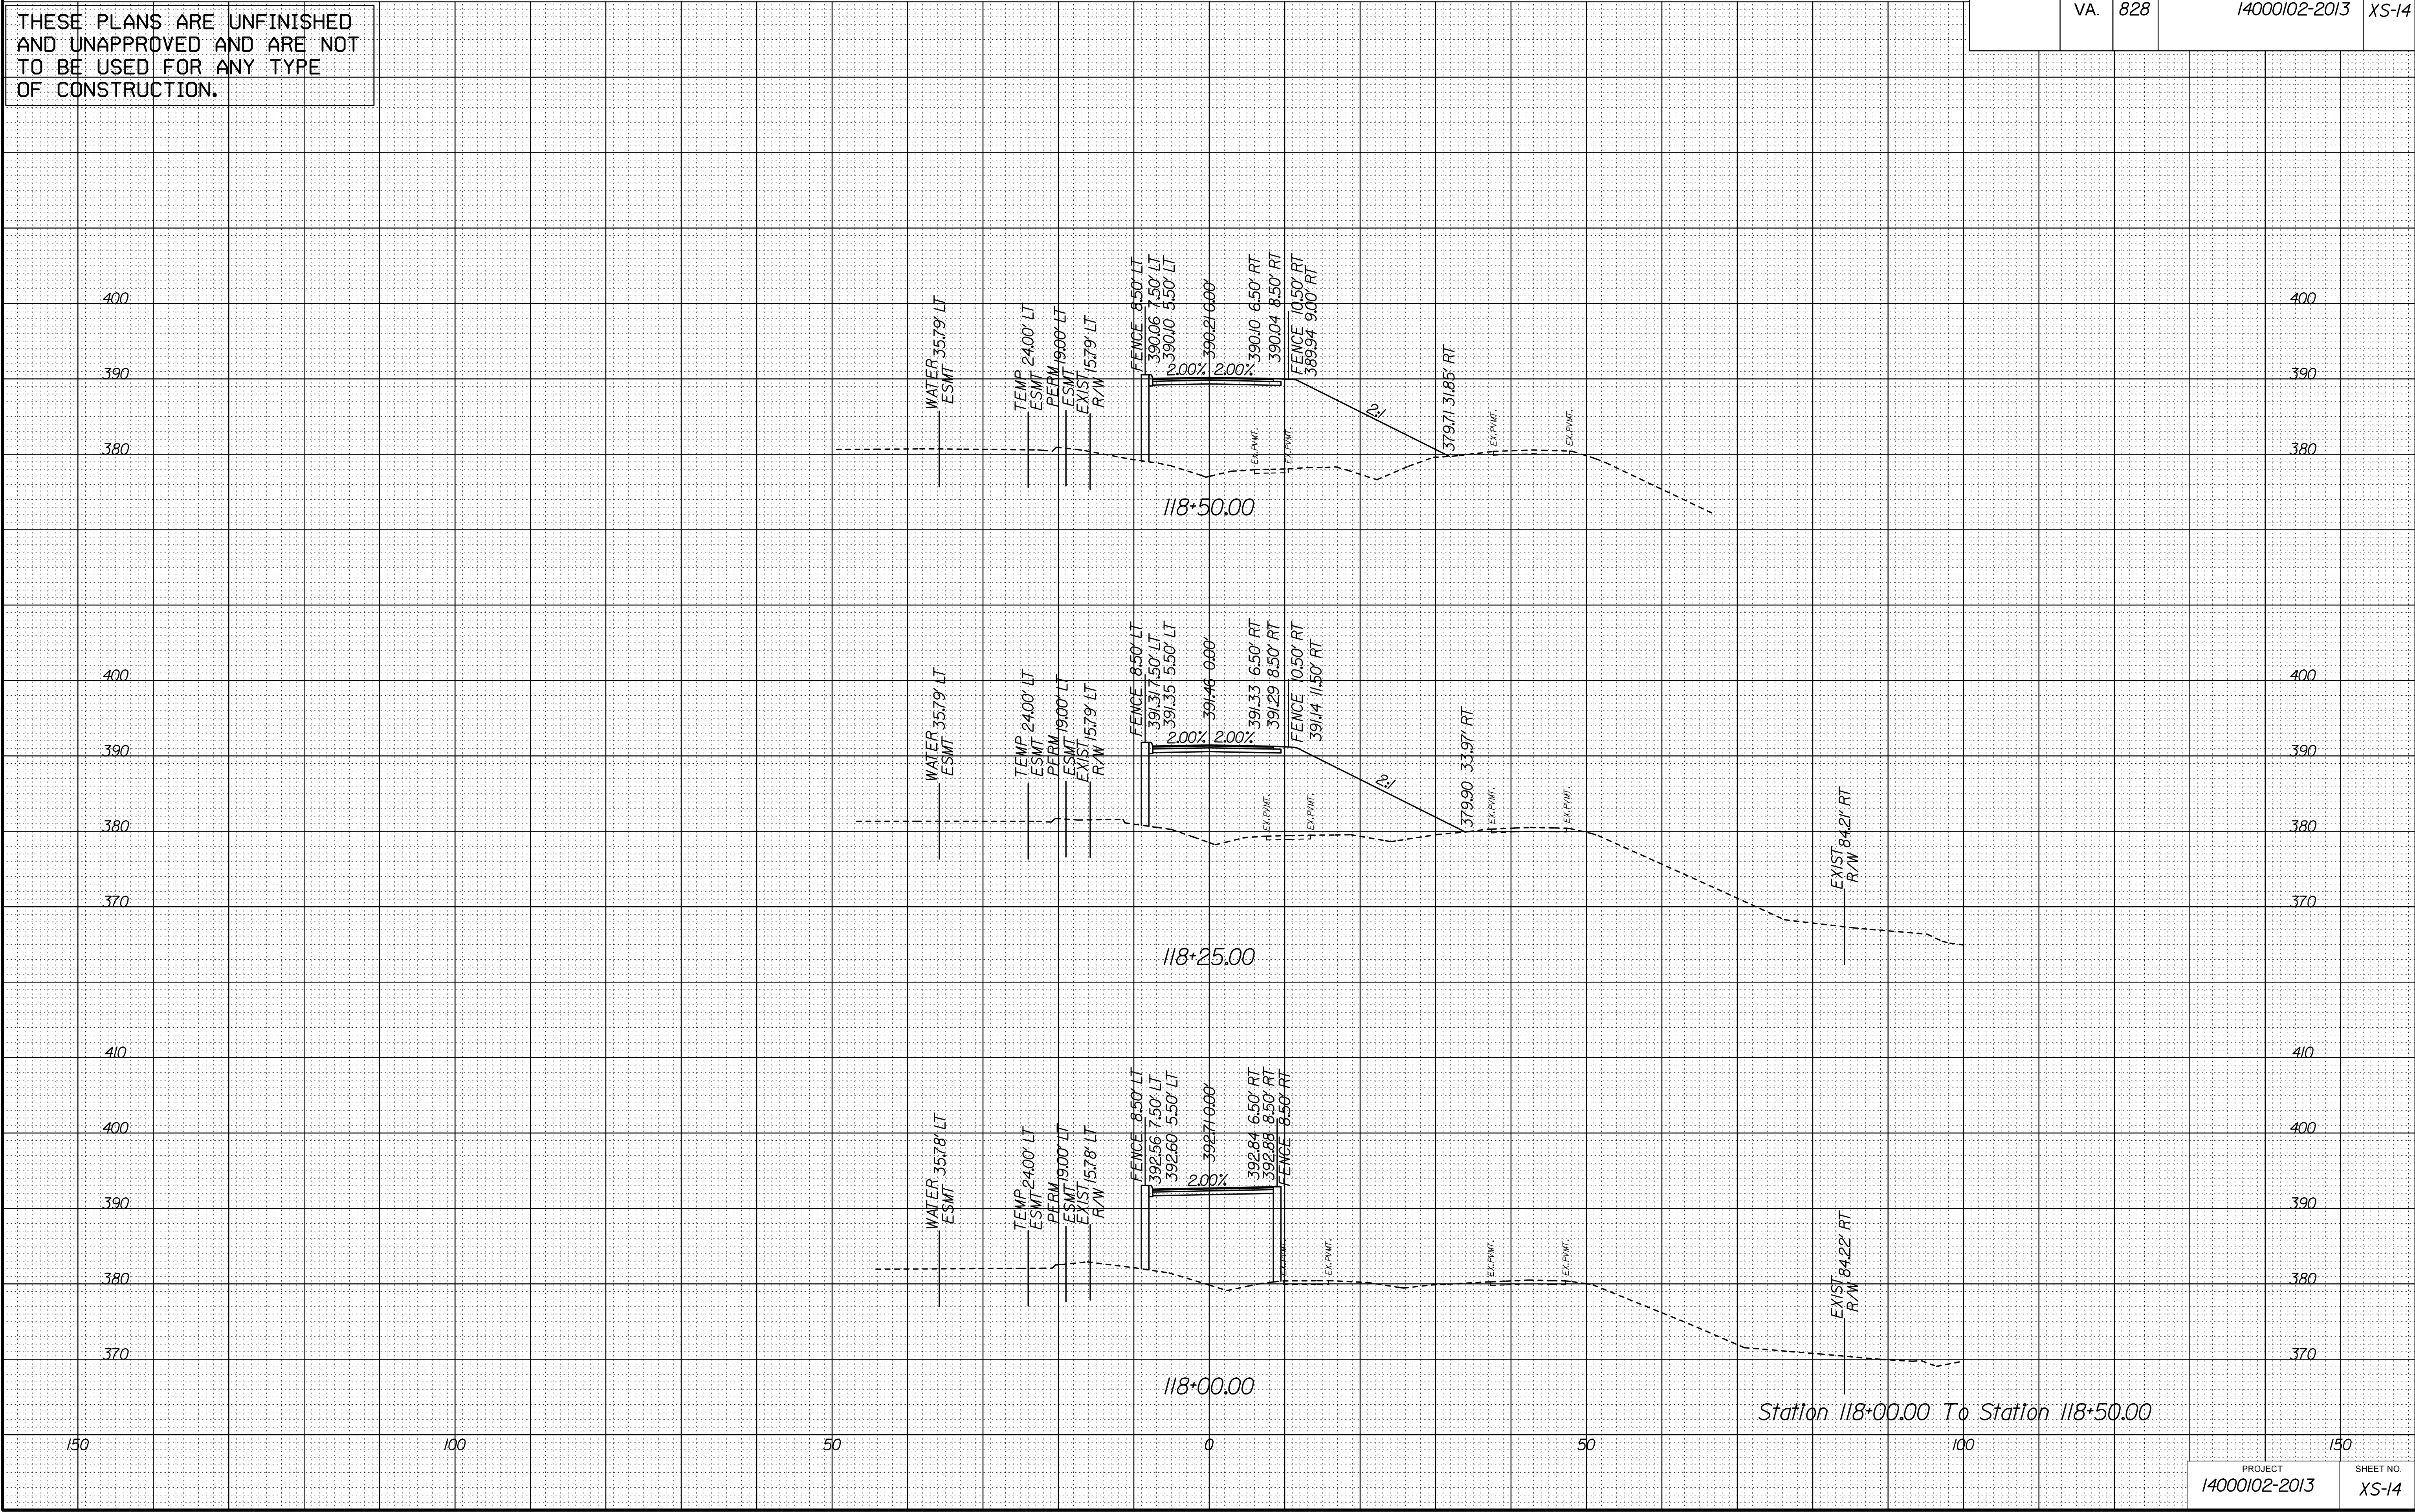
PROJECT MANAGER SCOTT RUEFNEB, P.E. 17031872-5736 ---  
SURVEYED BY, DATE FAIRFAX COUNTY, NOVEMBER 28, 2014. ---  
DESIGN BY WHITMAN, REQUARDT, & ASSOCIATES, LLP 17031293-9717  
SUBSURFACE UTILITY BY, DATE SQ DEEP, INC. 17031361-6005.

CROSS SECTIONS  
SCALE 1 IN. = 10 FT

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REVISED	STATE	STATE		SHEET NO.
		ROUTE	PROJECT	
	VA.	828	14000102-2013	XS-14

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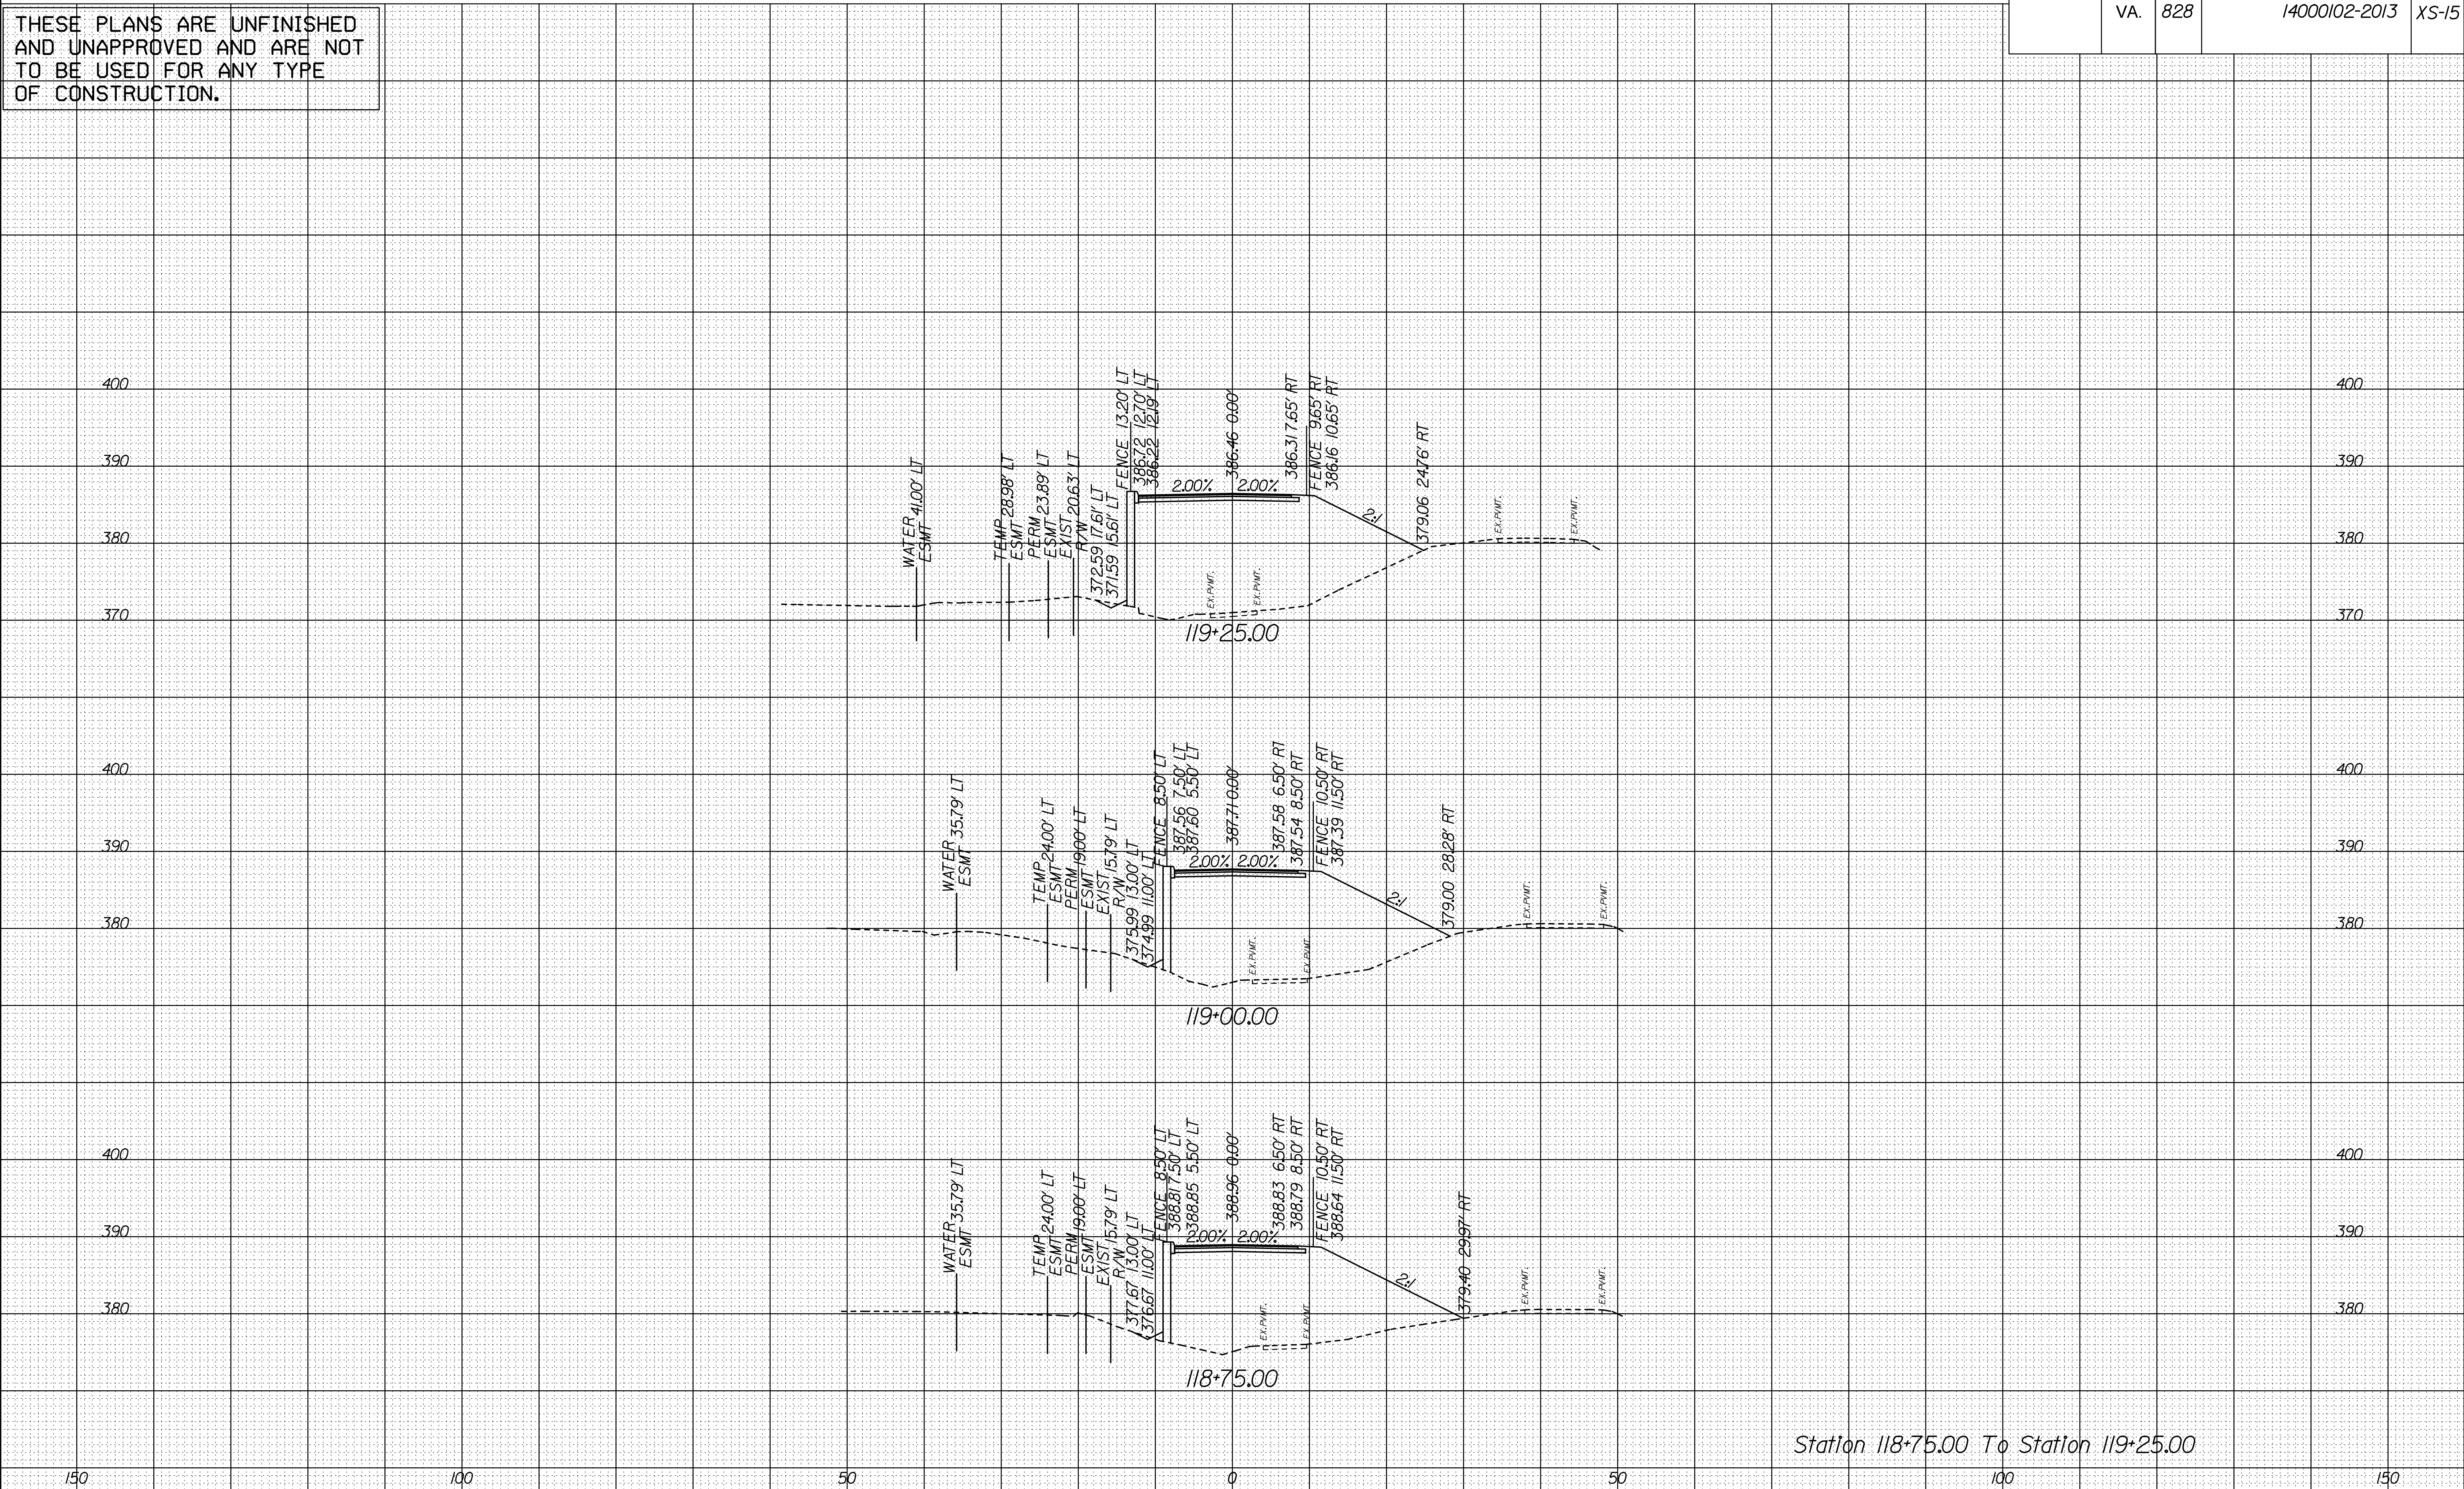
PROJECT MANAGER SCOTT RUEFNEB, P.E. 17031872-5736 ---  
SURVEYED BY, DATE FAIRFAX COUNTY, NOVEMBER 28, 2014. ---  
DESIGN BY WHITMAN, REQUARDT, & ASSOCIATES, LLP 17031293-9717  
SUBSURFACE UTILITY BY, DATE SQ DEEP, INC. 17031361-6005.

CROSS SECTIONS  
SCALE 1 IN. = 10 FT

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NECESSARY BY THE DEPARTMENT

REVISED	STATE	STATE		SHEET NO.
		ROUTE	PROJECT	
	VA.	828	14000102-2013	XS-15

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Station 118+75.00 To Station 119+25.00




PROJECT MANAGER SCOTT RUEFNEB, P.E. 17031872-5736 ---  
SURVEYED BY, DATE FAIRFAX COUNTY, NOVEMBER 28, 2014. --  
DESIGN BY WHITMAN, REQUARDT, & ASSOCIATES, LLP 17031293-9717  
SUBSURFACE UTILITY BY, DATE SQ DEEP, INC. 17031361-6005.

CROSS SECTIONS  
SCALE 1 IN. = 10 FT

DESIGN FEATURES RELATING TO CONSTRUCTION  
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REVISED	STATE	STATE		SHEET NO.
		ROUTE	PROJECT	
	VA.	828	14000102-2013	XS-16

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PROJECT MANAGER SCOTT RUFFNER, P.E. (703) 872-5736 \_ \_ \_  
SURVEYED BY, DATE FAIRFAX COUNTY, NOVEMBER 28, 2014 \_ \_  
DESIGN BY WHITMAN, REQUARDT & ASSOCIATES, LLP (703) 293-9717  
SUBSURFACE UTILITY BY, DATE SQ DEEP, INC. (703) 361-6005 \_


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SCALE 1 IN. = 10 FT

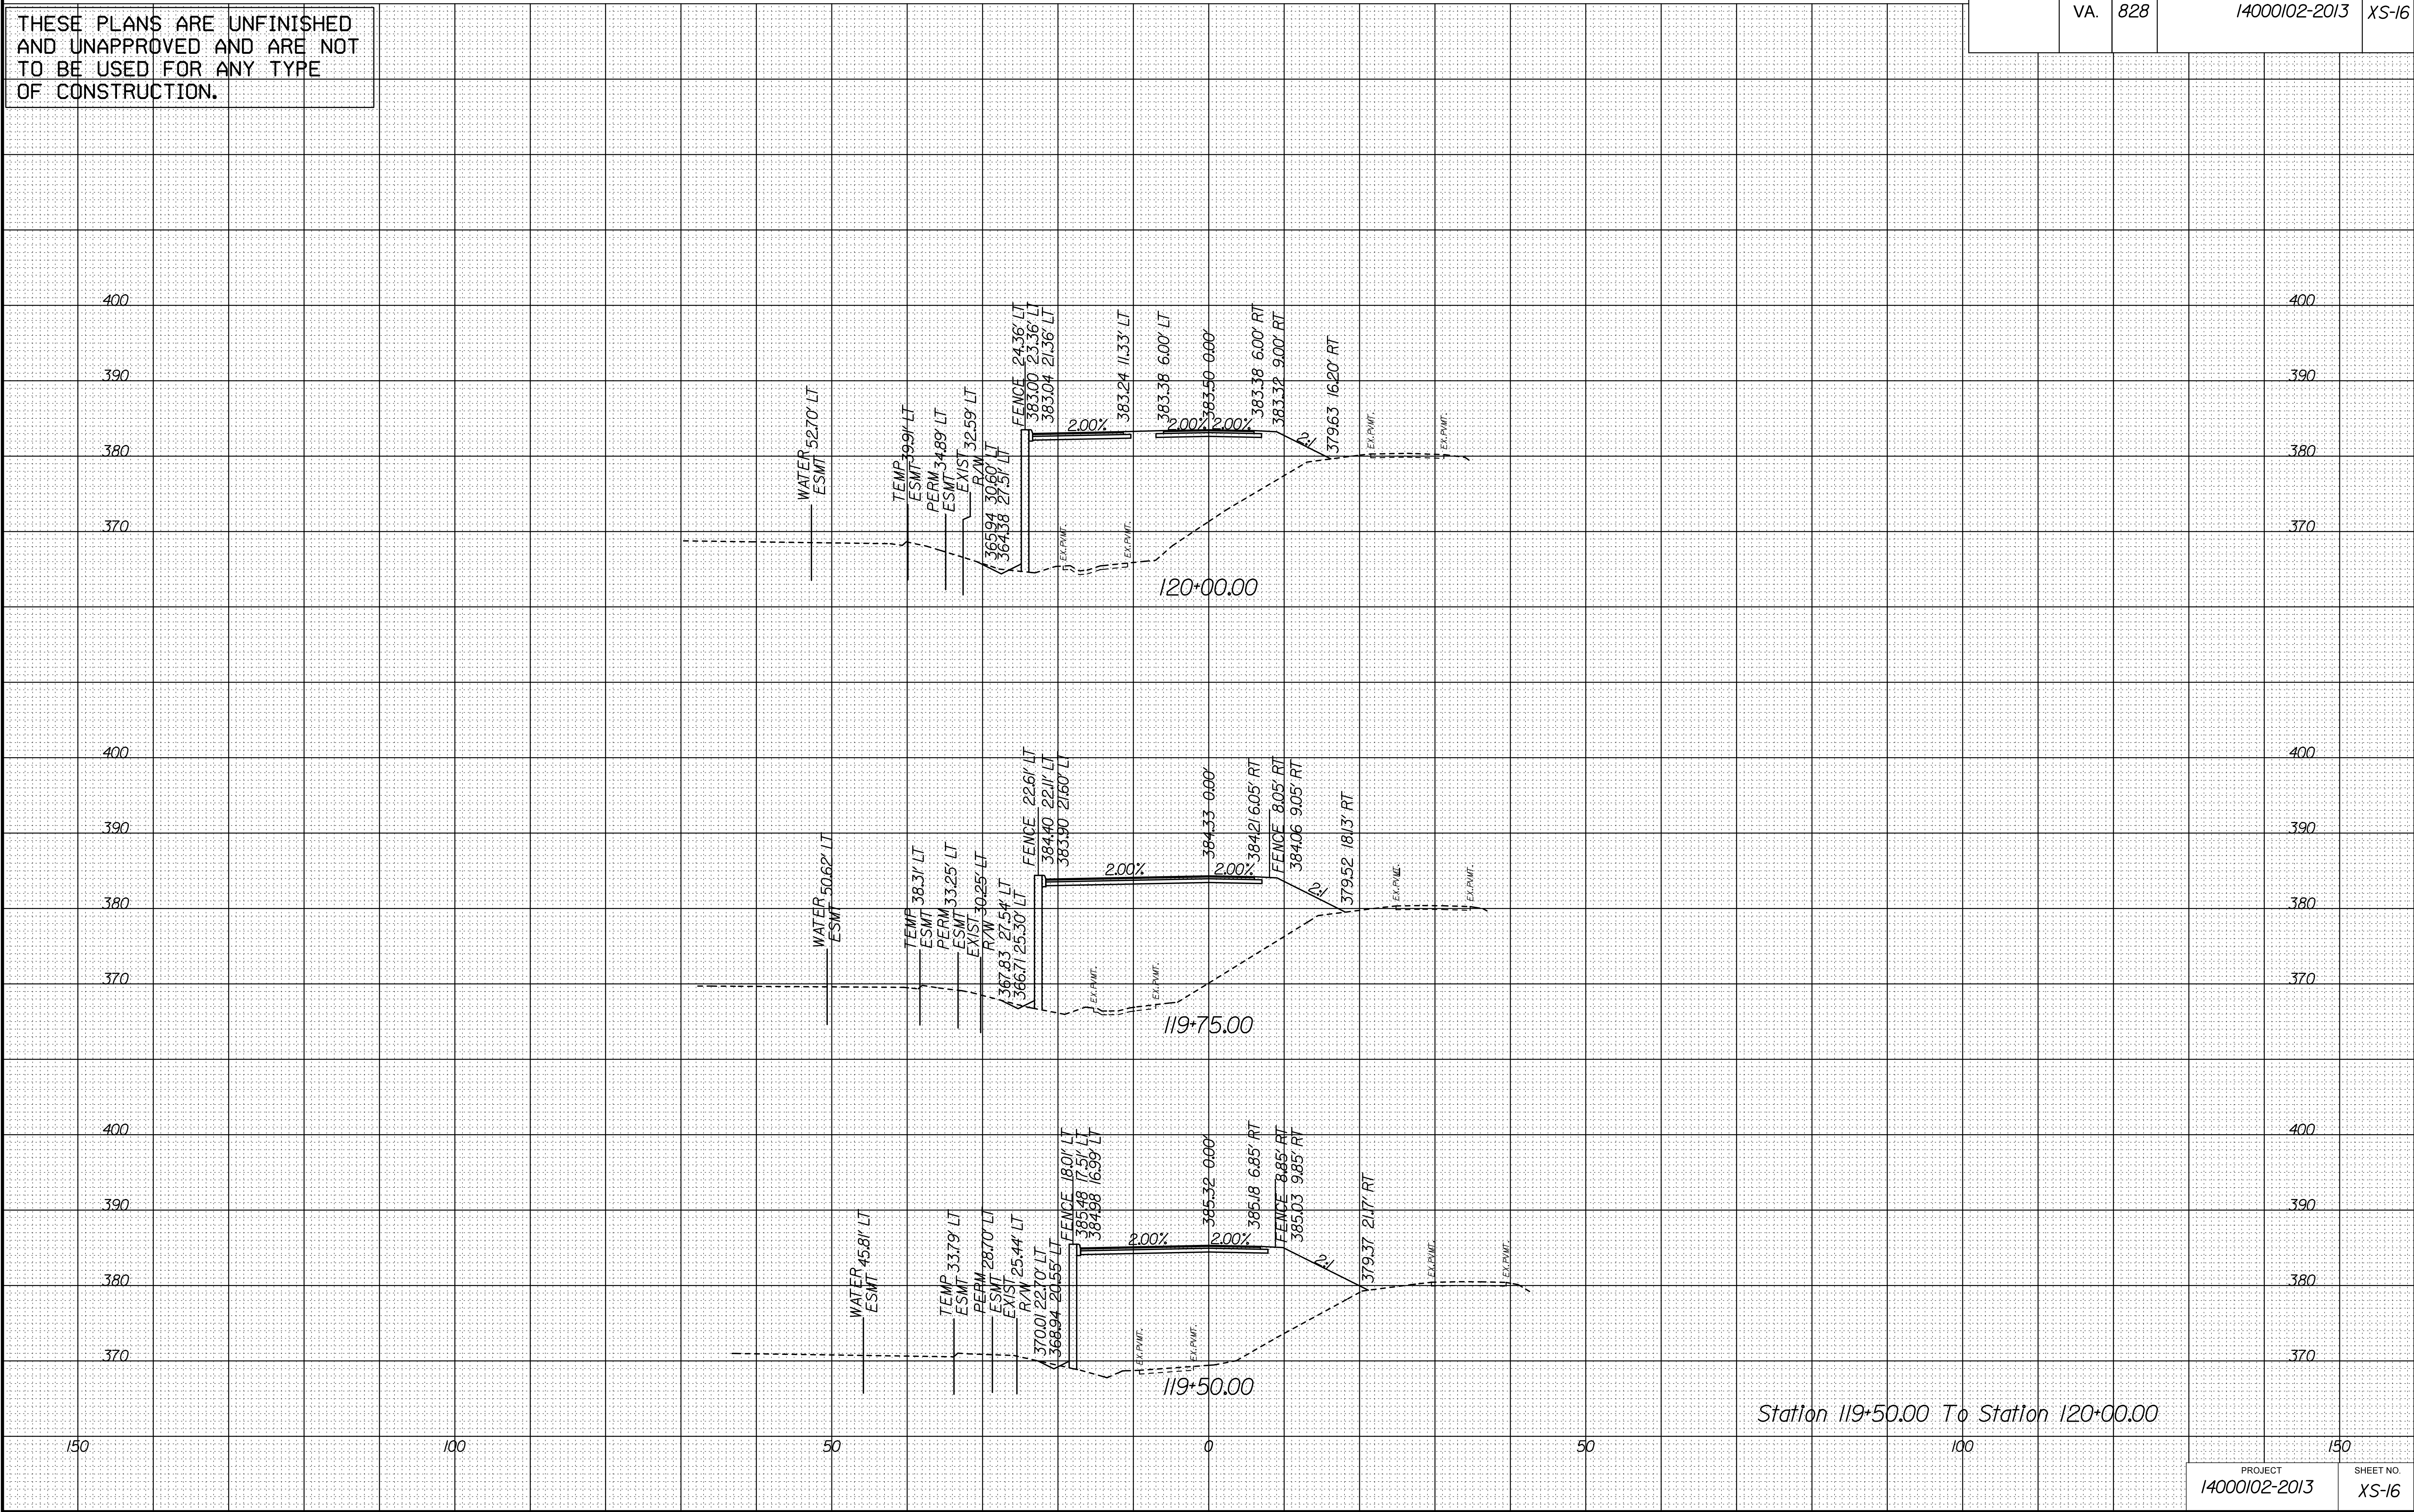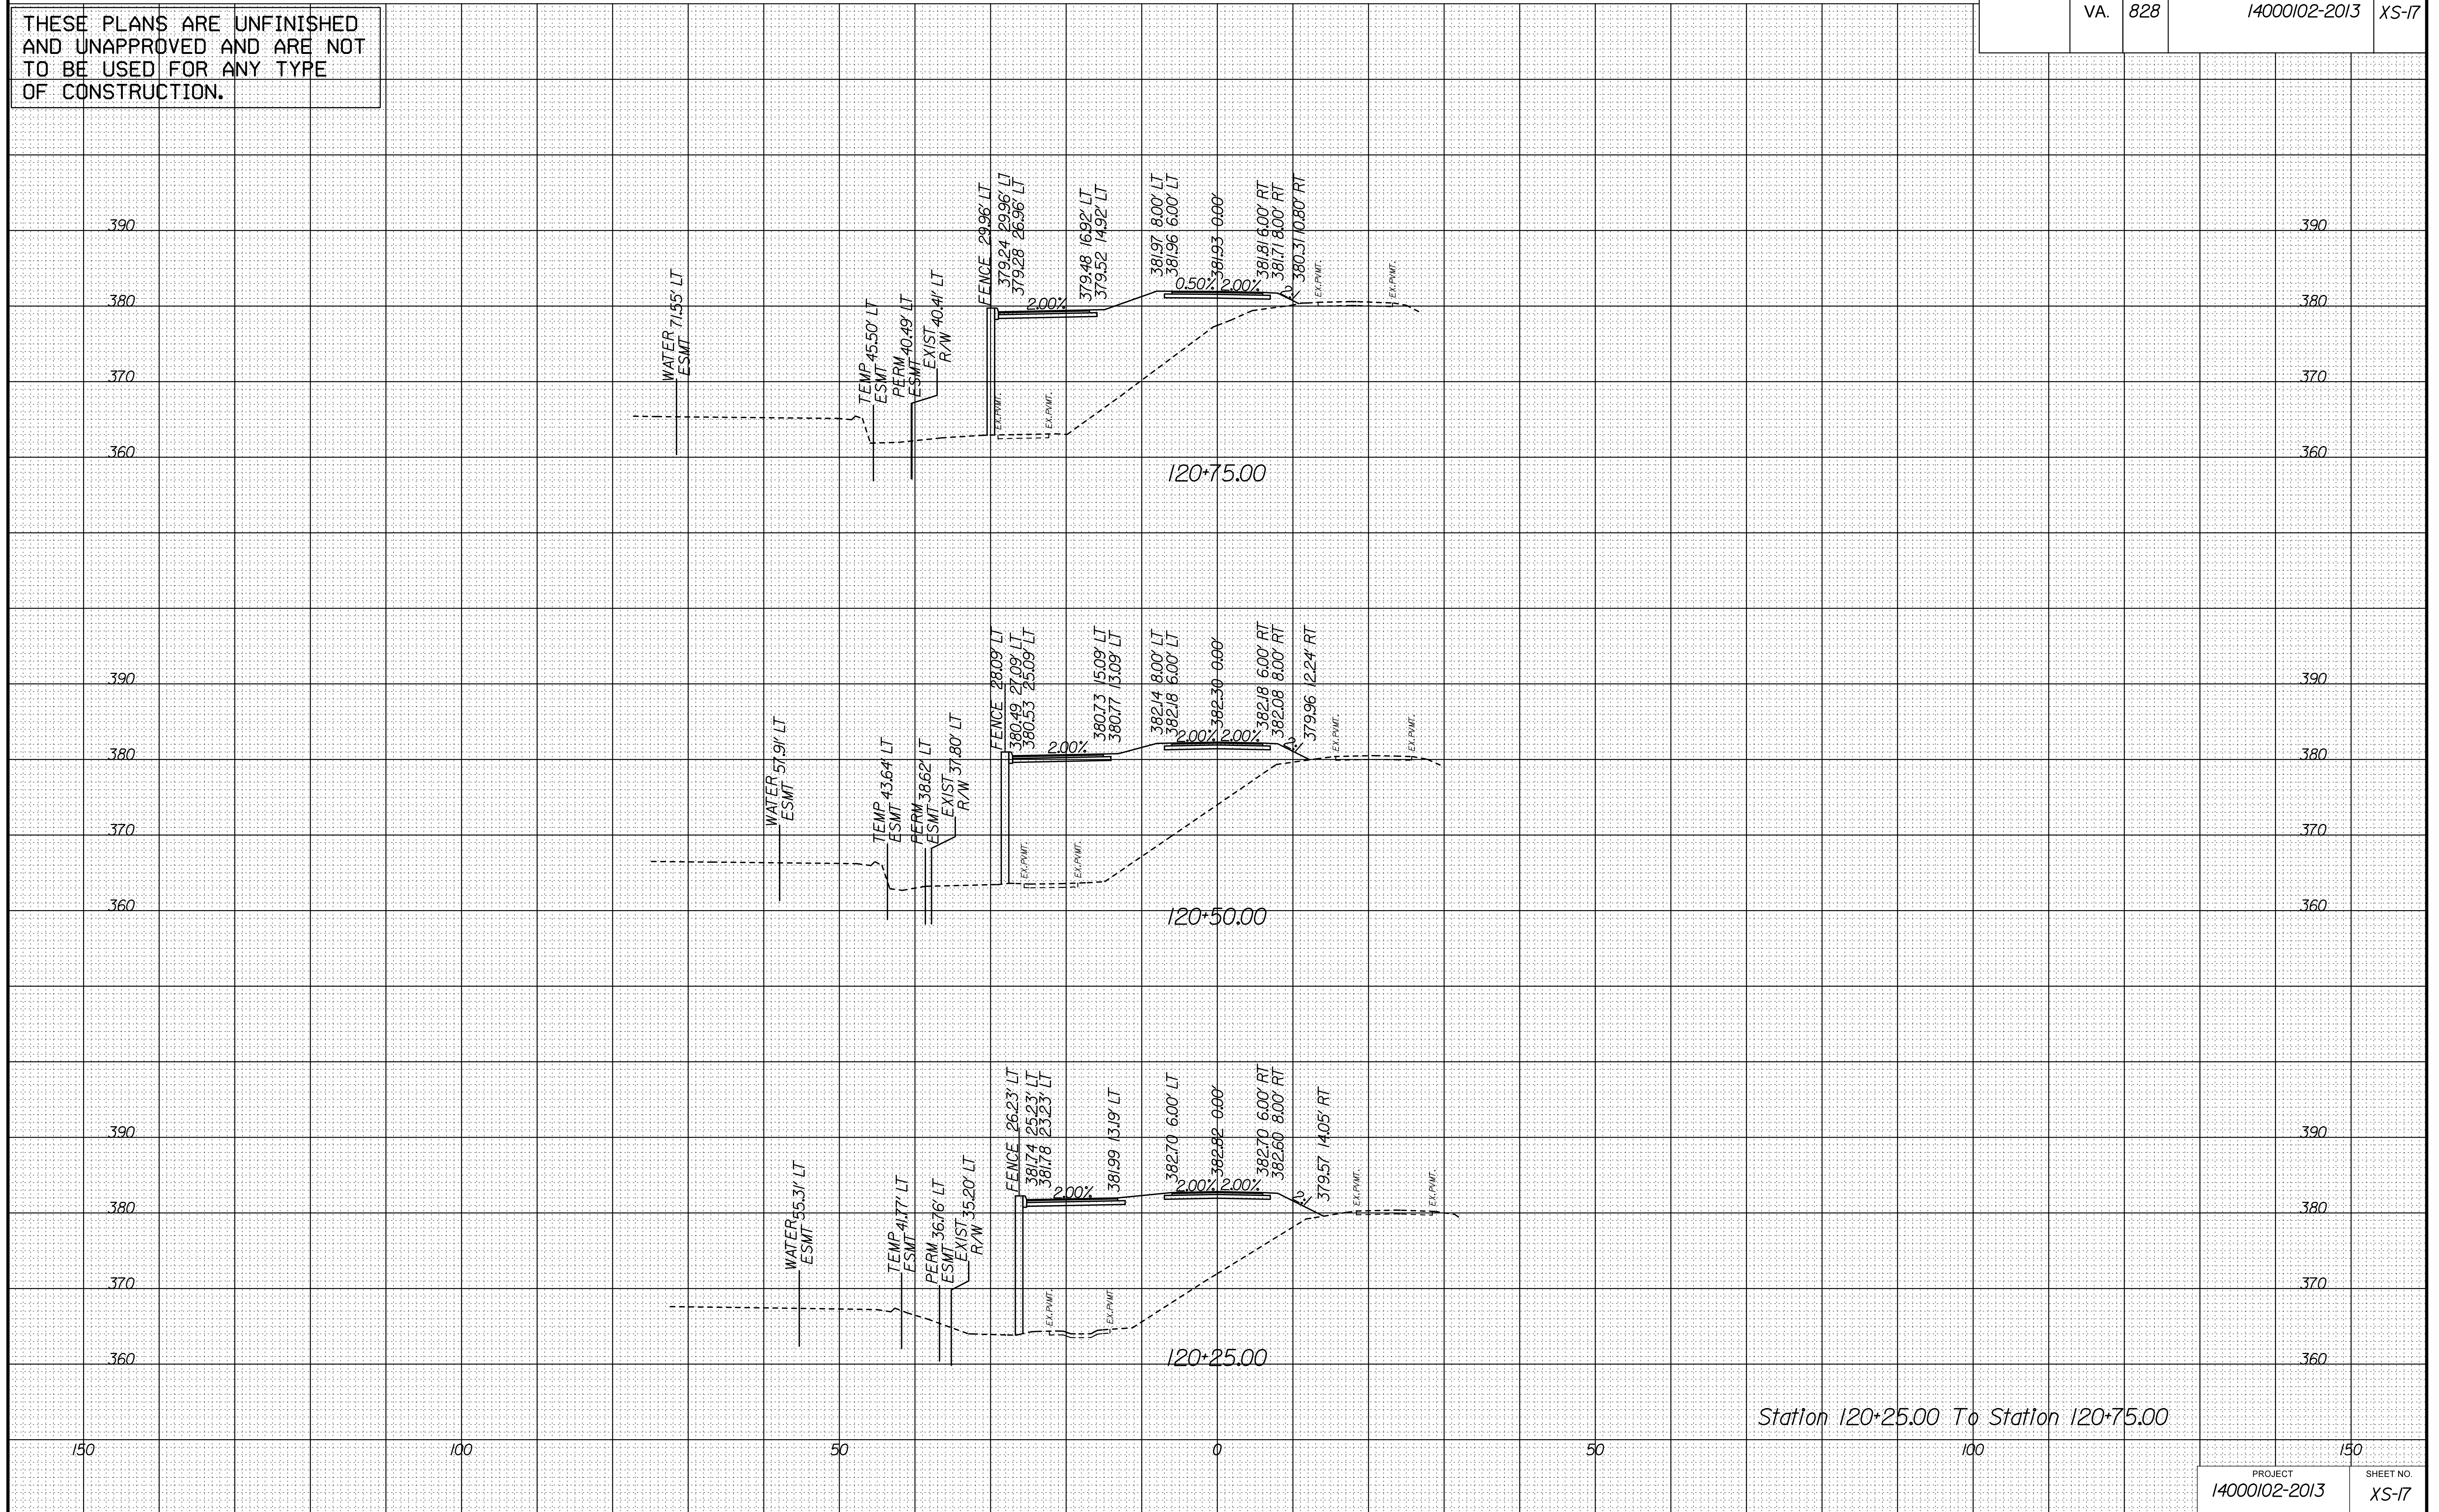DESIGN FEATURES RELATING TO CONSTRUCTION  
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N	REVISED	STATE	STATE		SHEET NO.
			ROUTE	PROJECT	
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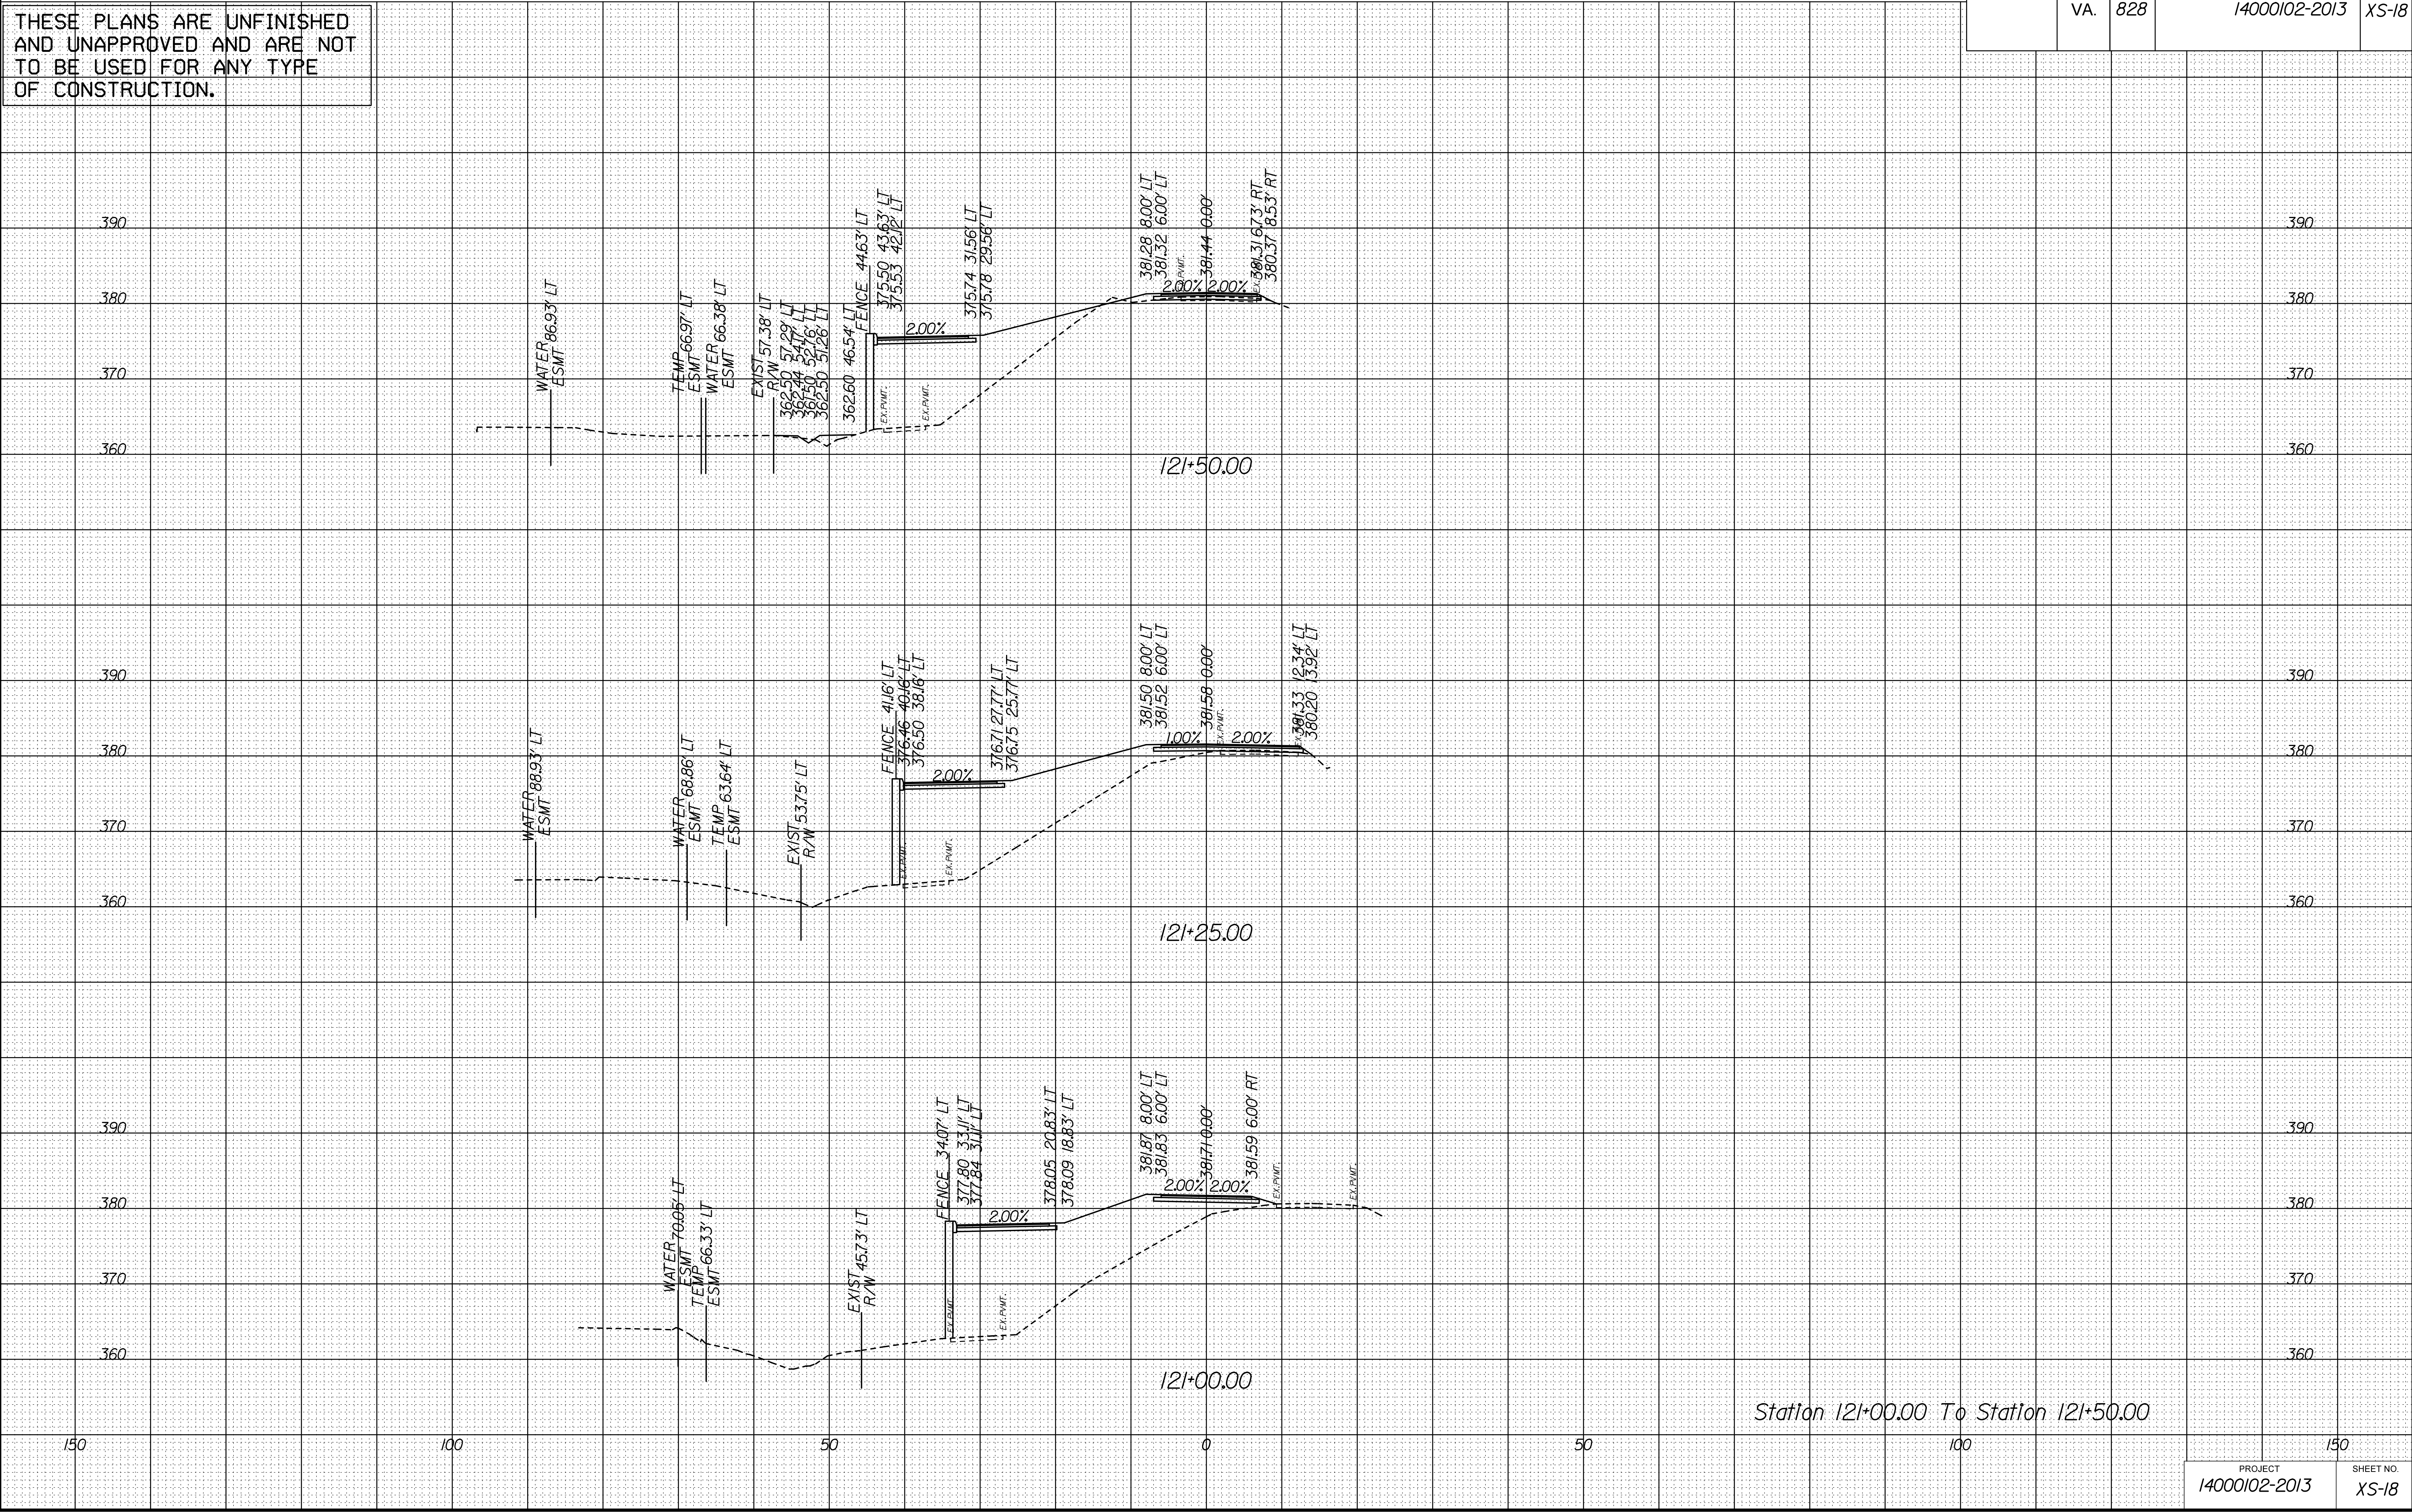
PROJECT MANAGER SCOTT RUEFNEB, P.E. 17031872-5736 ---  
SURVEYED BY, DATE FAIRFAX COUNTY, NOVEMBER 28, 2014. ---  
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CROSS SECTIONS  
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REVISED	STATE	STATE		SHEET NO.
		ROUTE	PROJECT	
	VA.	828	14000102-2013	XS-18

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PROJECT MANAGER SCOTT RUFFNER, P.E. (703) 872-5736 \_ \_ \_  
SURVEYED BY, DATE FAIRFAX COUNTY, NOVEMBER 28, 2014 \_ \_  
DESIGN BY WHITMAN, REQUARDT & ASSOCIATES, LLP (703) 293-9717  
SUBSURFACE UTILITY BY, DATE SQ DEEP, INC. (703) 361-6005 \_ \_


## CROSS SECTIONS

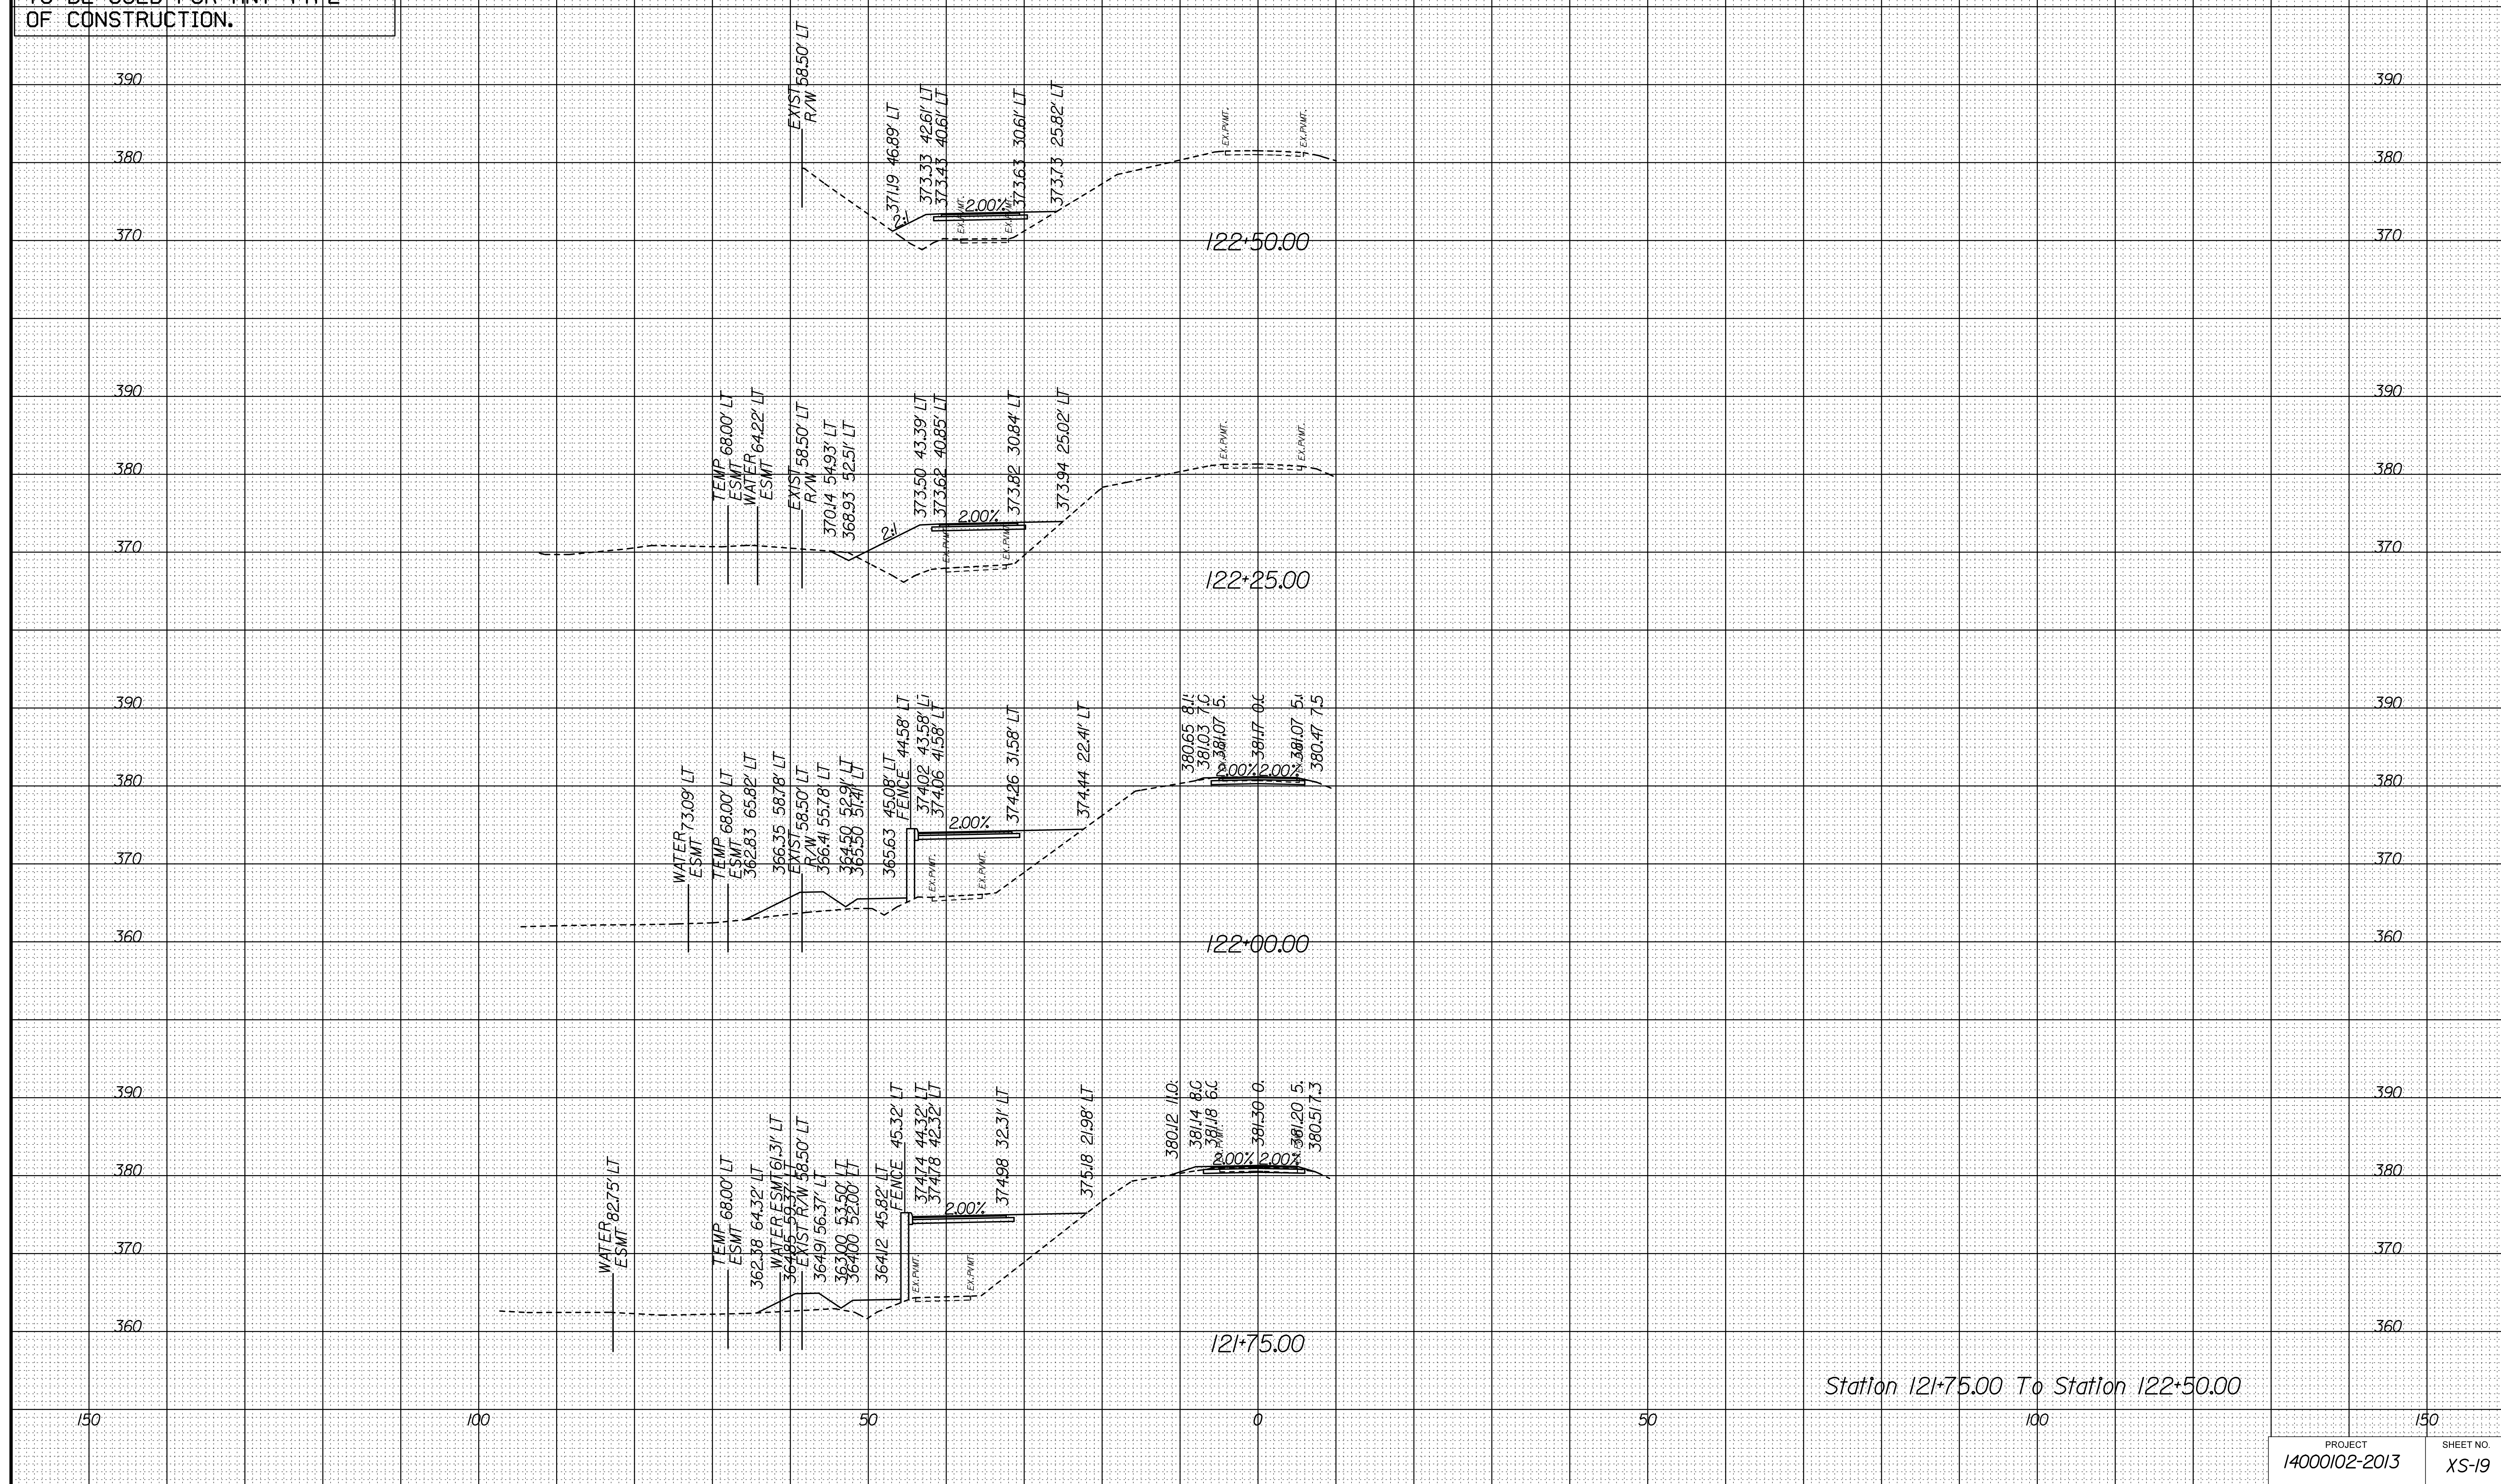SCALE 1 IN. = 10 FT

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N C	REVISED	STATE	STATE		SHEET NO.
		ROUTE	PROJECT		
		VA.	14000102-2013		

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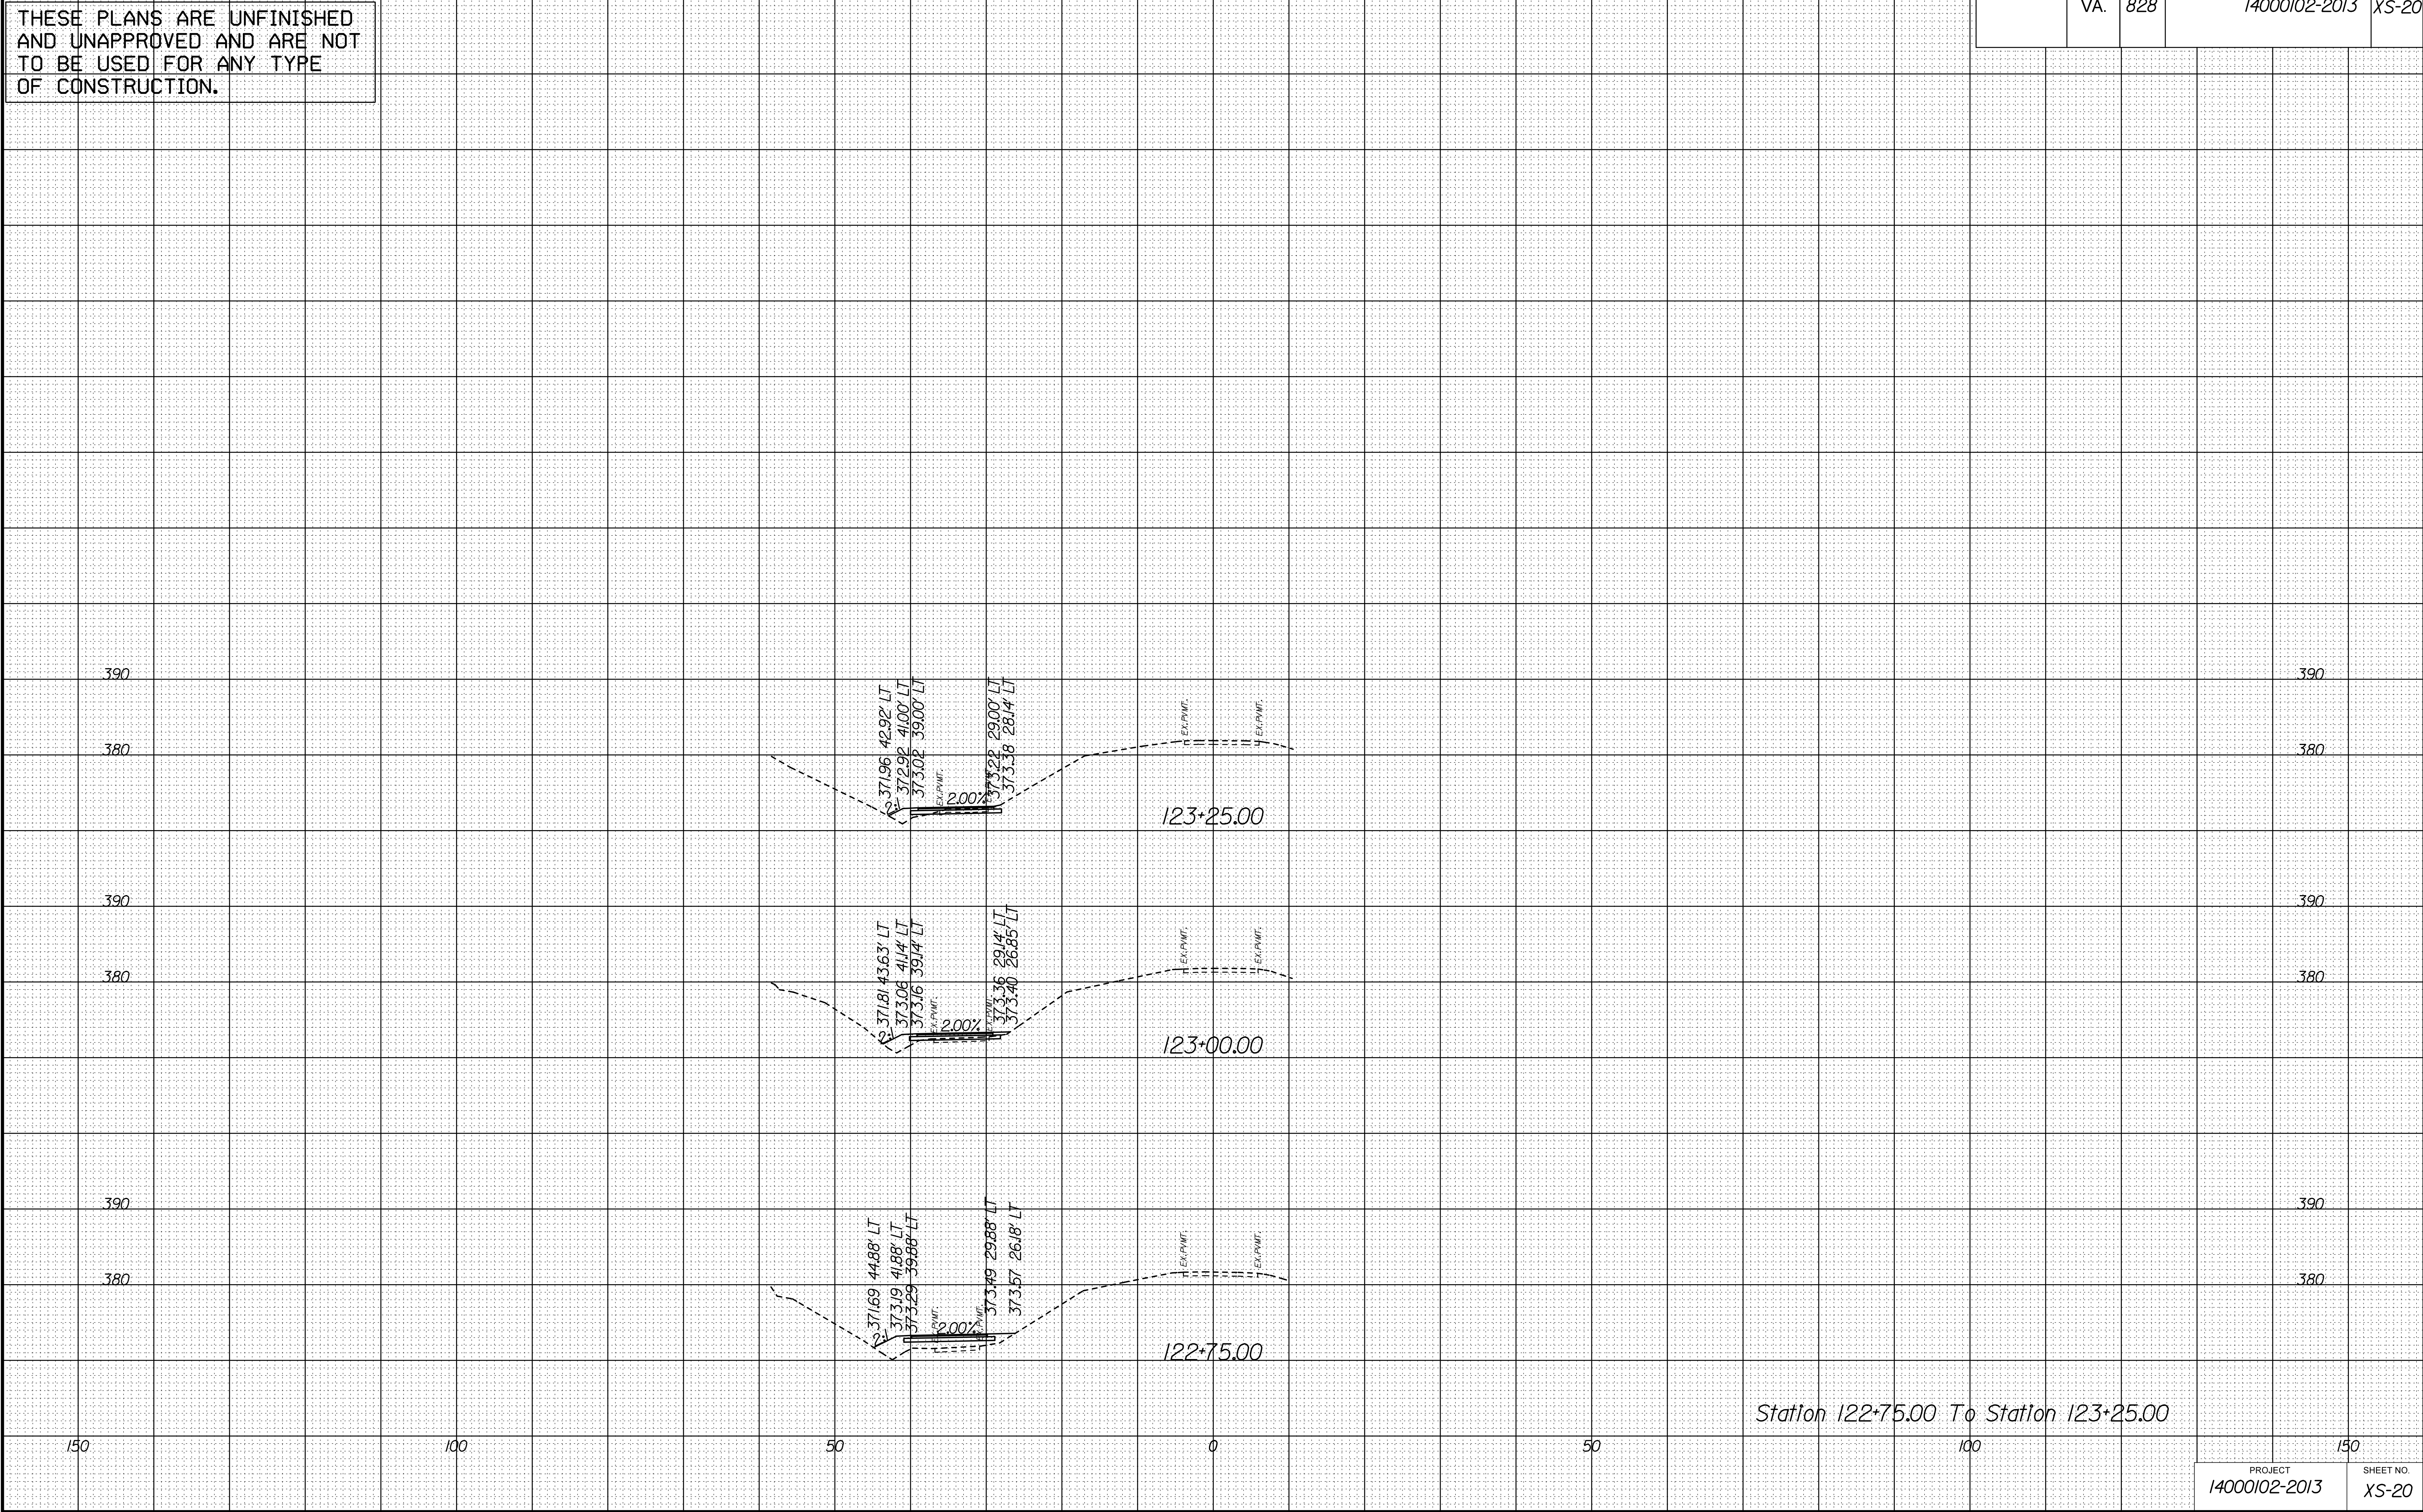
PROJECT MANAGER SCOTT RUEFNEB, P.E. 17031872-5736 ---  
SURVEYED BY, DATE FAIRFAX COUNTY, NOVEMBER 28, 2014. ---  
DESIGN BY WHITMAN, REQUARDT & ASSOCIATES, LLP 17031293-9717  
SUBSURFACE UTILITY BY, DATE SQ DEEP, INC. 17031361-6005.

CROSS SECTIONS  
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REVISED	STATE	STATE		SHEET NO.
		ROUTE	PROJECT	
	VA.	828	14000102-2013	XS-20

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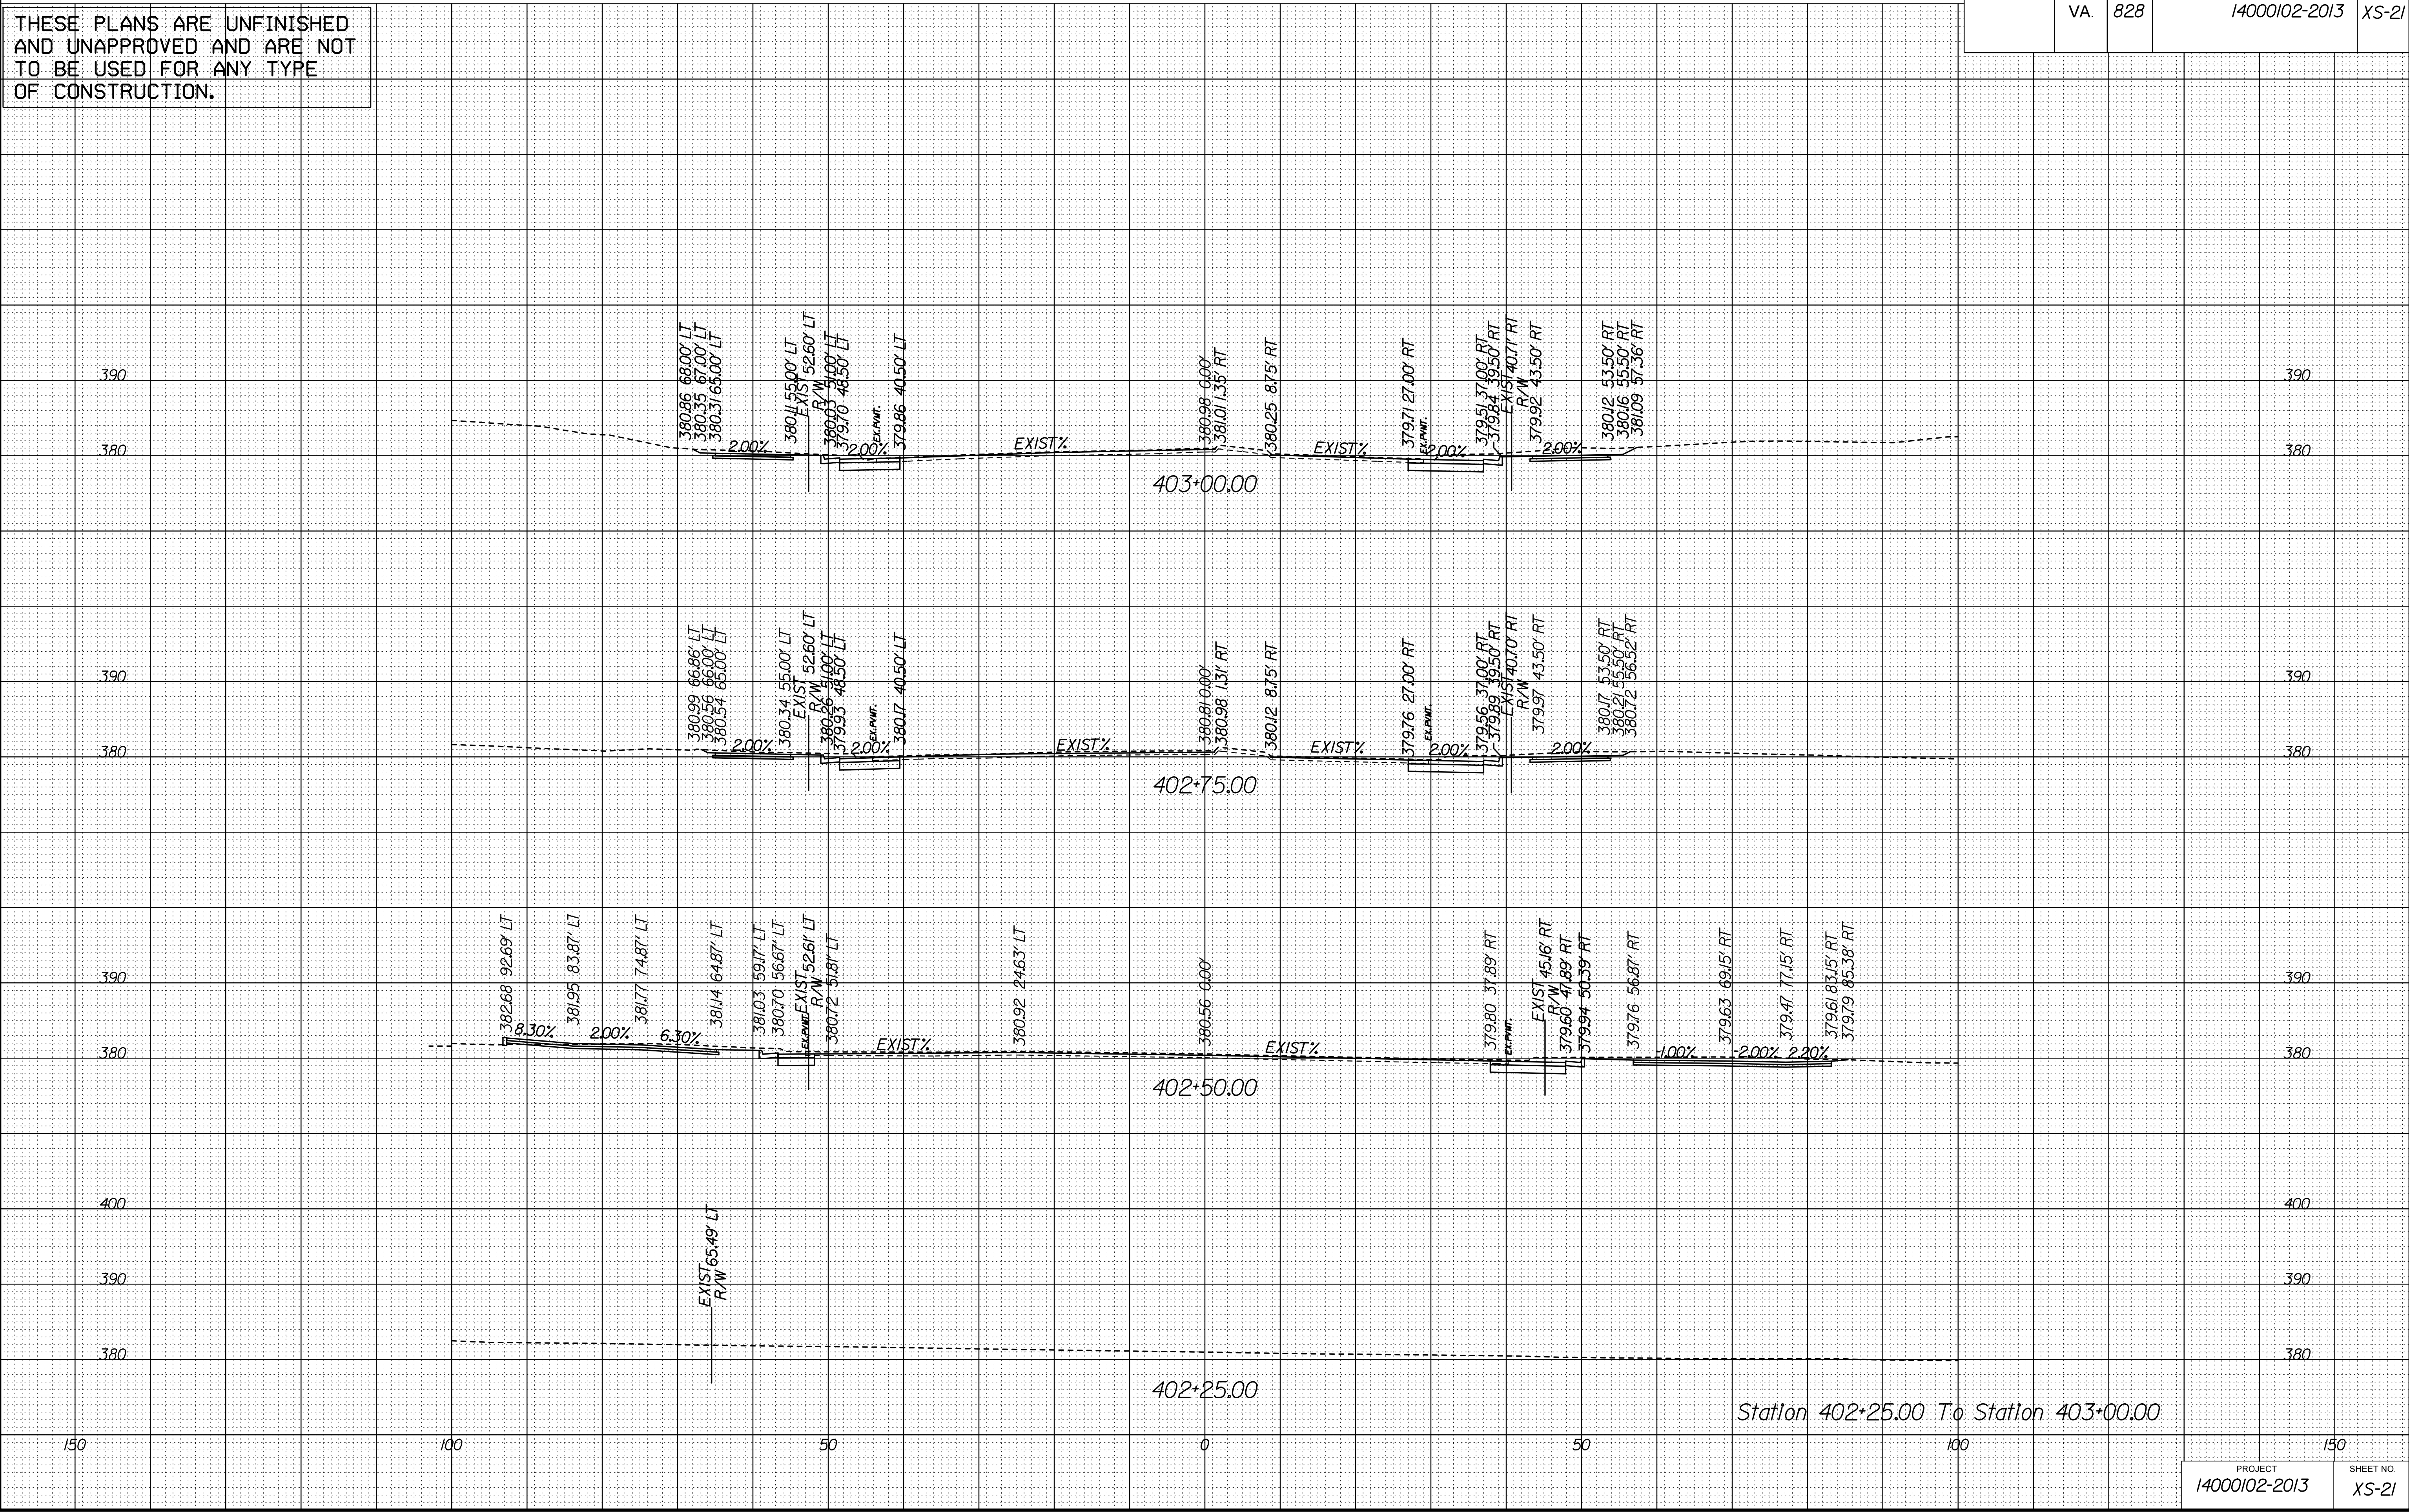
PROJECT MANAGER SCOTT RUEFNEB, P.E. 17031872-5736 ---  
SURVEYED BY, DATE FAIRFAX COUNTY, NOVEMBER 28, 2014. ---  
DESIGN BY WHITMAN, REQUARDT, & ASSOCIATES, LLP 17031293-9717  
SUBSURFACE UTILITY BY, DATE SQ DEEP, INC. 17031361-6005.

CROSS SECTIONS  
SCALE 1 IN. = 10 FT

DESIGN FEATURES RELATING TO CONSTRUCTION  
OR TO REGULATION AND CONTROL OF TRAFFIC  
MAY BE SUBJECT TO CHANGE AS DEEMED  
NECESSARY BY THE DEPARTMENT

REVISED	STATE	STATE		SHEET NO.
		ROUTE	PROJECT	
	VA.	828	14000102-2013	XS-21

THESE PLANS ARE UNFINISHED  
AND UNAPPROVED AND ARE NOT  
TO BE USED FOR ANY TYPE  
OF CONSTRUCTION.






PROJECT MANAGER SCOTT RUEFNEB, P.E. 17031872-5736 ---  
SURVEYED BY, DATE FAIRFAX COUNTY, NOVEMBER 28, 2014. ---  
DESIGN BY WHITMAN, REQUARDT, & ASSOCIATES, LLP 17031293-9717  
SUBSURFACE UTILITY BY, DATE SQ DEEP, INC. 17031361-6005.

CROSS SECTIONS  
SCALE 1 IN. = 10 FT

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REVISED	STATE	STATE		SHEET NO.
		ROUTE	PROJECT	
	VA.	828	14000102-2013	XS-22

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PROJECT MANAGER SCOTT RUEFNER, P.E. (703) 877-5736 \_ \_ \_  
SURVEYED BY, DATE FAIRFAX COUNTY, NOVEMBER 28, 2014 \_ \_  
DESIGN BY WHITMAN, REQUARDT & ASSOCIATES, LLP (703) 293-9717  
SUBSURFACE UTILITY BY, DATE SQ DEEP, INC. (703) 361-6005 \_


## CROSS SECTIONS

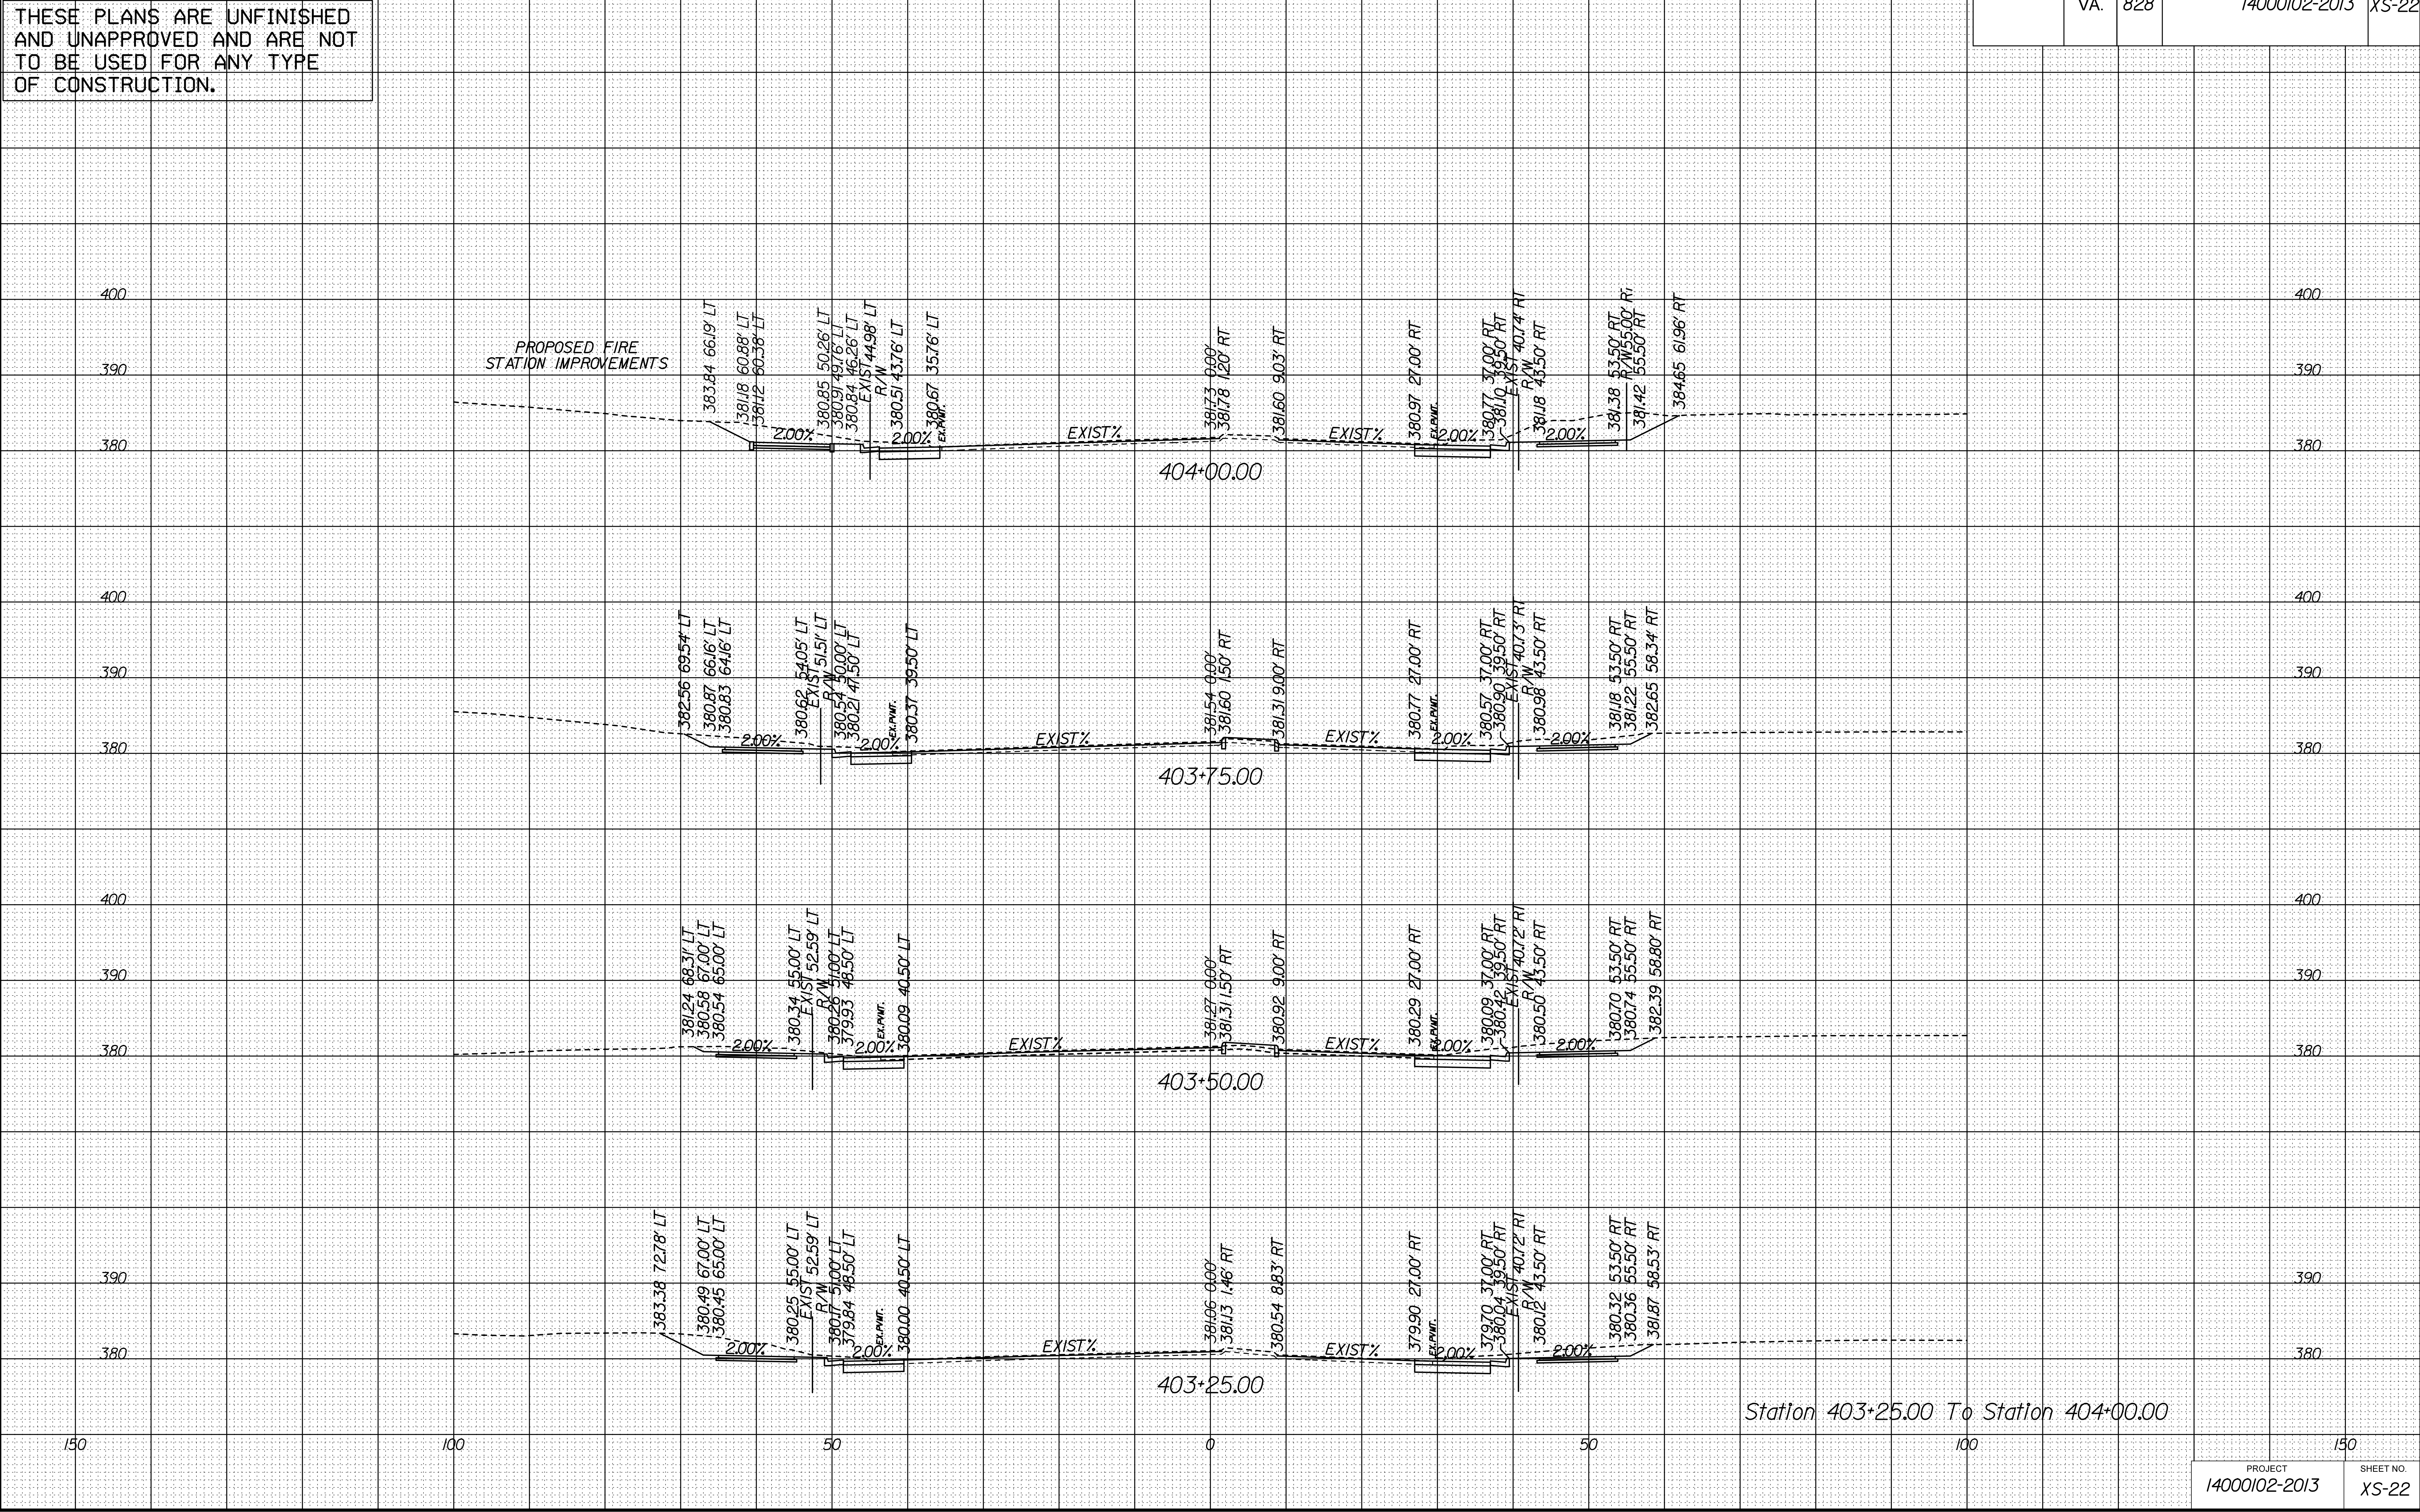SCALE 1 IN. = 10 FT

DESIGN FEATURES RELATING TO CONSTRUCTION  
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NECESSARY BY THE DEPARTMENT

REVISED	STATE	STATE		SHEET NO.
		ROUTE	PROJECT	
	VA.	828	14000102-2013	XS-23

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PROJECT MANAGER SCOTT RUFFNER, P.E. (703) 877-5736 \_ \_ \_  
SURVEYED BY, DATE FAIRFAX COUNTY, NOVEMBER 28, 2014 \_ \_  
DESIGN BY WHITMAN, REQUARDT & ASSOCIATES, LLP (703) 293-9717  
SUBSURFACE UTILITY BY, DATE SQ DEEP, INC. (703) 361-6005 \_ \_

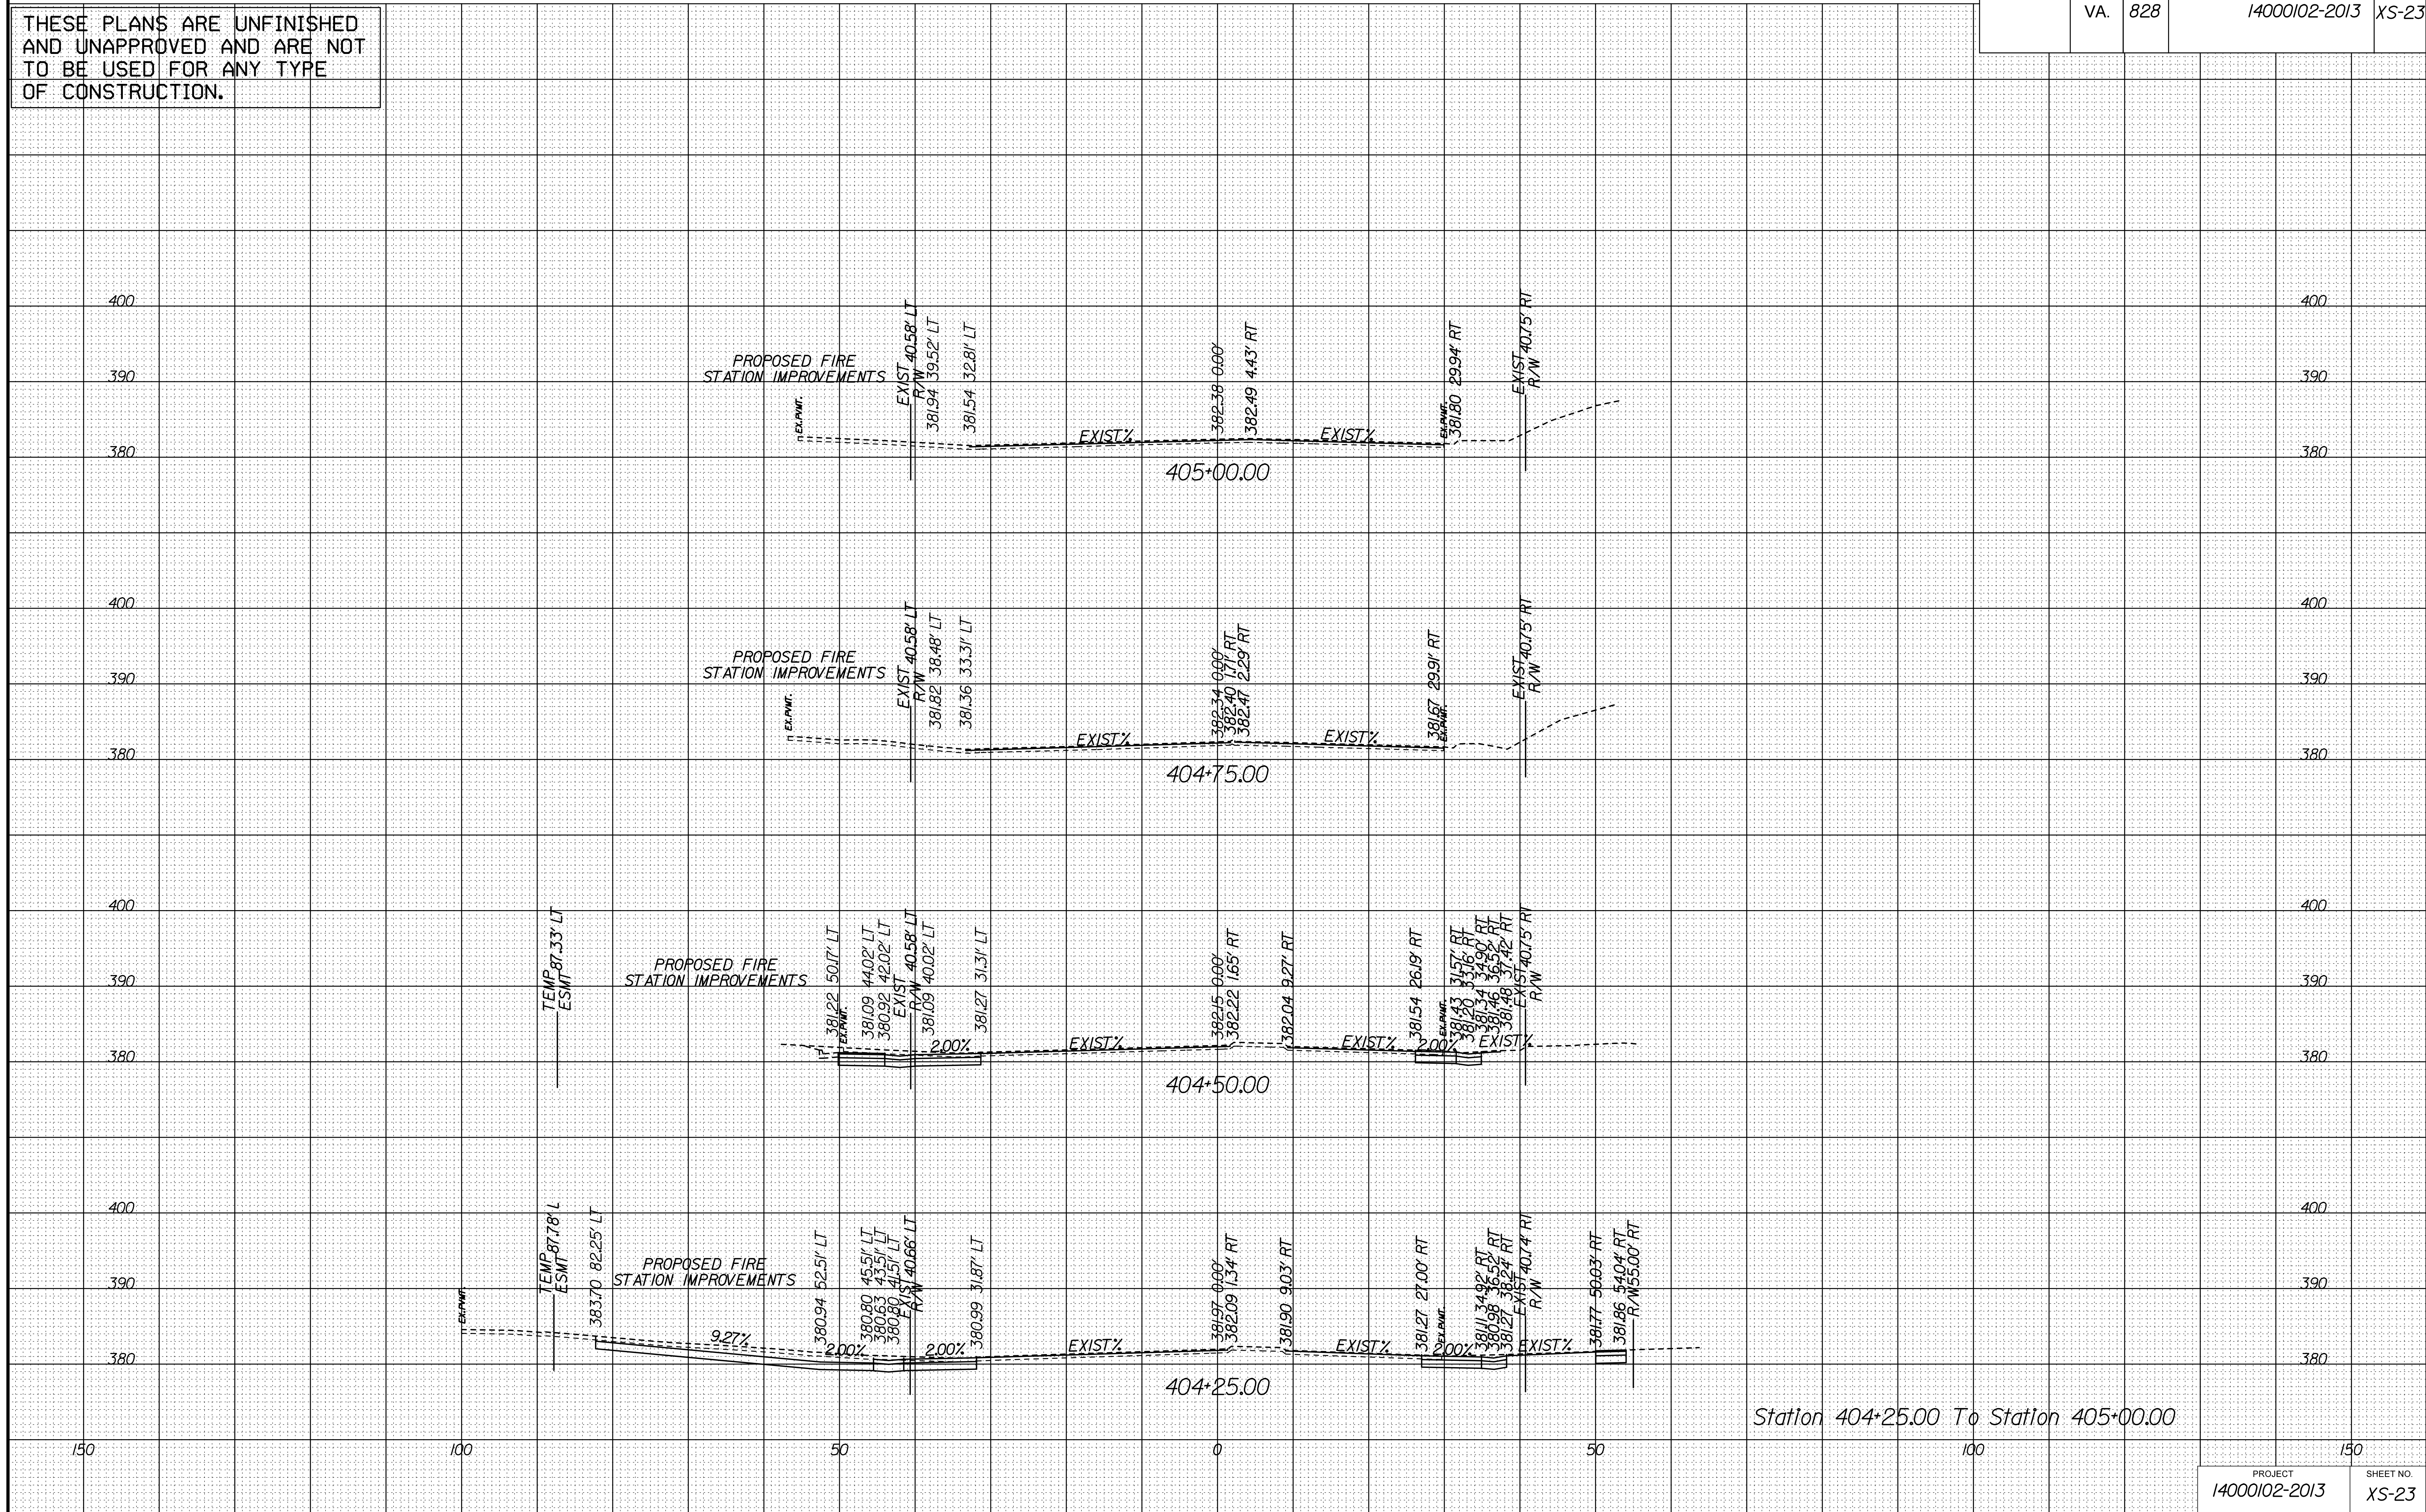
## CROSS SECTIONS

SCALE 1 IN. = 10 FT

DESIGN FEATURES RELATING TO CONSTRUCTION  
OR TO REGULATION AND CONTROL OF TRAFFIC  
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NECESSARY BY THE DEPARTMENT

IN C	REVISED	STATE	STATE		SHEET NO.
			ROUTE	PROJECT	
		VA.	828	14000102-2013	XS-24
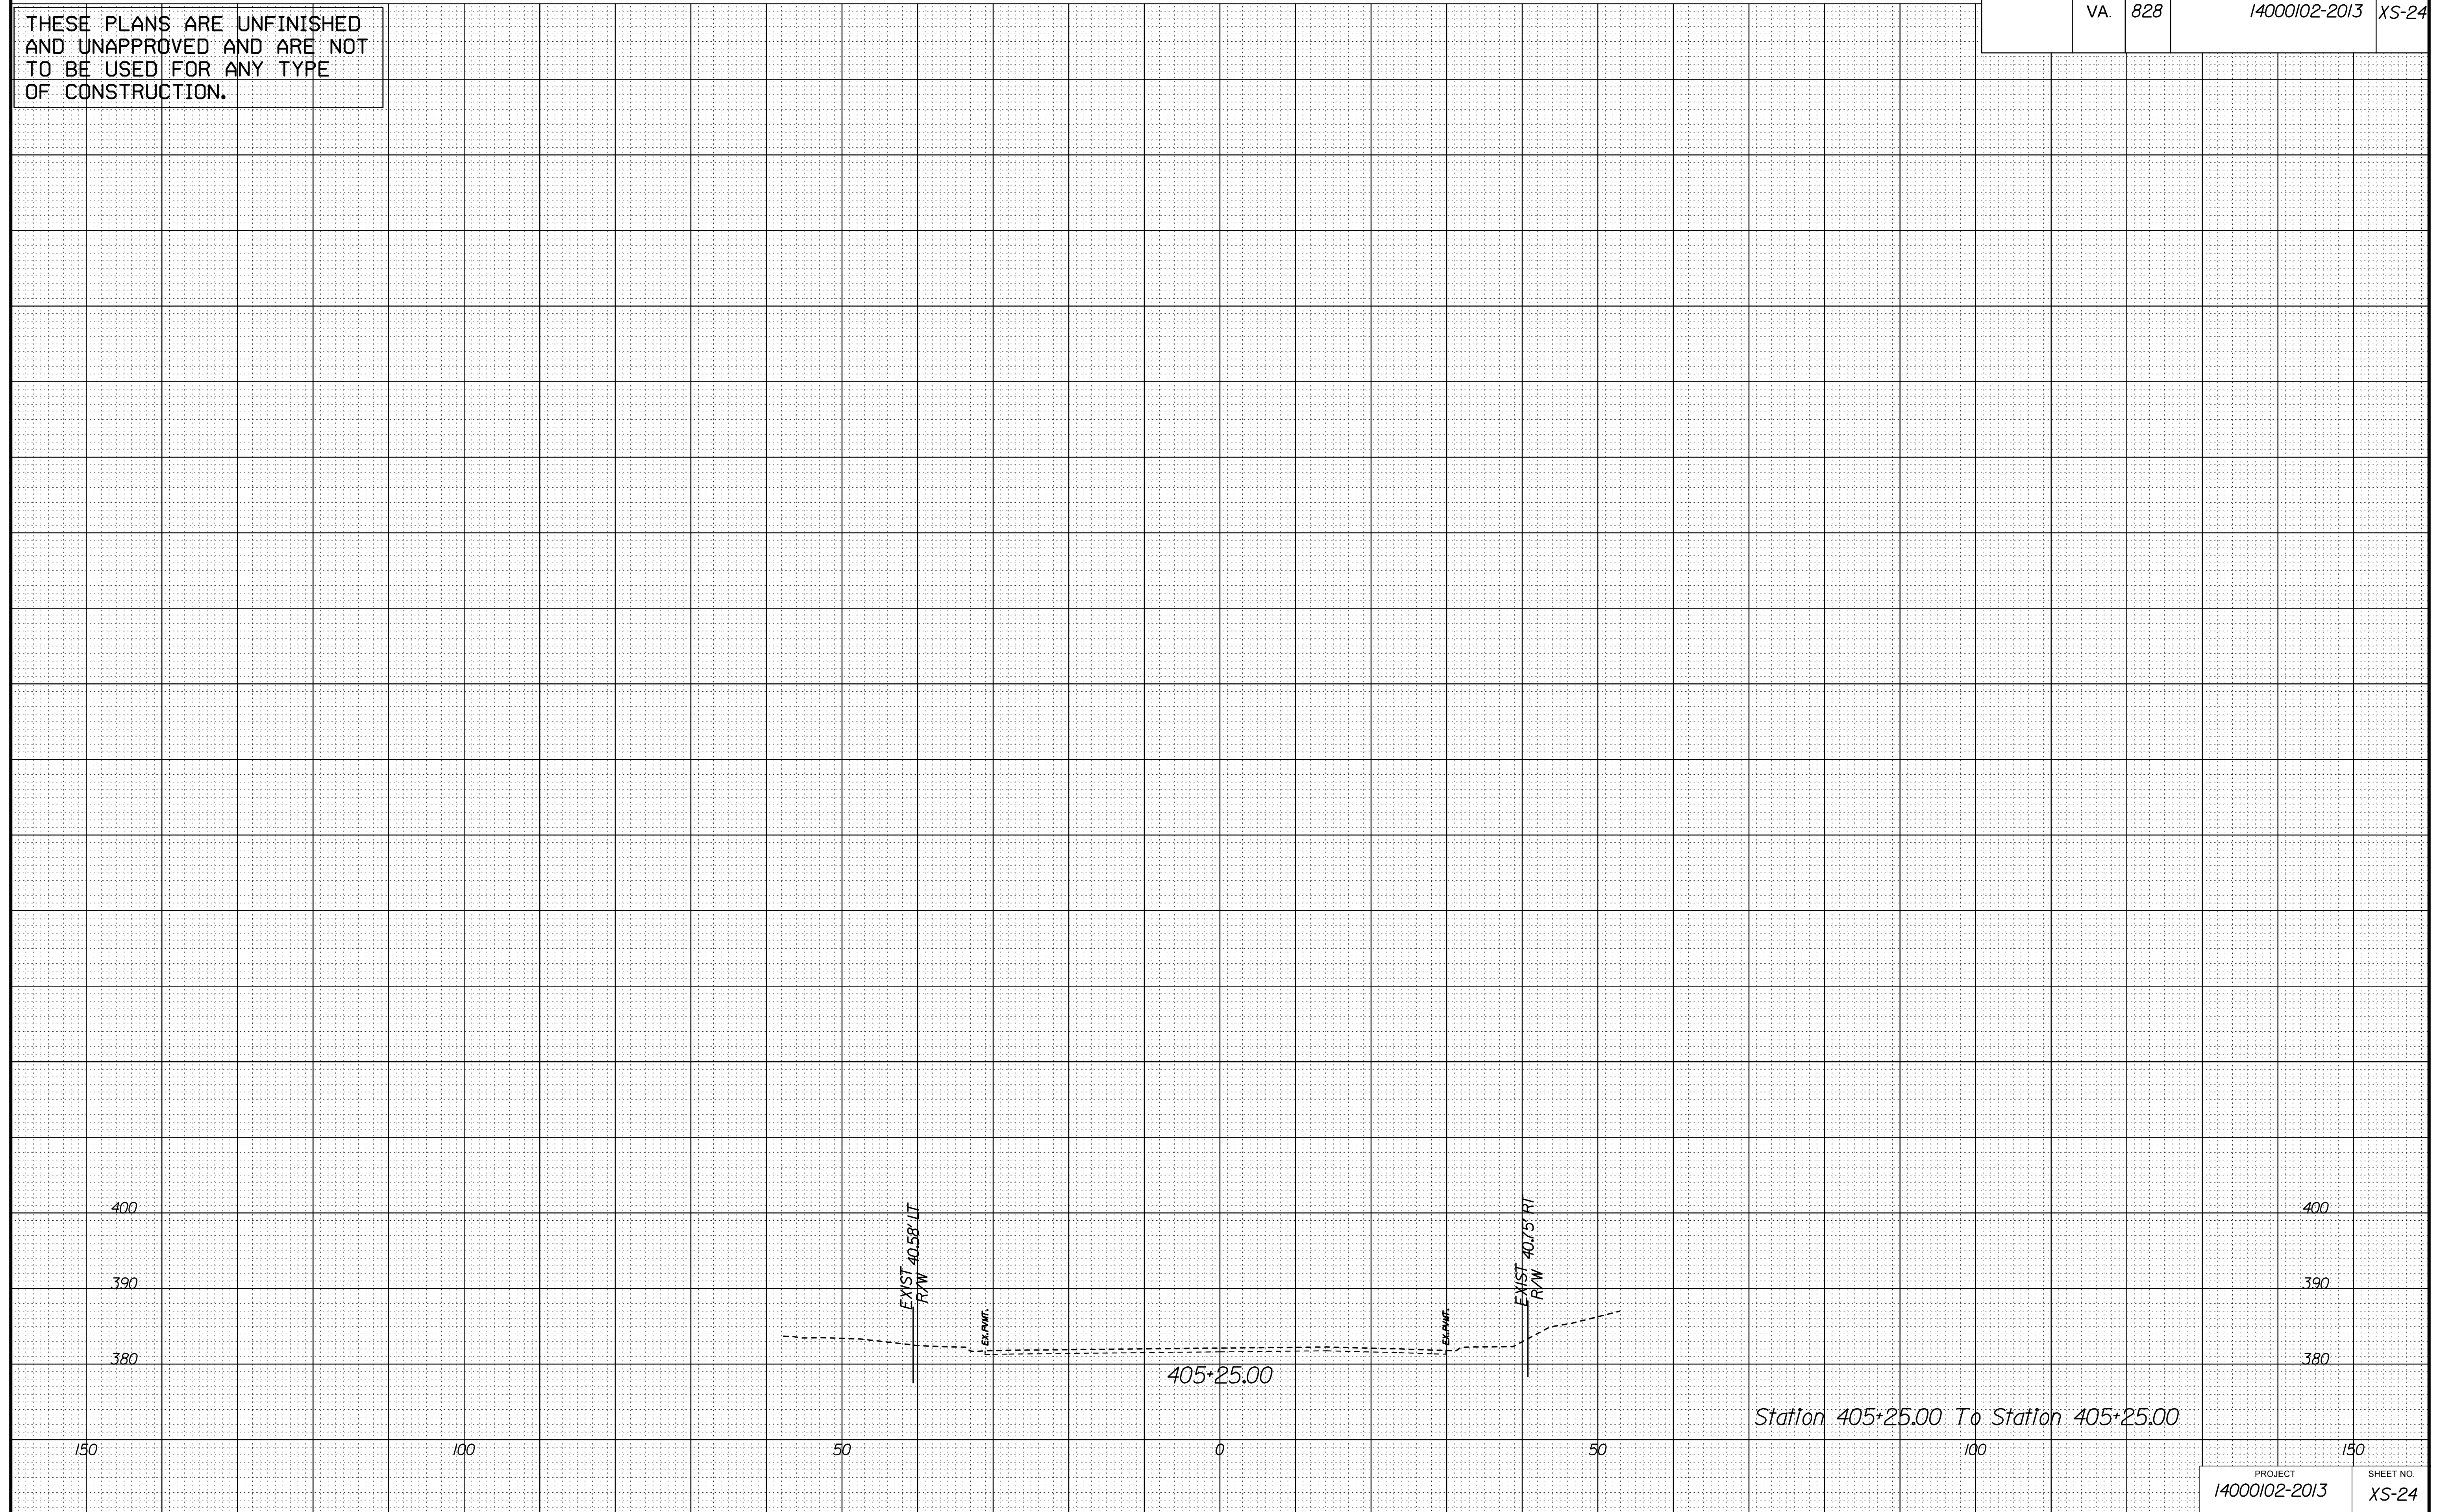
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5/29/2018